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# **BOULDER WESTERN CITY CAMPUS**

VOLUME 1: NORTH O ALPINE (PAVILION)	F SITE REVIEW WITH FORM BASED CODE OVERLAY	SITE REVIEW VOLUME 1	FBC REVIEW VOLUME 1	VOLUME 2: SOUTH OF ALPINE (PARKING GARAGE)	SITE REVIEW	VOLUME 2 SITE REVIEW
GENERAL				CIVIL		
1-G0.00	COVER SHEET & DRAWING INDEX - SITE REVIEW	Х		2-C0.01	CIVIL NOTES AND SPECIFICATIONS	X
1-G0.01	VICINITY MAP, DIRECTORY, & PROJECT INFORMATION	Х		2-C1.00	CIVIL DEMO PLAN - SOUTH	X
1-G0.02	OVERALL SITE PLAN - SITE REVIEW	Х		2-C2.00	CIVIL SITE PLAN - SOUTH	Х
1-G0.03	PHASING PLAN	Х		2-C3.00	UTILITY PLAN - SOUTH	X
1-G0.04	DEDICATIONS EXHIBIT	Х		2-C4.00	GRADING PLAN - SOUTH	X
CIVIL				LANDSCAPE	1	
1-C0.01	CIVIL NOTES AND SPECIFICATIONS	X			OVERALL SITE PLAN - SITE REVIEW	X
1-C1.00	CIVIL DEMO PLAN - NORTH	X		2-L0.10	SITE REVIEW - LANDSCAPE COMPLIANCE	X
1-C2.00	CIVIL SITE PLAN - NORTH	X		2-L2.10	3D VIEWS - SOUTH PASEO	X
1-C3.00	UTILITY PLAN - NORTH	X		2-L4.00	TREE PROTECTION AND REMOVALS	X
1-C4.00	GRADING PLAN - NORTH	Х		2-L4.01	PLANT SCHEDULE	X
		X		2-L4.02		X
1-L0.00	LANDSCAPE SITE PLAN - SITE REVIEW	X		2-L4.10	PLANTING DETAILS	X
1-L0.10		X	V	ARCHITECTURAL		× ×
1-L0.20	FBC COMPLIANCE - PASEO	X	X	2-A1.01	ARCHITECTURAL SITE PLAN	X
1-L0.21		X	X	2-A1.02	SOLAR ACCESS PLANS	X
1-L0.22	FBC COMPLIANCE - SITE IMPERVIOUS COVERAGE	X	Х	2-A1.11	SITE DETAILS	X
1-L0.30 1-L1.40		X X		2-A1.22 2-A2.01	PARKING DIAGRAMS LEVEL B2 FLOOR PLAN	X X
1-L1.40 1-L1.41	LEVEL 4 TERRACE LANDSCAPES WATER FEATURE	X		2-A2.01 2-A2.02	LEVEL B2 FLOOR PLAN	X X
1-L2.20 1-L2.21	3D VIEWS - PLAZA 3D VIEWS - ENTRIES	X X		2-A2.03 2-A2.04	LEVEL 1 FLOOR PLAN LEVEL 2 FLOOR PLAN	X X
1-L2.21 1-L4.00	TREE PROTECTION AND REMOVALS	X		2-A2.04 2-A2.05	LEVEL 3 FLOOR PLAN	
1-L4.00 1-L4.01	PLANT SCHEDULE AND NOTES	X		2-A2.05 2-A2.06	LEVEL 3 FLOOR PLAN	X X
1-L4.01 1-L4.02	LANDSCAPE PLAN	X		2-A2.00 2-A2.07	ROOF PLAN	<u> </u>
1-L4.10	PLANTING DETAILS	X		2-A2.07 2-A4.01	BUILDING ELEVATIONS	<u>х</u>
ARCHITECTURAL	FLANTING DE TAILS	Λ		2-A4.01 2-A4.02	BUILDING ELEVATIONS	V
1-A0.00	PAVILION - FORM BASED CODE - ARCHITECTURAL SITE PLAN	X	X	2-A4.02 2-A4.03	COLOR ELEVATIONS	X X
1-A0.01A	PAVILION - FORM BASED CODE - ANOTH ELEVATION	X	X	2-A4.03	COLOR ELEVATIONS	X X
1-A0.01B	PAVILION - FORM BASED CODE - NORTH ELEVATION	X	X	LIGHTING		
1-A0.01C	PAVILION - FORM BASED CODE - EAST ELEVATION	X	X	2-SP1.01	SITE PHOTOMETRIC PLAN - SOUTH	Х
1-A0.01D	PAVILION - FORM BASED CODE - WEST ELEVATION	X	X	2-SP1.02	SITE PHOTOMETRIC SCHEDULES	X X
1-A0.02	PAVILION - FORM BASED CODE - FACADE MATERIALS	X	X	2-SP1.03	SITE PHOTOMETRIC CUTSHEETS	X X
1-A0.03	PAVILION - FORM BASED CODE - FACADE TRANSPARENCY	X	X	30		
1-A0.04	PAVILION - FORM BASED CODE - COLORED ELEVATIONS	X	X			
1-A0.05	PAVILION - FORM BASED CODE DIAGRAMS - SHADOW ANALYSIS	Х	Х			
1-A0.06	PAVILION - FORM BASED CODE - 3D VIEWS	Х	X			
1-A0.07	PAVILION - FORM BASED CODE - MATERIALS BOARD	Х	Х			
1-A2.10	PLAN, FLOOR - LOWER BASEMENT, SHELL & CORE	Х				
1-A2.10B	PLAN, FLOOR - LOWER BASEMENT, WEST ENLARGED	Х				
1-A2.11	PLAN, FLOOR - BASEMENT, SHELL & CORE	Х				
1-A2.11A	PLAN, FLOOR - BASEMENT, EAST ENLARGED	Х				
1-A2.12	PLAN, FLOOR - LEVEL 1, SHELL & CORE	Х				
1-A2.12A	PLAN, FLOOR - LEVEL 1, EAST ENLARGED	Х				
1-A2.12B	PLAN, FLOOR - LEVEL1, WEST ENLARGED	Х				
1-A2.13	PLAN, FLOOR - LEVEL 2, SHELL & CORE	Х				
1-A2.13A	PLAN, FLOOR - LEVEL 2, EAST ENLARGED	Х				
1-A2.13B	PLAN, FLOOR - LEVEL 2, WEST ENLARGED	Х				
1-A2.14	PLAN, FLOOR - LEVEL 3, SHELL & CORE	Х				
1-A2.14A	PLAN, FLOOR - LEVEL 3, EAST ENLARGED	Х				
1-A2.14B	PLAN, FLOOR - LEVEL 3, WEST ENLARGED	Х				
1-A2.15	PLAN, FLOOR - LEVEL 4, SHELL & CORE	Х				
1-A2.15A	PLAN, FLOOR - LEVEL 4, EAST ENLARGED	Х				
1-A2.15B	PLAN, FLOOR - LEVEL 4, WEST ENLARGED	Х				
1-A2.16	PLAN, FLOOR - ROOF	Х				
1-A2.16A	PLAN, FLOOR - ROOF, EAST ENLARGED	X				
1-A2.16B	PLAN, FLOOR - ROOF, WEST ENLARGED	X				
1-A4.01	BUILDING DETAILS	X	X			
1-A4.02	BUILDING DETAILS	X	X			
1-SP1.01	SITE PHOTOMETRIC PLAN - NORTH	X				
1-SP1.02	SITE PHOTOMETRIC PLAN - TERRACES	X				
1-SP1.03	SITE PHOTOMETRIC SCHEDULES	X				
1-SP1.04	SITE PHOTOMETRIC CUTSHEETS	X X				
1-SP1.05	SITE PHOTOMETRIC CUTSHEETS					



ZIMMER GUNSUL FRASCA ARCHITECTS LLP

DENVER LOS ANGELES NEW YORK PORTLAND SEATTLE WASHINGTON, DC VANCOUVER, BC 1350 17th Street, Suite 250 Denver, Colorado 80202 303.557.6420 www.zgf.com

R26192

CIVIL THE SANITAS GROUP 901 FRONT STREET, SUITE 350 LOUISVILLE, CO 80027

Consultant

T 303 481 2170

ENTITLEMENTS STUDIO ARCHITECTURE 2995 55TH STREET, #17983 BOULDER, CO 80301 T 720 491 1167

LANDSCAPE STUDIO TERRA INC. 758 CLUB CIRCLE LOUISVILLE, CO 80027

T 303 494 9138

STRUCTURAL ANTHEM STRUCTURAL ENGINEERS FLATIRON OFFICE PARK 2213 CENTRAL AVENUE BOULDER, CO 80301 T 303 848 8497

MEP **BRANCH PATTERN** 3344 WALNUT STREET DENVER, CO 80205

LIGHTING AE DESIGN 1900 WAZEE STREET, #205 DENVER, CO 80202 T 303 296 3034

T 303 382 1920

AV/TECHNOLOGY/SECURIT

SALAS O'BRIEN 4900 NAUTILUS CT. N. SUITE 200 BOULDER, CO 80301 T 303 865 5500

Full Design Team Roster on Sheet 1-G0.01

Client and Project Information



Boulder Western City Campus - Volume 1-Pavilion Office Building 1155 Alpine Ave Boulder, CO 80302

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Revisions

Sheet Title

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> COVER SHEET & DRAWING INDEX -SITE REVIEW

1-G0.00

Current Issue SITE REVIEW

# PROJECT TEAM

CLIENT CITY OF BOULDER 1777 BROADWAY BOULDER, CO 80302 T 303 557 6420

ARCHITECT ZIMMER GUNSUL FRASCA ARCHITECTS LLP 1350 17TH STREET, SUITE 250 DENVER, CO 80202 T 303 557 6420 www.zgf.com

LANDSCAPE ARCHITECT ZIMMER GUNSUL FRASCA ARCHITECTS LLP 1350 17TH STREET, SUITE 250 DENVER, CO 80202 T 303 557 6420 www.zgf.com

CIVIL THE SANITAS GROUP, LLC 901 FRONT STREET, SUITE 350 LOUISVILLE, CO 80027 T 303 481 2710

ASSOCIATE ARCHITECT STUDIO ARCHITECTURE 2995 55TH STREET, #17983 BOULDER, CO 80301 T 720 491 1167

LANDSCAPE ARCHITECT STUDIO TERRA INC. 758 CLUB CIRCLE LOUISVILLE, CO 80027 T 303 494 9138

STRUCTURAL BOULDER, CO 80301 T 303 848 8497

BRANCH PATTERN 3344 WALNUT STREET DENVER, CO 80205 T 303 382 1920

SALAS O'BRIEN BOULDER, CO 80301 T 303 865 5500

ENVELOPE LERCH BATES ENGLEWOOD, CO 80112 T 303 795 7956

LIFE SAFETY

ACCESSIBILITY 2555 WALNUT STREET DENVER, CO 80205 T 303 986 1400

# **PROJECT INFORMATION - PAVILION**

PROJECT ADDRESS

BUILDING TYPE ZONING DISTRICT **BUILDING LOT** LOT SIZE CONSTRUCTION TYPE OCCUPANCY CLASSIFICATION

1155 ALPINE AVE. BOULDER, CO 80302

CIVIC BUILDING TYPE LOT 5 EXCLUDING RIGHT-OF-WAY 51,874 SF ON THE PRIMARY PLAT TYPE IIIA GROUP A-3, GROUP B

# APPLICABLE CODES

- 2018 INTERNATIONAL BUILDING CODE (IBC)
- 2018 INTERNATIONAL MECHANICAL CODE (IMC) 2018 INTERNATIONAL PLUMBING CODE (IPC)
- 2018 INTERNATIONAL FIRE CODE (IFC) 2018 INTERNATIONAL ENERGY CONSERVATION CODE (IECC)
- 2020 NATIONAL ELECTRIC CODE (NEC)
- 2020 CITY OF BOULDER ENERGY CONSERVATION CODE 2009 ANSI A117.1

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ANTHEM STRUCTURAL ENGINEERS FLATIRON OFFICE PARK 2213 CENTRAL AVENUE

MECHANICAL - ELECTRICAL - PLUMBING

AUDIOVISUAL/ACOUSTICS/TELECOM/SECURITY 4900 NAUTILUS CT. N. SUITE 200

9780 S. MERIDIAN BOULEVARD, SUITE 450

INCANDESCENCE LIFE SAFETY INC. 3455 RINGSBY COURT, #103 DENVER, CO 80216

BUILDING ONE CONSULTING LLC.


MOBILITY NELSON \ NYGAARD 116 NEW MONTGOMERY STREET SAN FRANCISCO, CA 94105 T 415 284 1544

TRANSPORTATION FEHR & PEERS 1919 14TH STREET, SUITE 700 BOULDER, CO 80302 T 720 457 6370


VERTICAL TRANSPORTATION VDA 506 2ND AVE, SUITE 1400 SEATTLE, WA 98104 T 206 705 2940

LIGHTING AE DESIGN 1900 WAZEE STREET, #205 DENVER, CO 80202 T 303 296 3034

# **PROJECT SCOPE - SITE REVIEW**

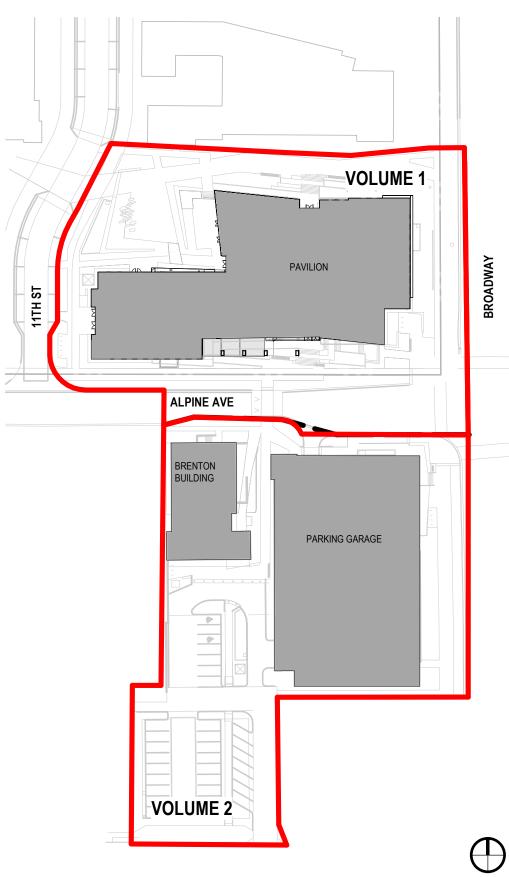

# VICINITY MAP

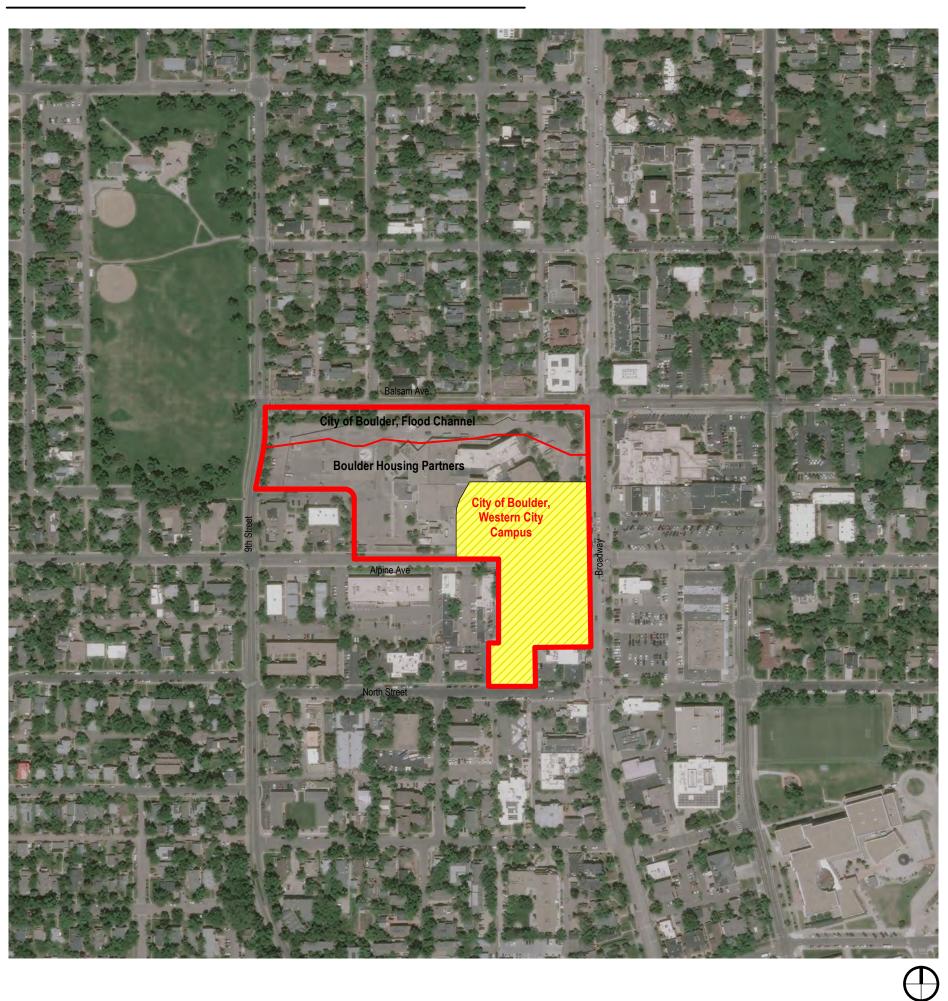

# ZONING MAP





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CIVIL THE SANITAS GROUP 901 FRONT STREET, SUITE 350 LOUISVILLE, CO 80027 T 303 481 2170

ENTITLEMENTS STUDIO ARCHITECTURE 2995 55TH STREET, #17983 BOULDER, CO 80301 T 720 491 1167 LANDSCAPE

STUDIO TERRA INC. 758 CLUB CIRCLE LOUISVILLE, CO 80027 T 303 494 9138

STRUCTURAL ANTHEM STRUCTURAL ENGINEERS FLATIRON OFFICE PARK 2213 CENTRAL AVENUE BOULDER, CO 80301 T 303 848 8497 MEP

**BRANCH PATTERN** 3344 WALNUT STREET DENVER, CO 80205 T 303 382 1920

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T 303 865 5500

AV/TECHNOLOGY/SECURITY SALAS O'BRIEN 4900 NAUTILUS CT. N. SUITE 200 BOULDER, CO 80301

Full Design Team Roster on Sheet 1-G0.01

Client and Project Information



Boulder Western City Campus - Volume 1-Pavilion Office Building

1155 Alpine Ave Boulder, CO 80302

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> VICINITY MAP, DIRECTORY, & PROJECT INFORMATION

1-G0.01

Current Issue SITE REVIEW





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# LEGEND

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LIMIT OF WORK PROPERTY LINE PUBLIC ACCESS EASEMENT

# NOTES:

PLEASE SEE SHEETS 1-L0.20 THROUGH 1-L01.22 FOR FBC COMPLIANCE SHEETS



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Key Plan and Orientation

Revisions


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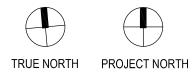
OVERALL SITE PLAN - SITE REVIEW

Sheet Number 1-G0.02

Current Issue SITE REVIEW






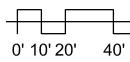



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SCALE: 1"=30'
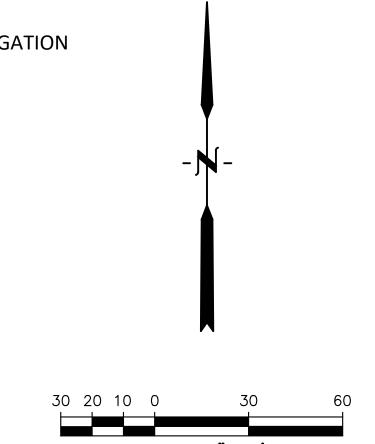
# PHASING LEGEND

PHASE 1A - GARAGE & ASSOCIATED UTILITY IMPROVEMENTS
PHASE 1B - GARAGE SITE IMPROVEMENTS
PHASE 2A - PAVILION & ASSOCIATED UTILITY IMPROVEMENTS
PHASE 2B - PAVILION SITE
PHASE 3 - ALPINE AVE IMPROVEMENTS
PHASE 4 - "BRENTON" PARKING & RELATED SITE IMPROVEMENTS
11TH STREET IMPROVEMENTS

SEE FBC INFRASTRUCTURE PLANS TO BE CONSTRUCTED PRIOR TO OCCUPANCY OF PAVILION.

# PHASING NOTES:

PHASING DEPICTED ON THIS PLAN MAY NOT START IN THE ORDER GIVEN - I.E. PHASE 2A MAY START PRIOR TO PHASE 1A OR 1B DEPENDING ON CITY DELIVERY GOALS AND CONSTRUCTION TIME FRAMES.



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ENTITLEMENTS STUDIO ARCHITECTURE 2995 55TH STREET, #17983 BOULDER, CO 80301 T 720 491 1167

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MEP BRANCH PATTERN 3344 WALNUT STREET DENVER, CO 80205 T 303 382 1920

LIGHTING AE DESIGN 1900 WAZEE STREET, #205 DENVER, CO 80202

T 303 296 3034 AV/TECHNOLOGY/SECURITY SALAS O'BRIEN

4900 NAUTILUS CT. N. SUITE 200 BOULDER, CO 80301 T 303 865 5500

Full Design Team Roster on Sheet 1-G0.01 Client and Project Information



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Key Plan and Orientation

Revisions

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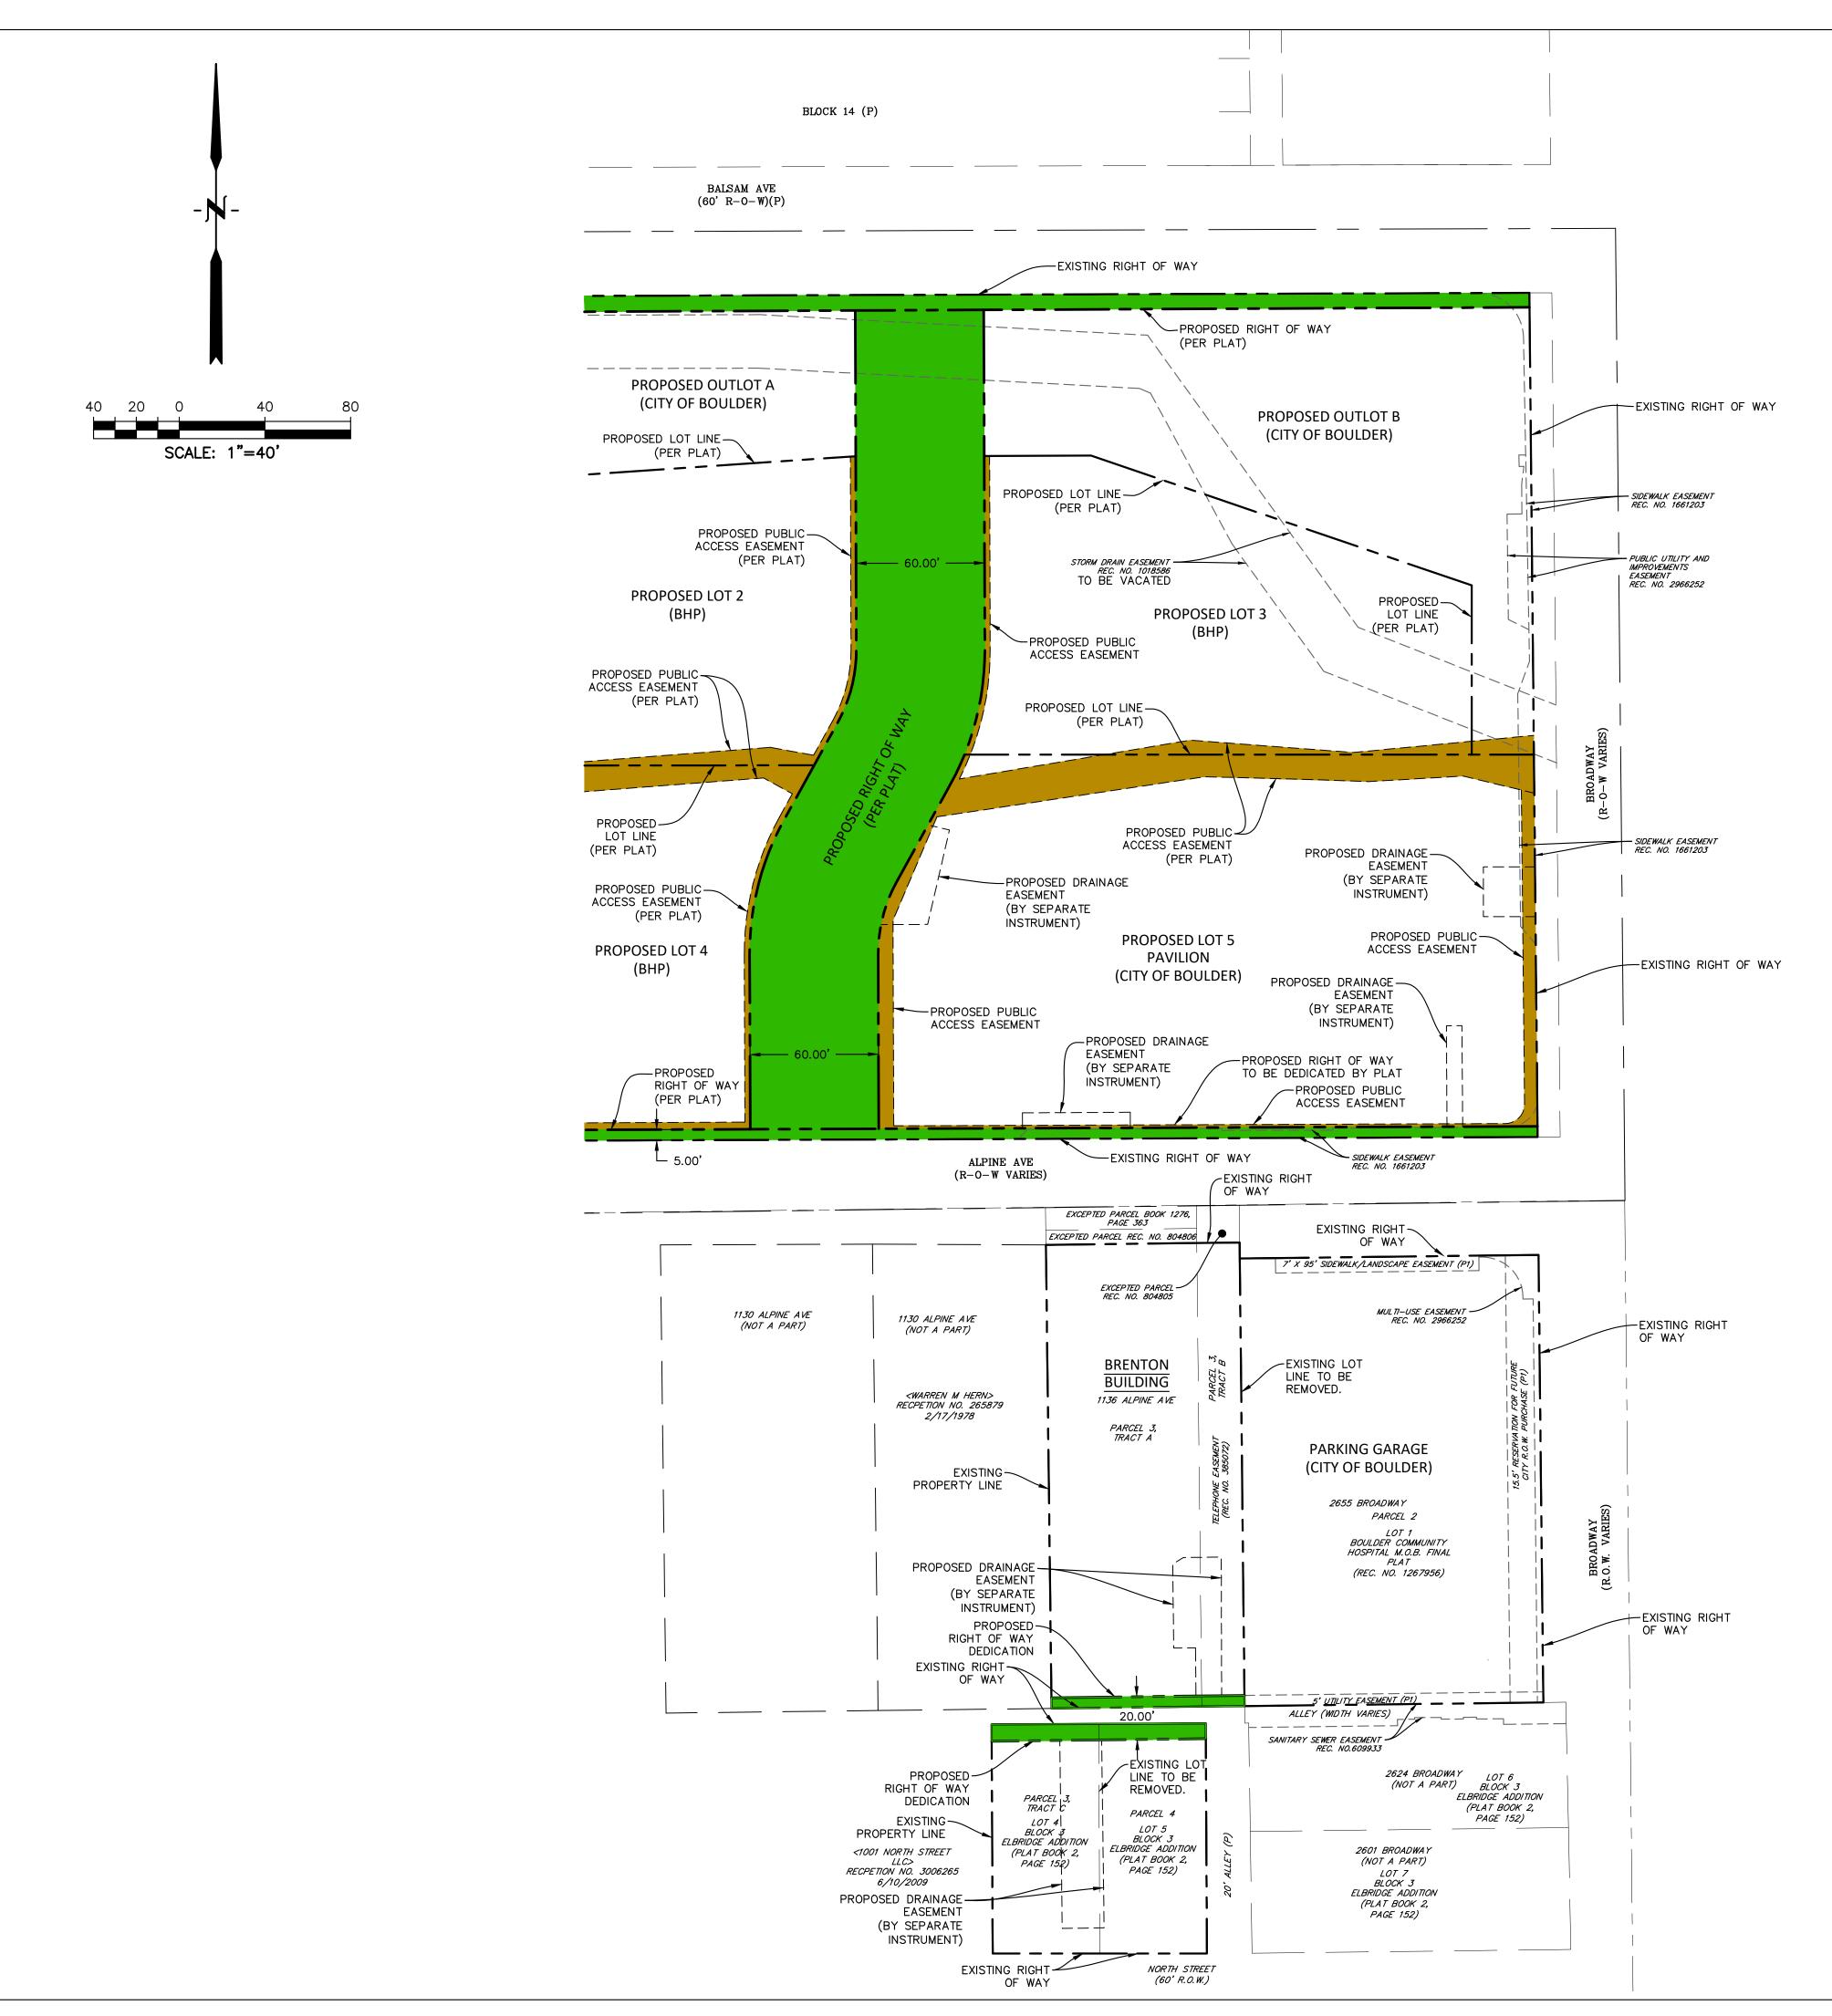
PHASING PLAN



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DEDICATIONS EXHIBIT




Current Issue SITE REVIEW

Current Issue Date

11/03/2023

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1LANDSCAPE SITE PLAN - SITE REVIEW1-L0.001" = 20'-0"
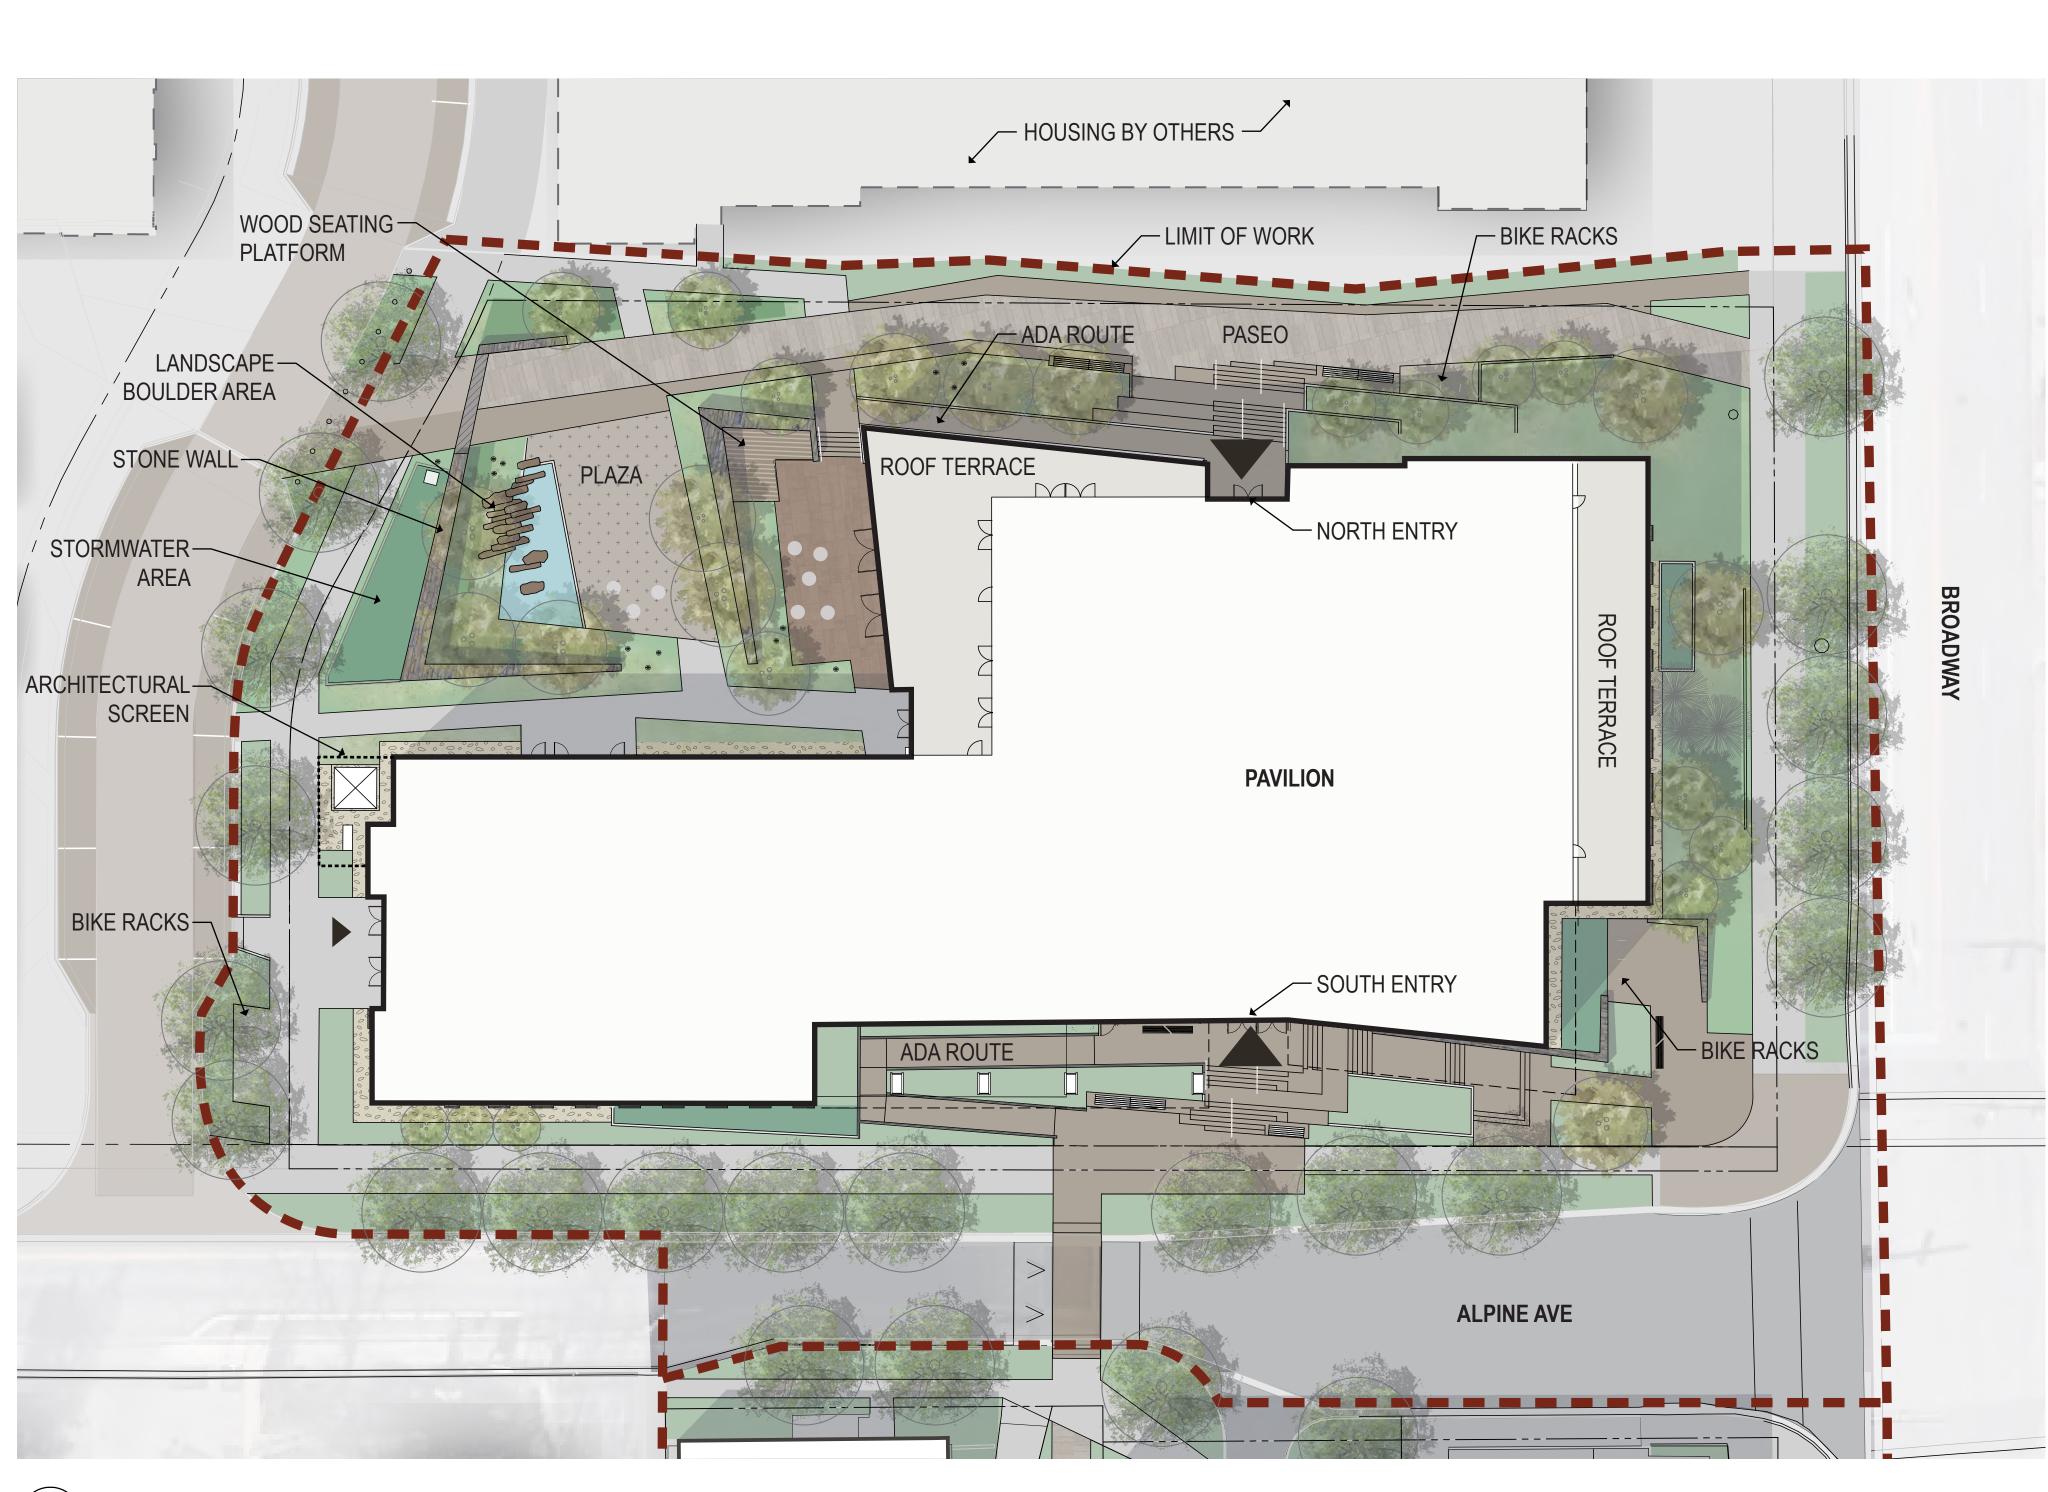
# LEGEND

	LIMIT OF WORK
	PROPERTY LINE
	BUILDING OVERHANG
	PLANTING AREA
	ENHANCED PLANTING AREA
	STORMWATER AREA
	STANDARD CONCRETE
	COLORED CONCRETE
	CONCRETE PAVERS
* * * * * * * *	PERVIOUS PAVERS - PEDESTRIAN
	PERVIOUS PAVERS - VEHICULAR
	STONE PAVERS
	STONE BANDING
	ROOF TERRACE
	WOOD DECK
	WATER FEATURE
	GRAVEL STRIPE
	BOULDERS
	ENTRANCE
	TYPE A WALL
	TYPE B WALL
	PRECAST CONCRETE



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CIVIL THE SANITAS GROUP 901 FRONT STREET, SUITE 350 LOUISVILLE, CO 80027 T 303 481 2170

Consultant

ENTITLEMENTS STUDIO ARCHITECTURE 2995 55TH STREET, #17983 BOULDER, CO 80301 T 720 491 1167 LANDSCAPE STUDIO TERRA INC.

758 CLUB CIRCLE LOUISVILLE, CO 80027 T 303 494 9138

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LANDSCAPE SITE PLAN - SITE REVIEW


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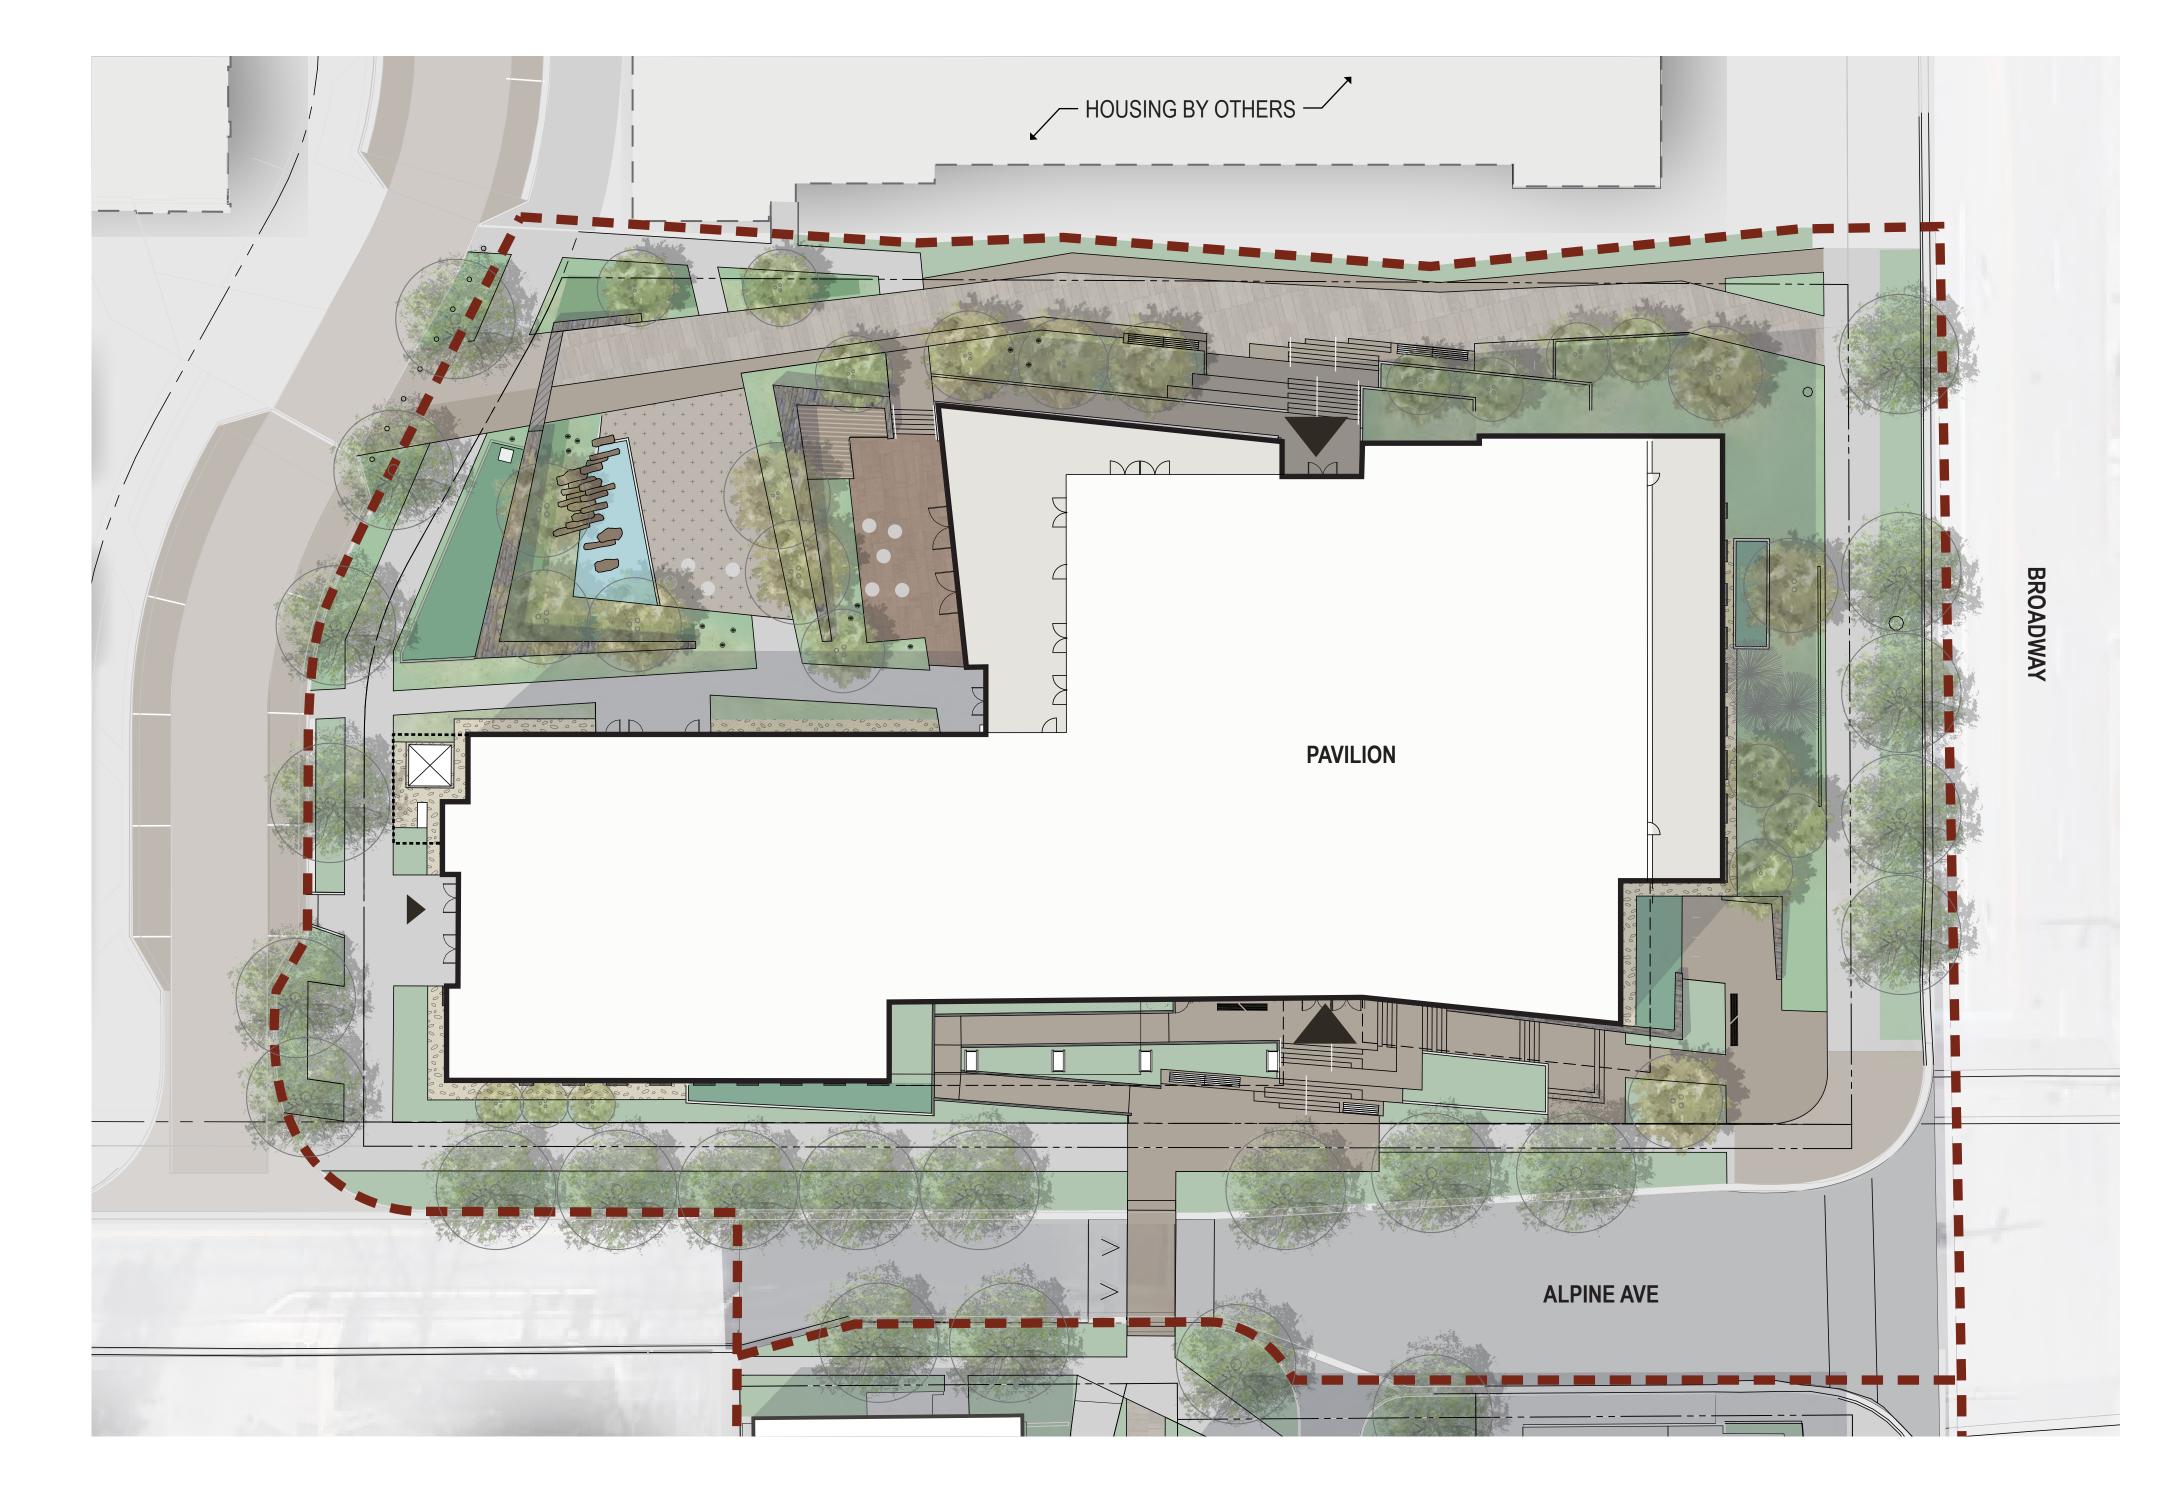
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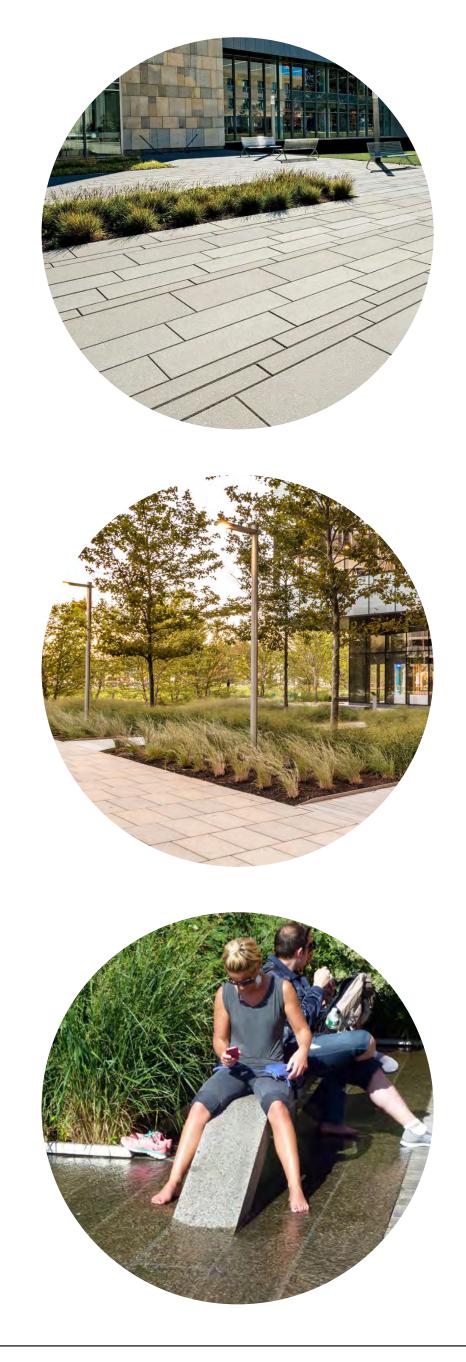
SEATING - LOOK + FEEL







STONE - LOOK + FEEL

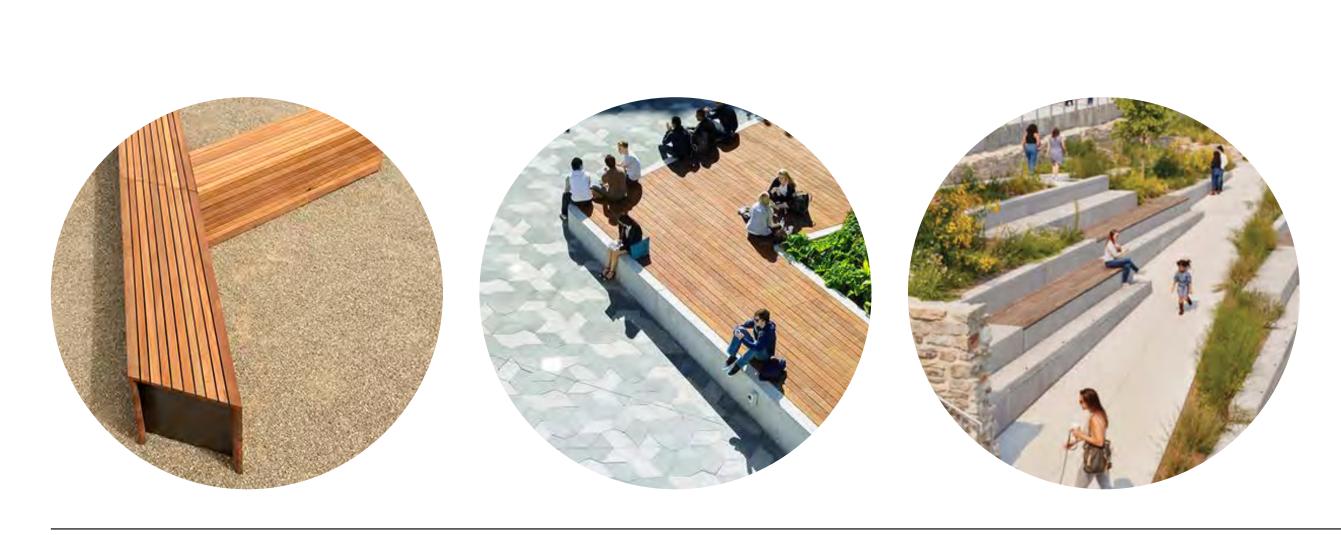

HARDSCAPE - LOOK + FEEL



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1350 17th Street, Suite 250 Denver, Colorado 80202 303.557.6420 www.zgf.com

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CIVIL THE SANITAS GROUP 901 FRONT STREET, SUITE 350 LOUISVILLE, CO 80027 T 303 481 2170

Consultant

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STRUCTURAL ANTHEM STRUCTURAL ENGINEERS FLATIRON OFFICE PARK 2213 CENTRAL AVENUE BOULDER, CO 80301 T 303 848 8497 MEP

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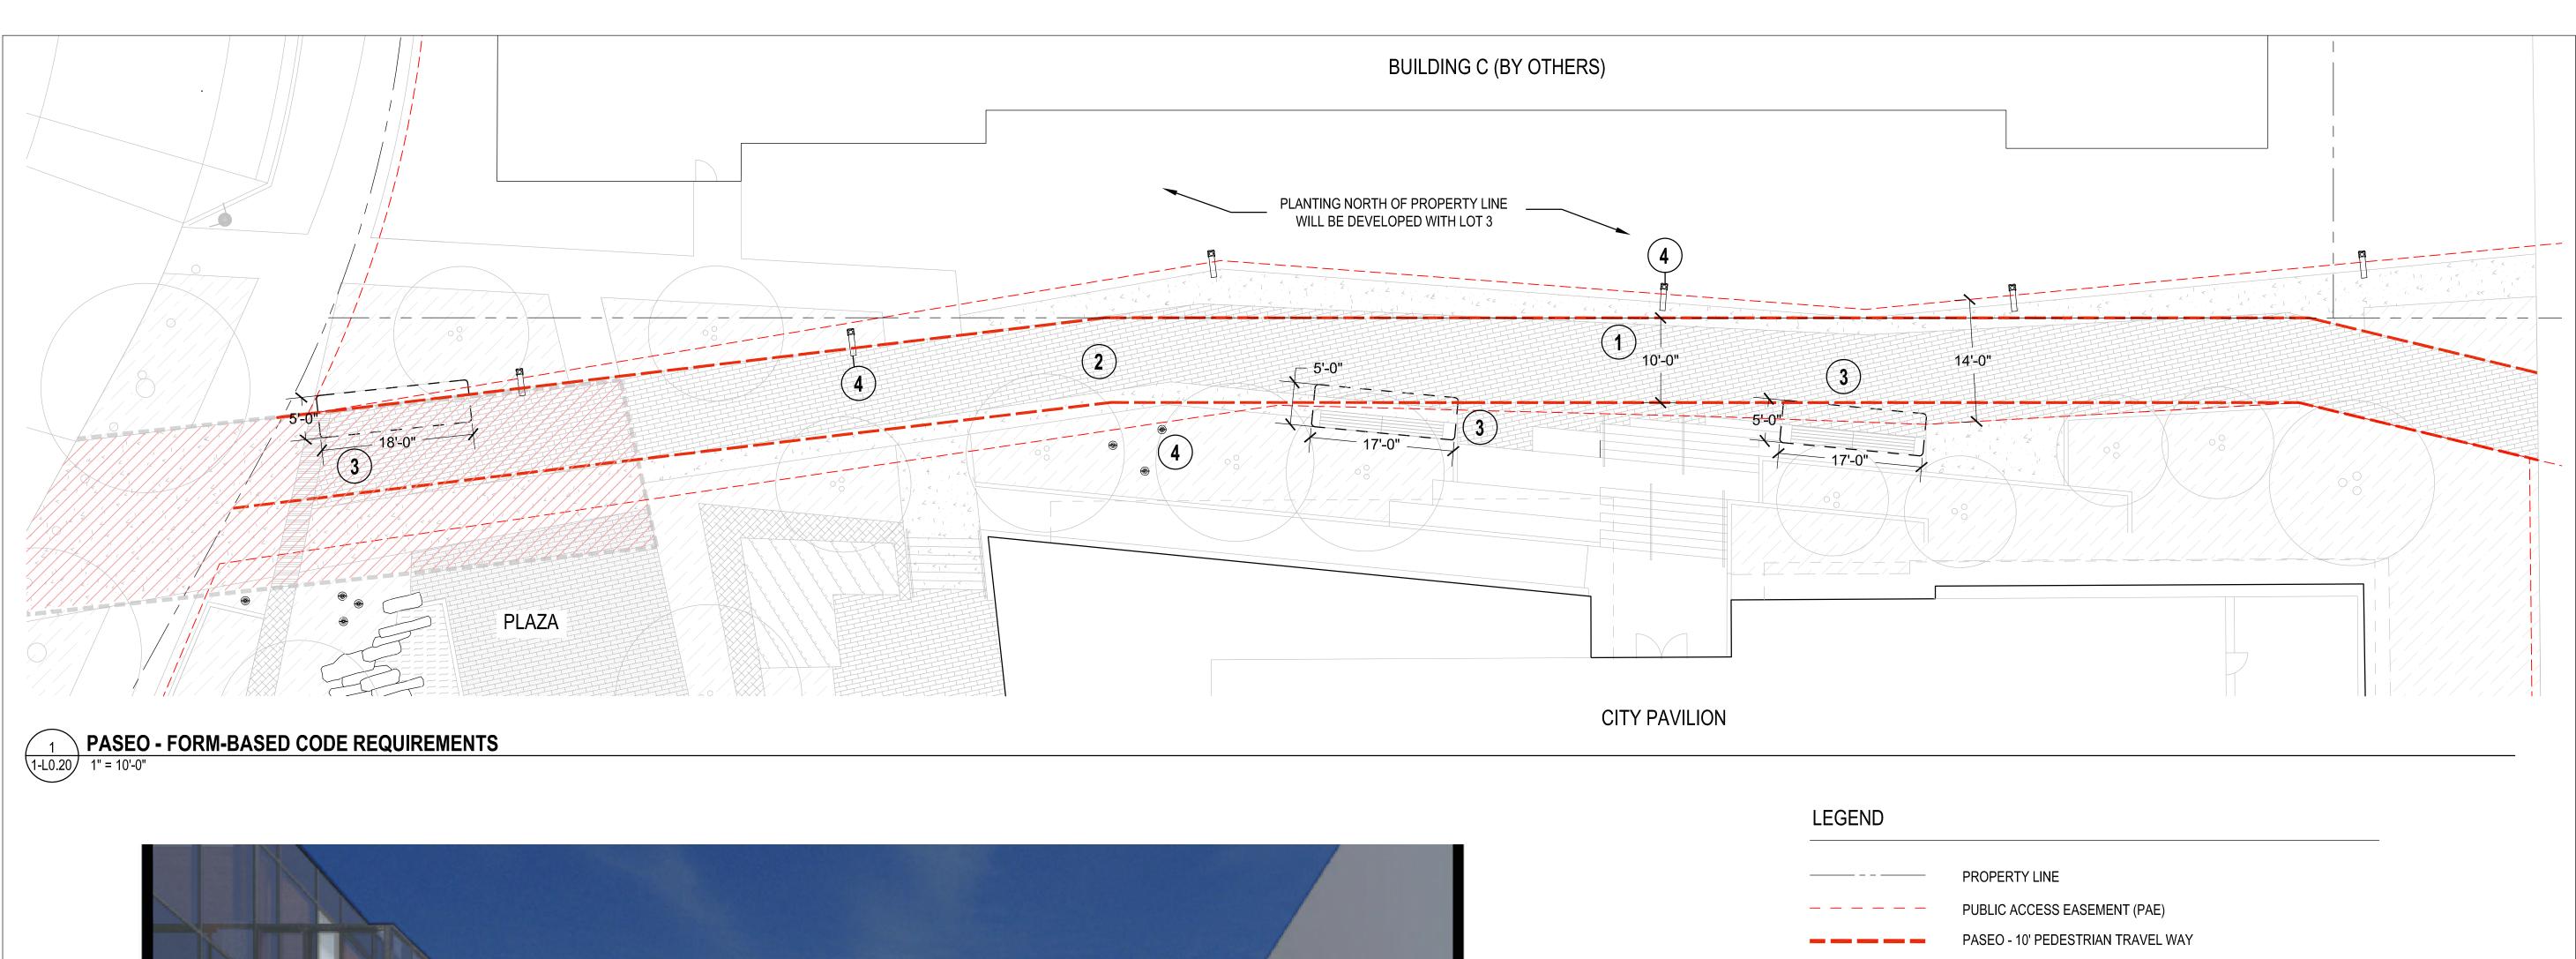
Sheet Title

# PRECEDENT IMAGERY

Sheet Number



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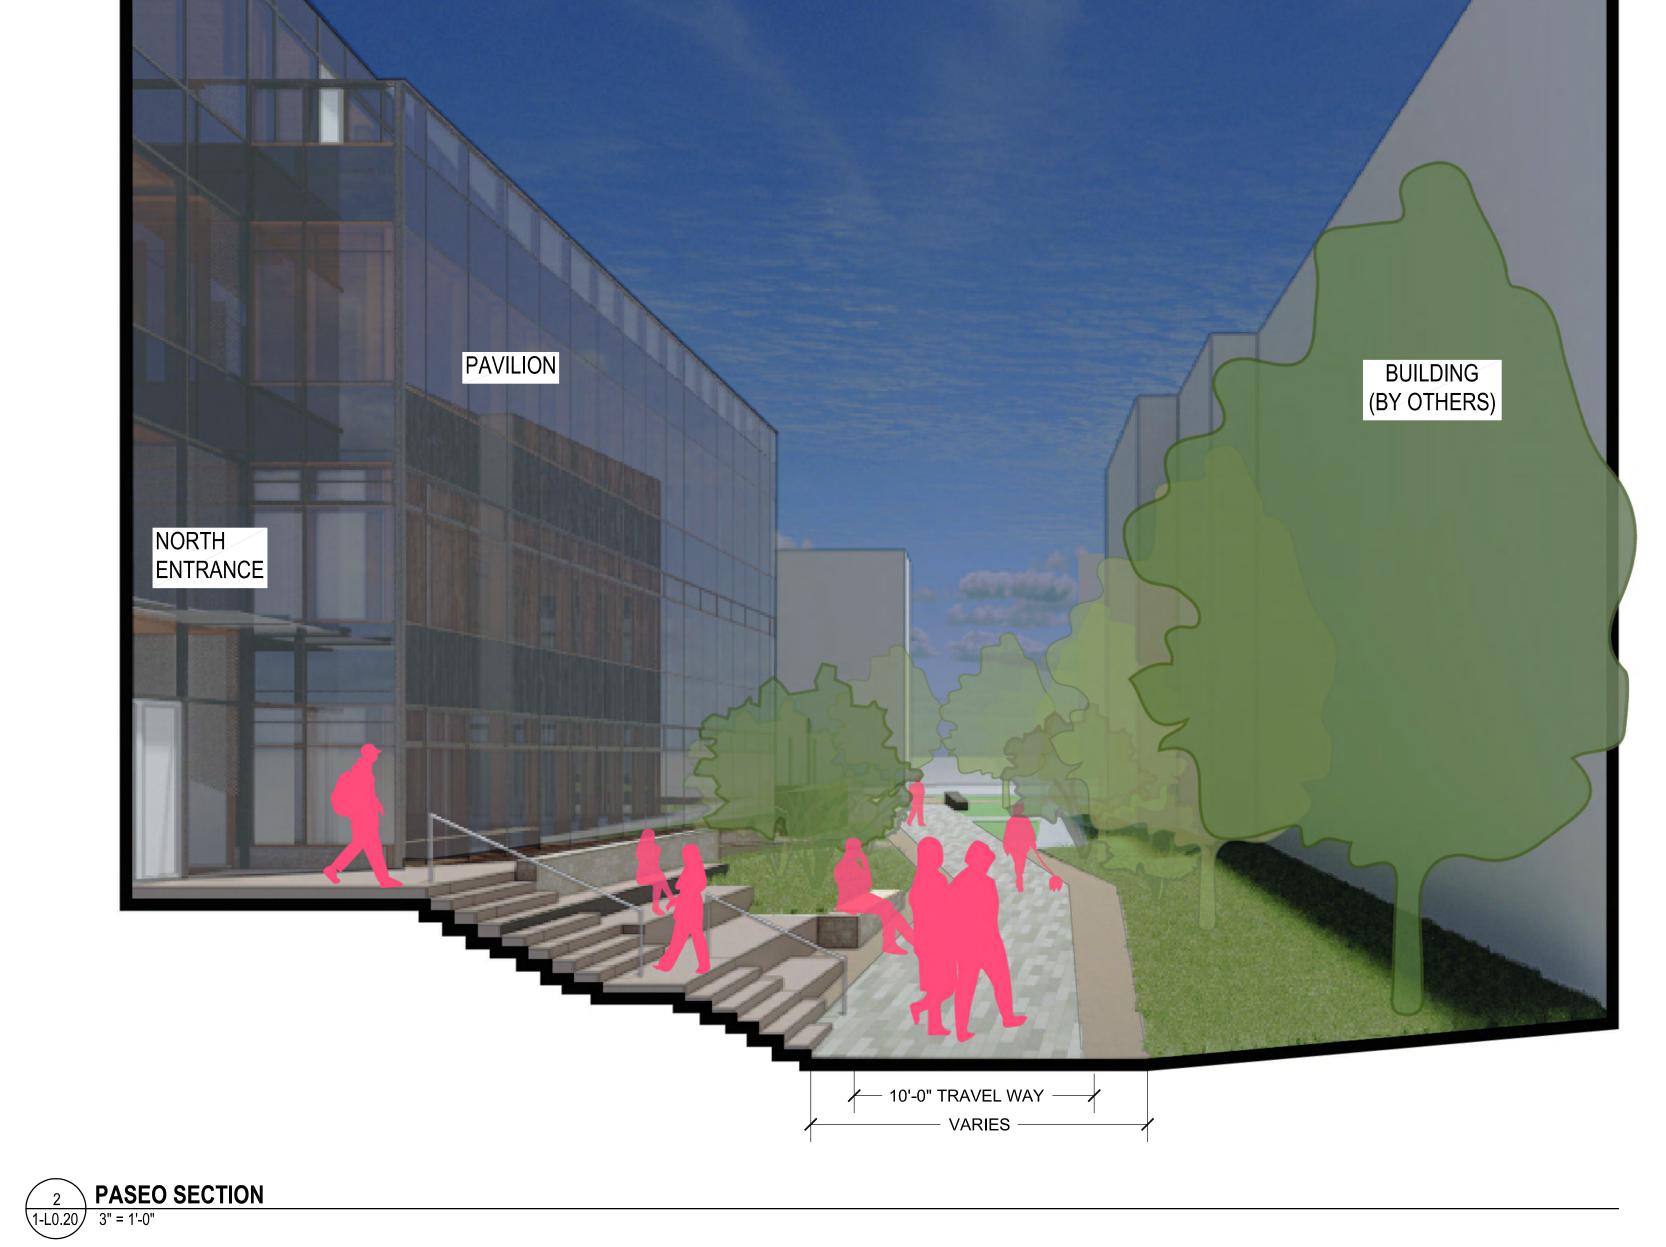




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# ENHANCED PASEO REQUIREMENTS:

KEYNOTE	DESIGN STANDARDS	ENHANCED PASEO
	Minimum width of paseo	25'
	Minimum width of easement and pedestrian travel way	25' minimum width of easement. 10' minimum width of pedestrian travel way.
	Elements within public access easement	All elements in the public access easement must be approved as part of a revocable permit or lease as applicable. Doors must be recessed and shall not open into the public access easement.
2	Surface treatment of pedestrian Travel way	Combination of gray concrete in a decorative scoring pattern, patterned brick and permeable pavers. Brick and pavers shall constitute at least 30% of the surface treatment of the pedestrian travel way and 100% of adjacent seating areas.
	Minimum distance between pedestrian travel way and adjacent buildings	18 inches
	Minimum slope between pedestrian travel way and adjacent buildings	2%
3	Minimum dimensions for adjacent outdoor seating areas	5' x 10'
4	Outdoor lighting	Pedestrian scaled pole mounted lighting


# ADDITIONAL REQUIREMENTS


RETAINING WALLS SHOULD NOT EXCEED 36".
 SEATING WALLS SHOULD NOT EXCEED 24"

- PLANTING AREA
- PAVERS 94% OF PASEO TRAVEL WAY
- COLORED CONCRETE

FIRE ACCESS

PLANTERS SHALL BE AT LEAST 6' AND NO MORE THAN 20' LONG.
 TREES SHALL BE DISTRIBUTED AT NO LESS THAN 1 PER EVERY 50 LINEAR FEET.
 NO LESS THAN 25% OF THE PASEO SHALL BE LANDSCAPED, EVENLY DISTRIBUTED.

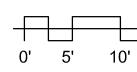

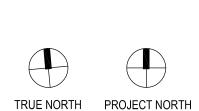

20'



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LANDSCAPE STUDIO TERRA INC. 758 CLUB CIRCLE LOUISVILLE, CO 80027 T 303 494 9138

STRUCTURAL ANTHEM STRUCTURAL ENGINEERS FLATIRON OFFICE PARK 2213 CENTRAL AVENUE BOULDER, CO 80301 T 303 848 8497

MEP **BRANCH PATTERN** 3344 WALNUT STREET DENVER, CO 80205 T 303 382 1920

LIGHTING AE DESIGN 1900 WAZEE STREET, #205 DENVER, CO 80202 T 303 296 3034

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CONSTRUCTION

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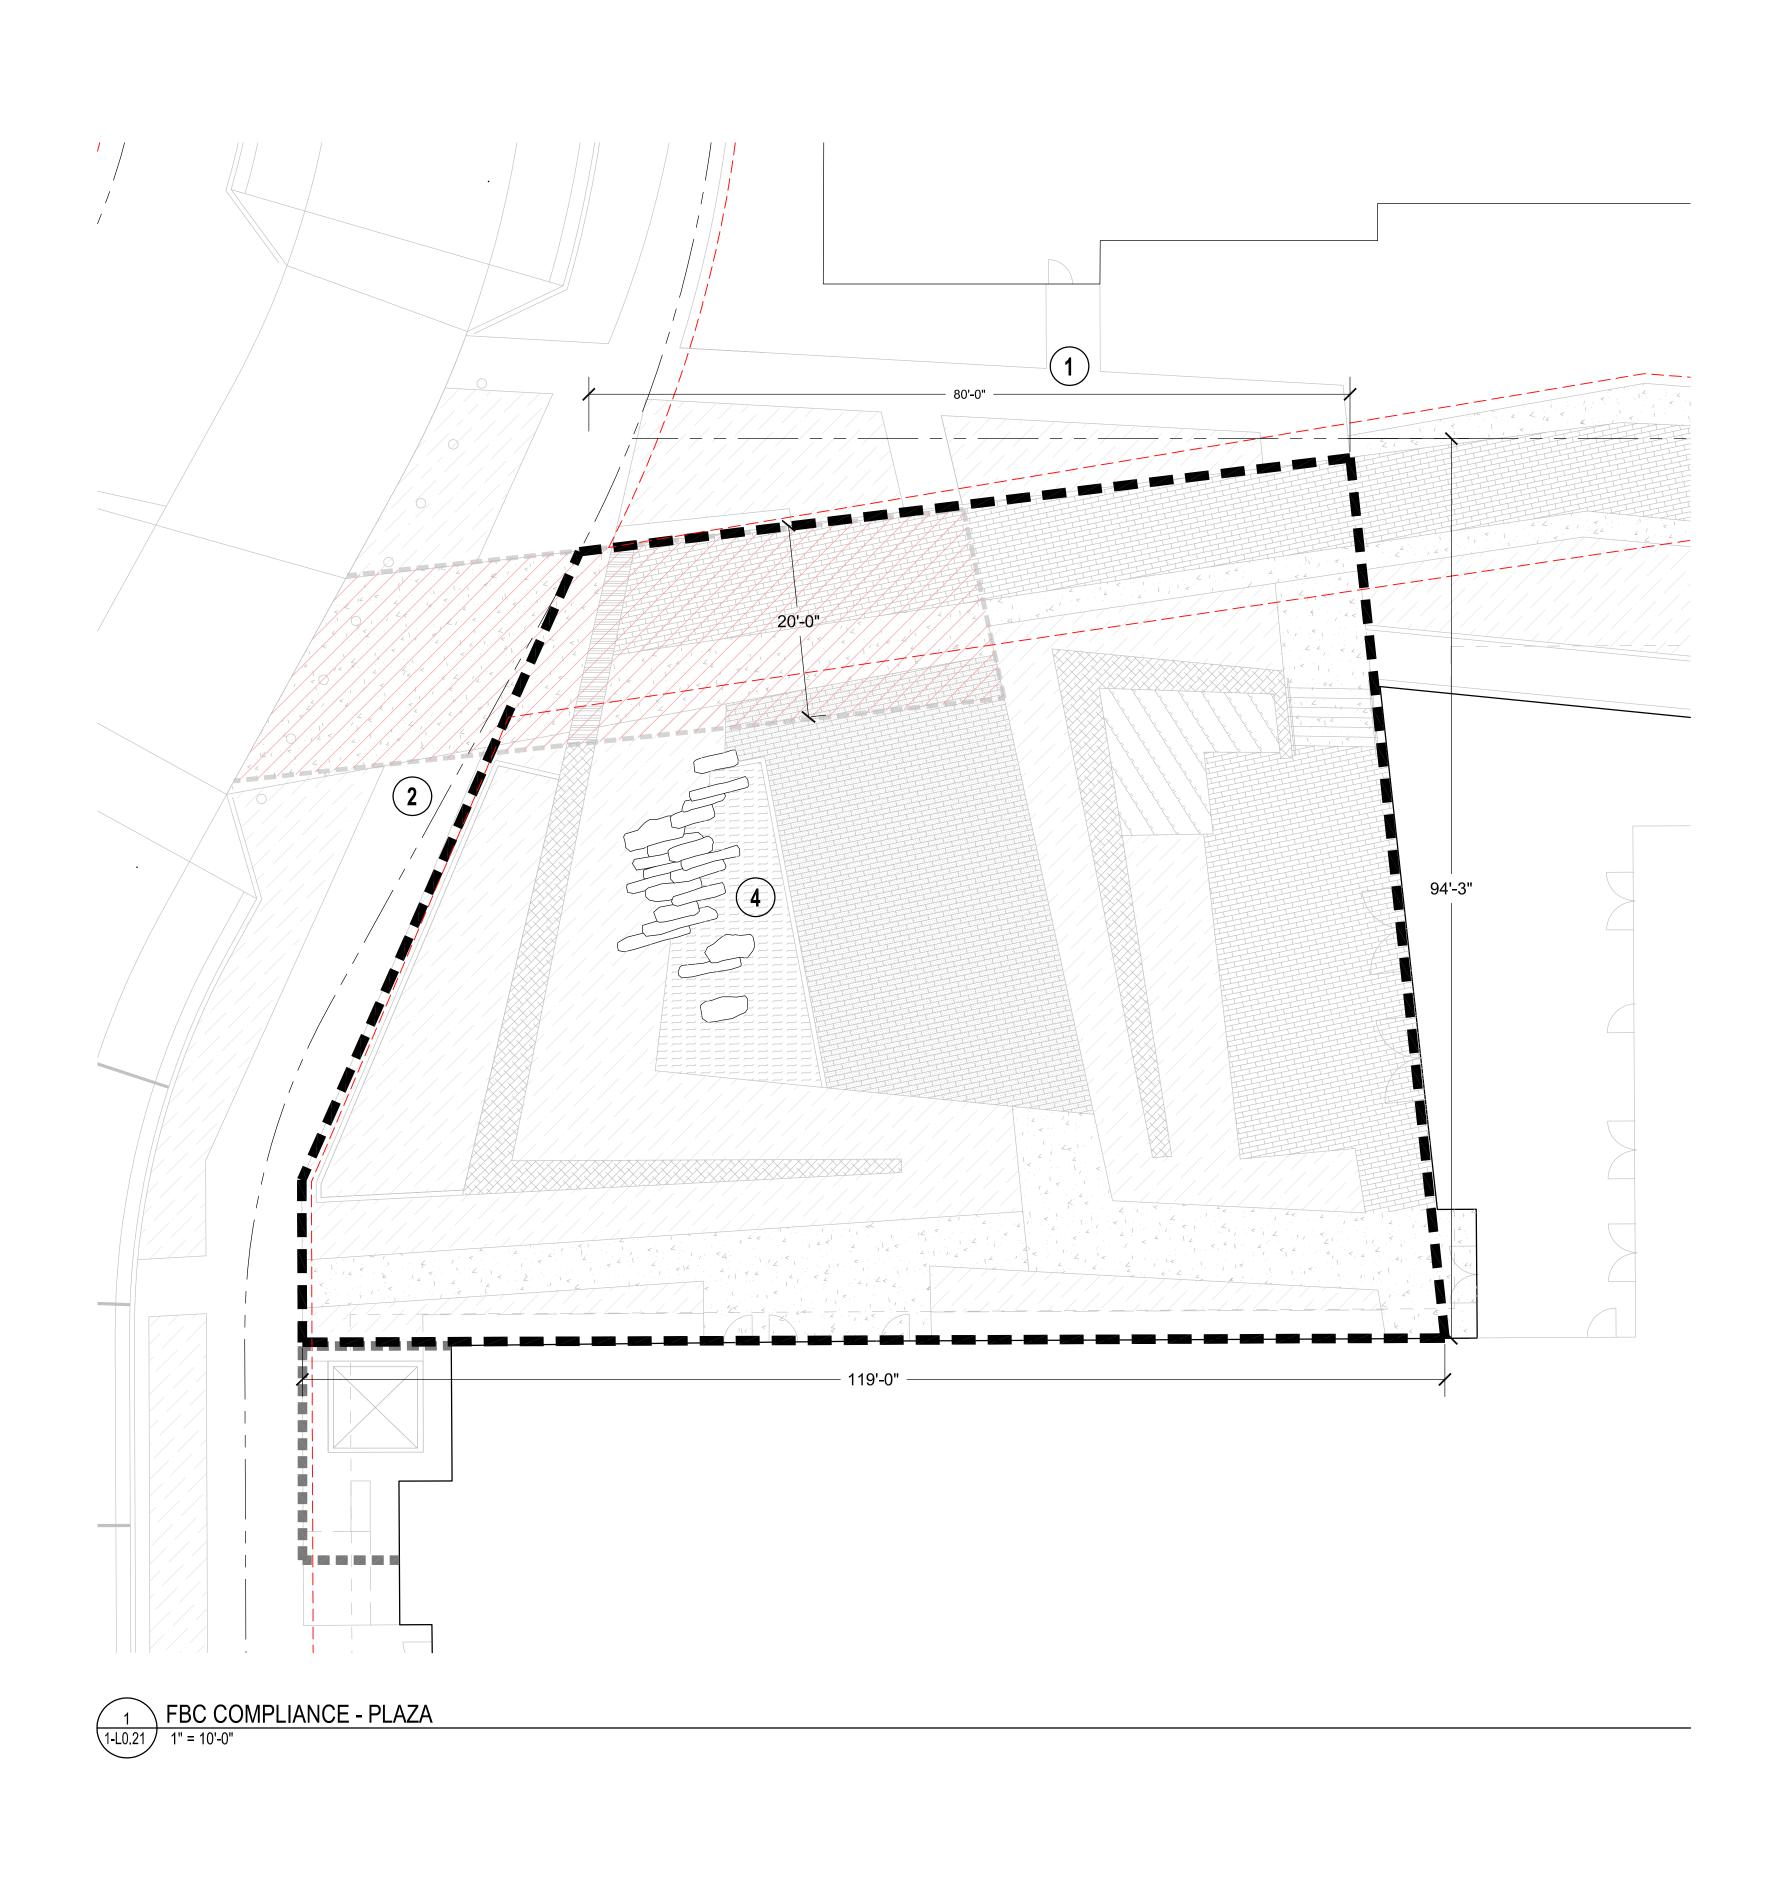
FBC COMPLIANCE -PASEO



Current Issue SITE REVIEW

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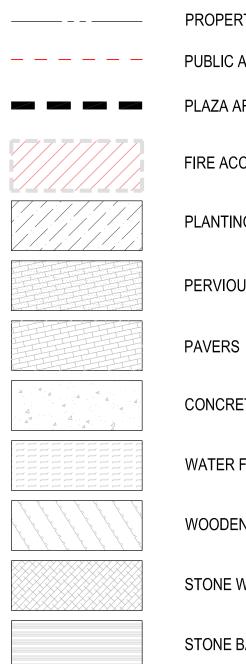
36 24 S



# PLAZA REQUIREMENTS:

KEYNOTE	DIMENSIONS		PROPOSED DESIGN
	MINIMUM SIZE	0.10 ACRES (4,356 SF)	8,867 SF
	MAXIMUM SIZE	1 ACRE (43,560 SF)	8,867 SF
	MINIMUM DIMENSION	80 FT	SEE PLAN
2	MINIMUM PERCENTAGE OF STREET OR PUBLIC WAY FRONTAGE	25%	SEE PLAN
	IMPROVEMENTS		N/A
	DESIGNATED SPORTS FIELDS	NOT PERMITTED	N/A
	PLAYGROUNDS	NOT PERMITTED	N/A
	FULLY ENCLOSED STRUCTURES	PERMITTED; MAY COVER MAXIMUM 5% OF PLAZA AREA	N/A
		60%+ IMPERVIOUS	52%
(3)	SURFACE + SEMI-PERVIOUS SURFACE	20% SEMI-PERVIOUS	13%
4	MAXIMUM PERCENTAGE OF OPEN WATER	30%	3%

# LEGEND



PROPERTY LINE	
PUBLIC ACCESS EASEMENT	
PLAZA AREA - 8,867 SF	
FIRE ACCESS	
PLANTING AREA	
PERVIOUS PAVERS 1,197 SF (13%)	3
PAVERS	
CONCRETE	
WATER FEATURE AREA 315 SF (3%)	4
WOODEN PLATFORM	
STONE WALLS	
STONE BAND	
TOTAL IMPERVIOUS SURFACES 4,605 SF (52%)	3

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ENTITLEMENTS STUDIO ARCHITECTURE 2995 55TH STREET, #17983 BOULDER, CO 80301 T 720 491 1167 LANDSCAPE STUDIO TERRA INC.

758 CLUB CIRCLE LOUISVILLE, CO 80027 T 303 494 9138

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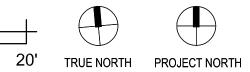
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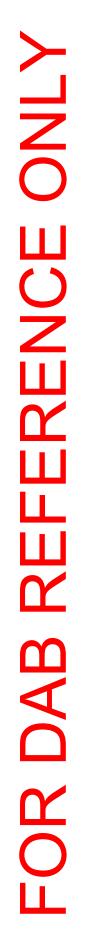
Current Issue SITE REVIEW

Current Issue Date 11/03/2023


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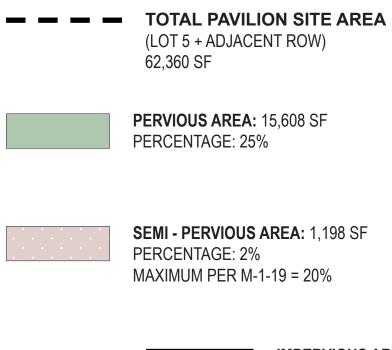








# LEGEND

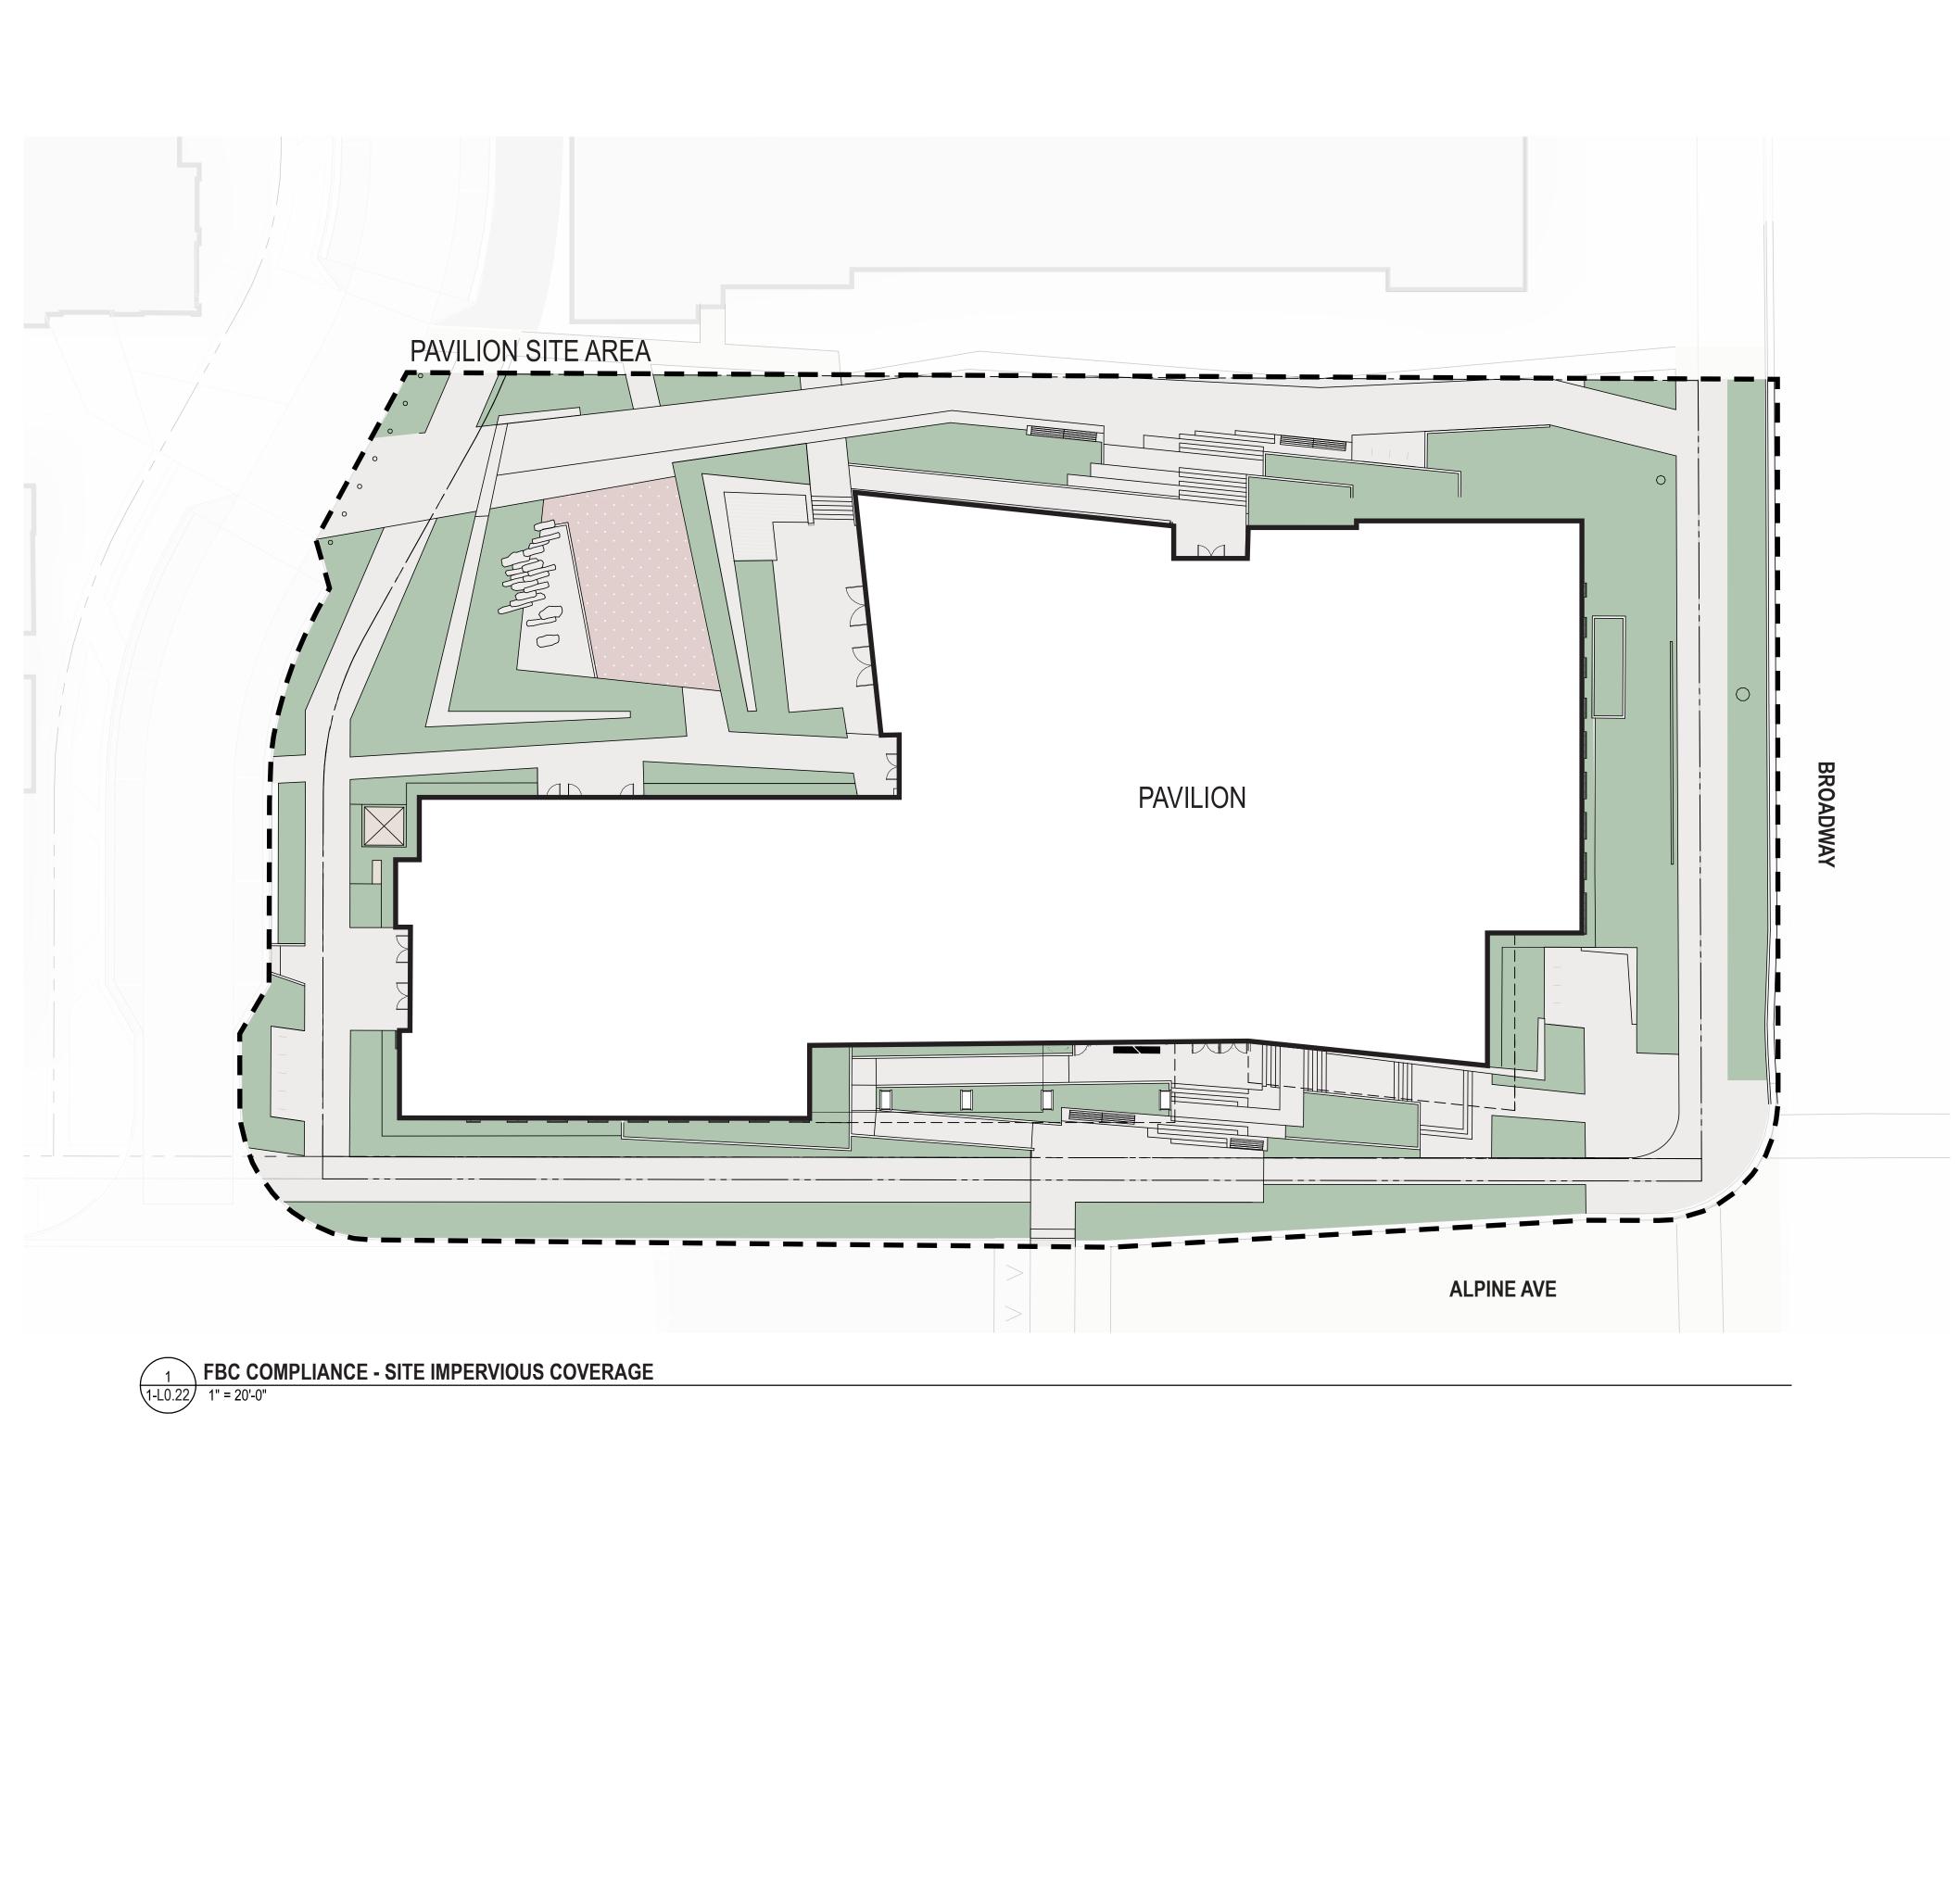

IMPERVIOUS AREA: 45,554 SF PERCENTAGE: 73% MAXIMUM PER M-1-19 = 50%



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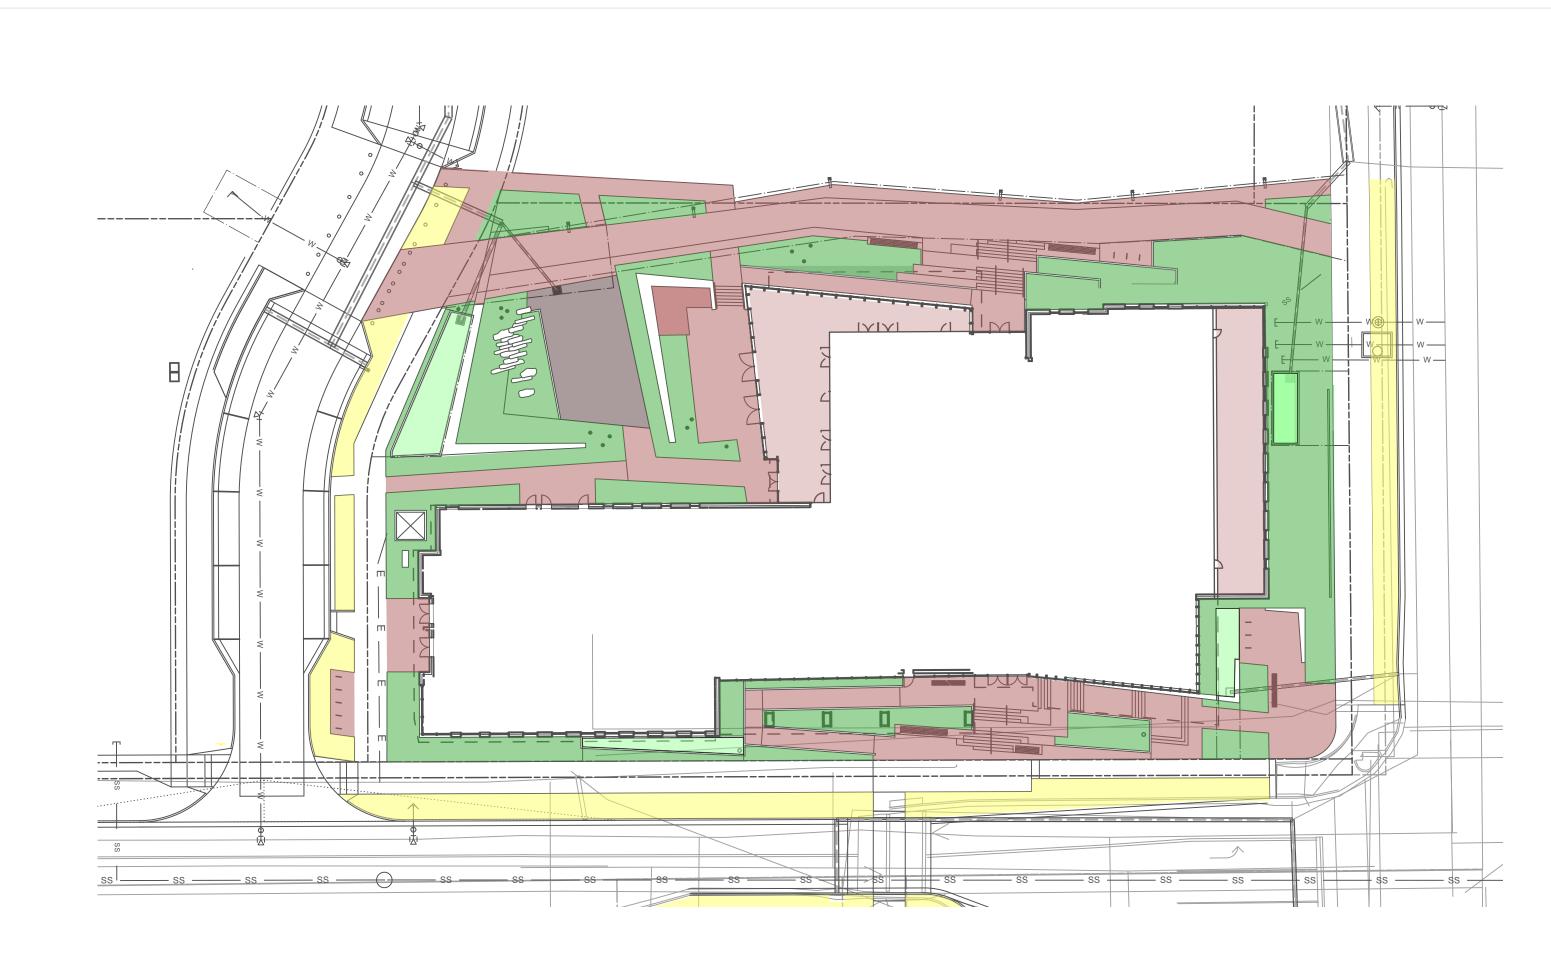
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FBC COMPLIANCE - SITE IMPERVIOUS COVERAGE

Sheet Number



Current Issue





# OPEN SPACE LEGEND

LANDSCAPE
LANDSCAPE - WATER QUALITY PLANTER
ROW LANDSCAPE - NOT INCLUDED IN OS CALC
HARDSCAPE - ENHANCED PAVING
HARDSCAPE - ENHANCED PAVING - PERMEABLE PAVERS
HARDSCAPE - ROOF DECK

Western City Campus Open Space Calculation - North of Alpine 10/28/23

PUBLIC ZONE CALCULATION20% of Total Land AreaTotal Land Area = 51,874Interior ground floor OS can count up to 50% of required10,375 SF required (20%)34,523 SF provided (66%)

Open Space	Actual	Can Count			
Landscape					
Site Landscape	10,584	10,584	SF		
Rain Gardens (WQ Features)	1,302	1,302	SF		
Hardscape					
Enhanced paving	12,777	12,777	SF		
Common Roof Deck	3,060	3,060	SF	6%	Can count up to 25% of required
Common Interior Ground Floor	6,800	6,800	SF	13%	Can count up to 50% of required
	34,523	34,523	SF		

# Landscape Requirements

1 Tree/5 Shrubs for each 1,500 SF not covered by building or parking

Shrubs	81	125+
Trees	16	26
	Required	Provided
Remaining	24,174	SF
Total Parking Coverage	-	SF
Total Building Coverage	27,700	SF
Total Site	51,874	SF

Sod Quantity - no sod anticipated on this project.

Street trees - one tree every 40 LF

# Street Frontage

Alpine Avenue	320	LF	
11th Street	186	LF	
Broadway	180	LF	
			L

Parking Lot Landscape - Not Applicable

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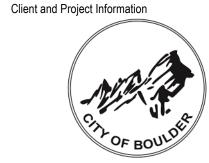
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SITE REVIEW LANDSCAPE COMPLIANCE



Current Issue

Current Issue Date **11/03/2023** 

10,335 SF of shrub beds provided

 Required
 Provided

 8
 8

 5
 7

 5
 5





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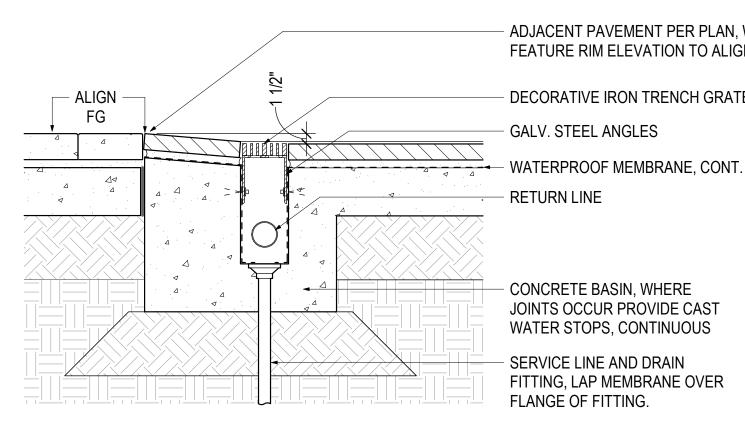
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Current Issue SITE REVIEW

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ADJACENT PAVEMENT PER PLAN, WATER FEATURE RIM ELEVATION TO ALIGN

GALV. STEEL ANGLES

- RETURN LINE

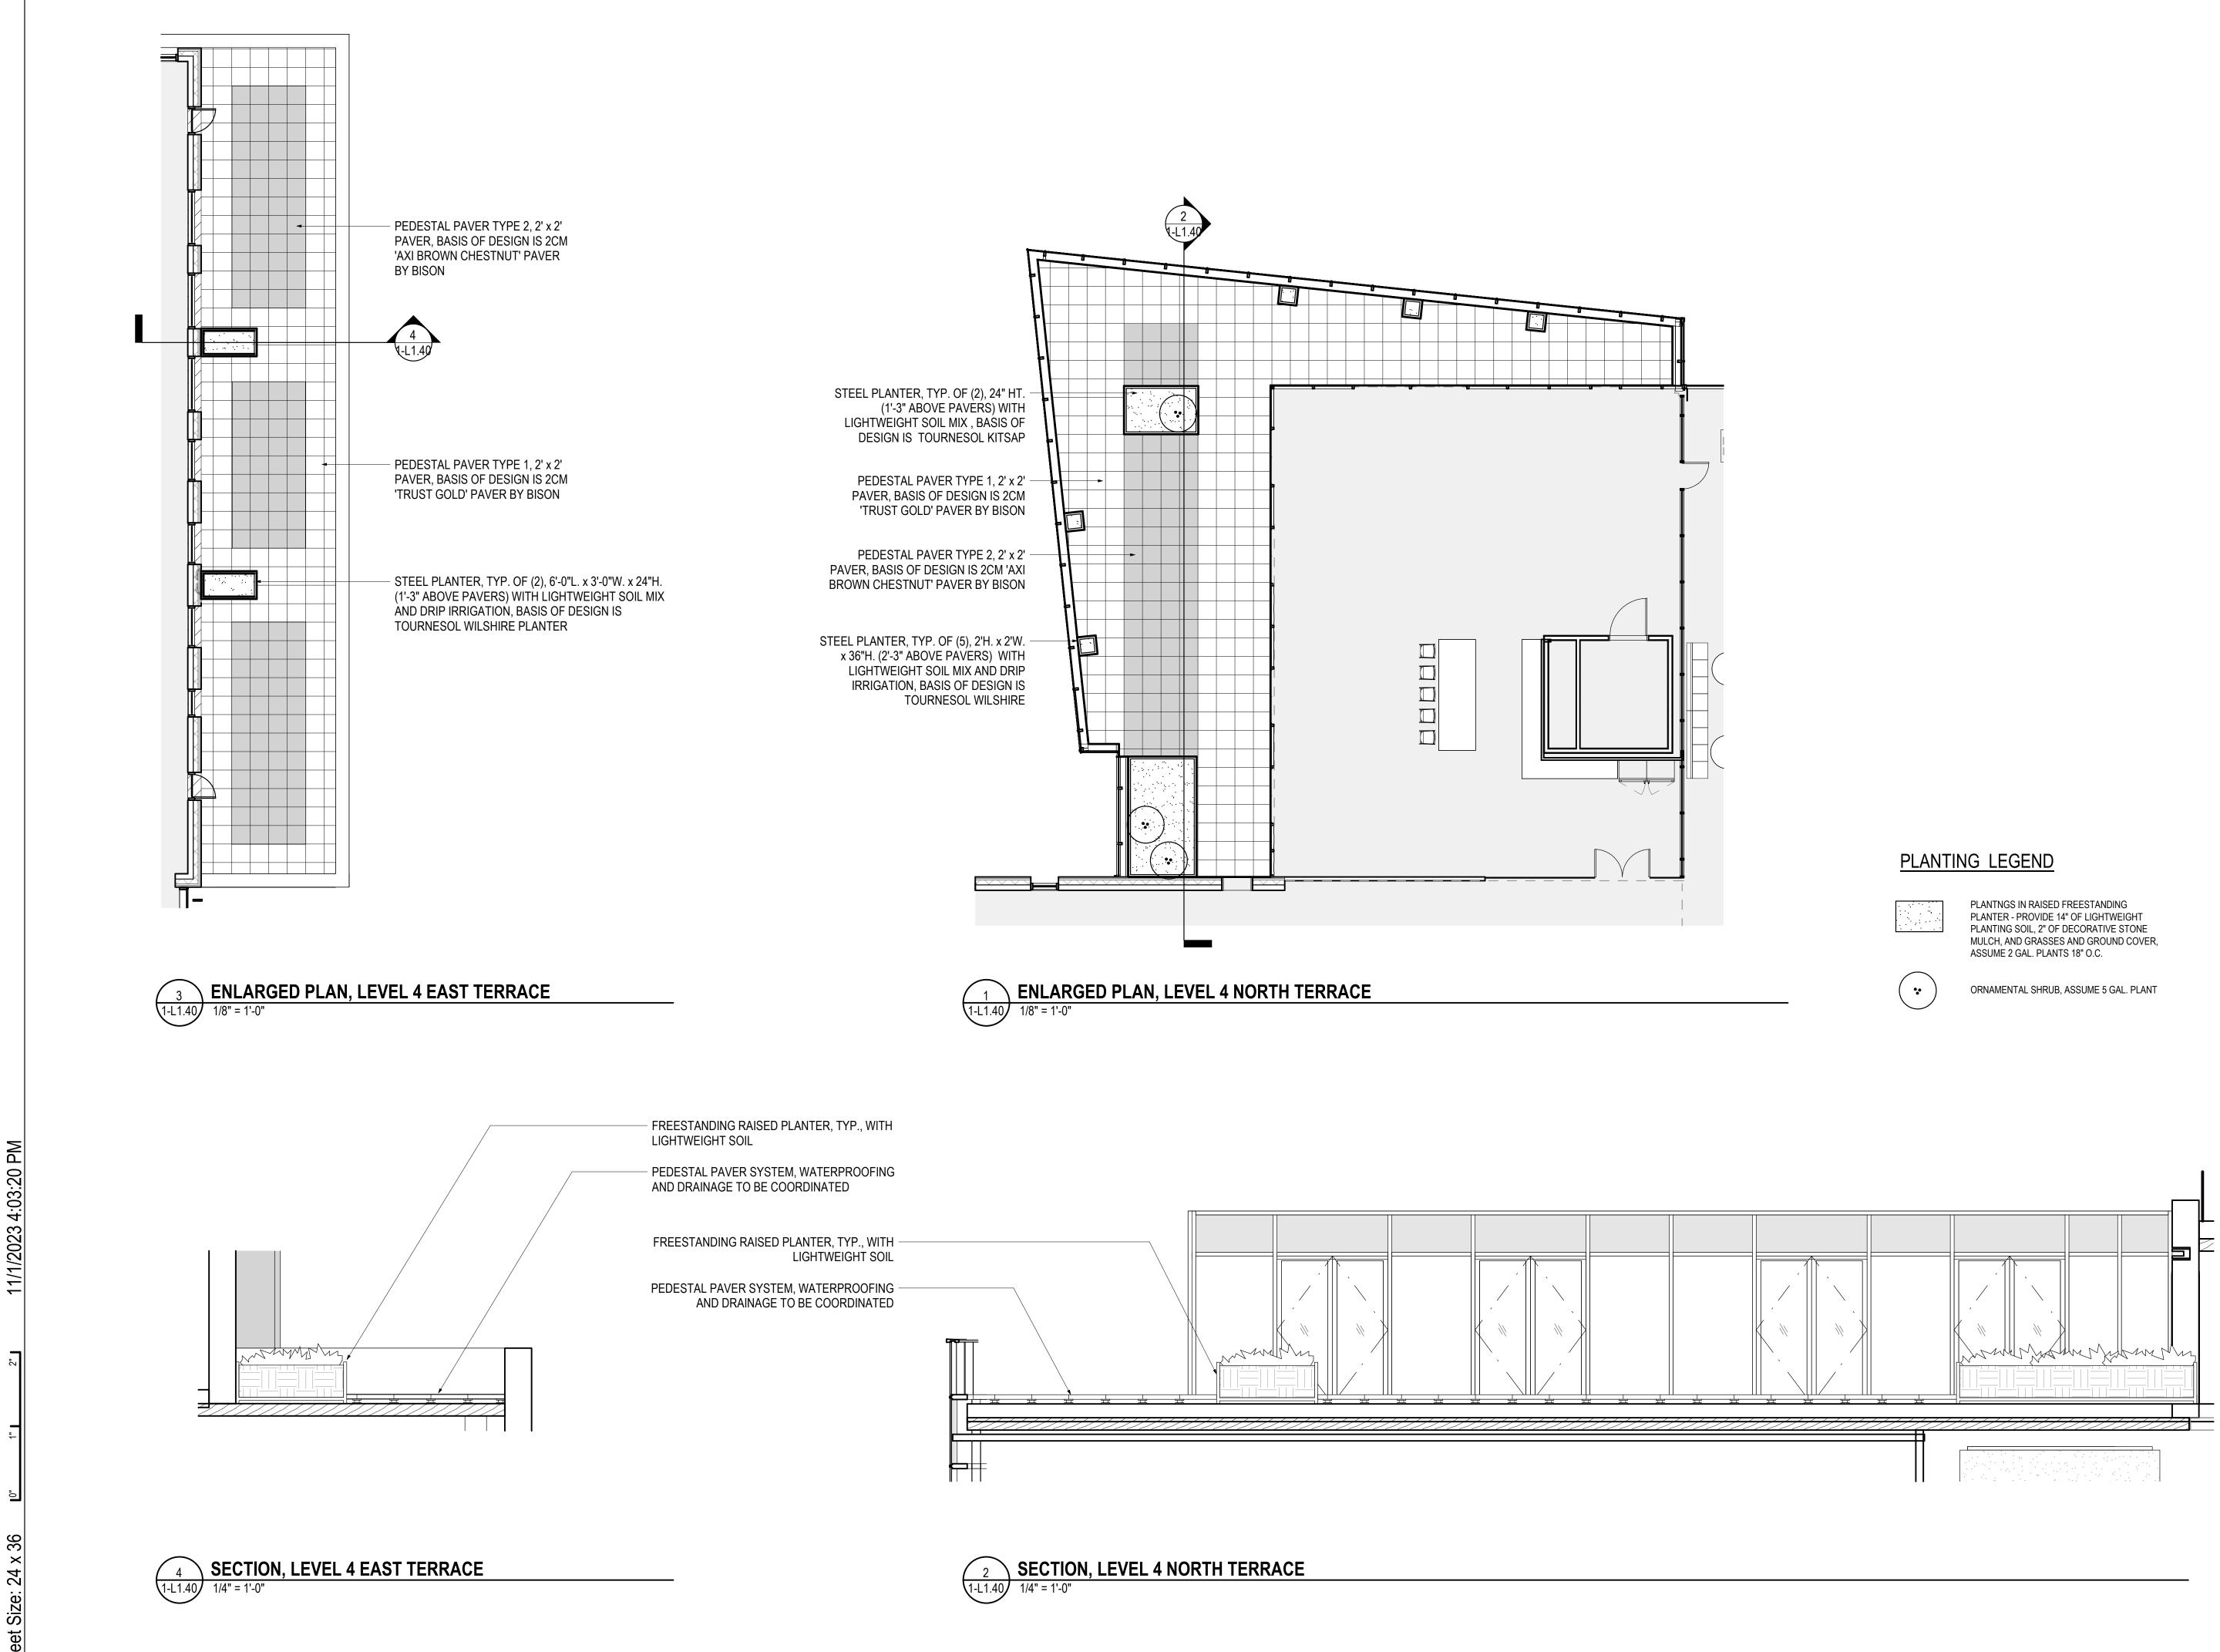CONCRETE BASIN, WHERE JOINTS OCCUR PROVIDE CAST WATER STOPS, CONTINUOUS

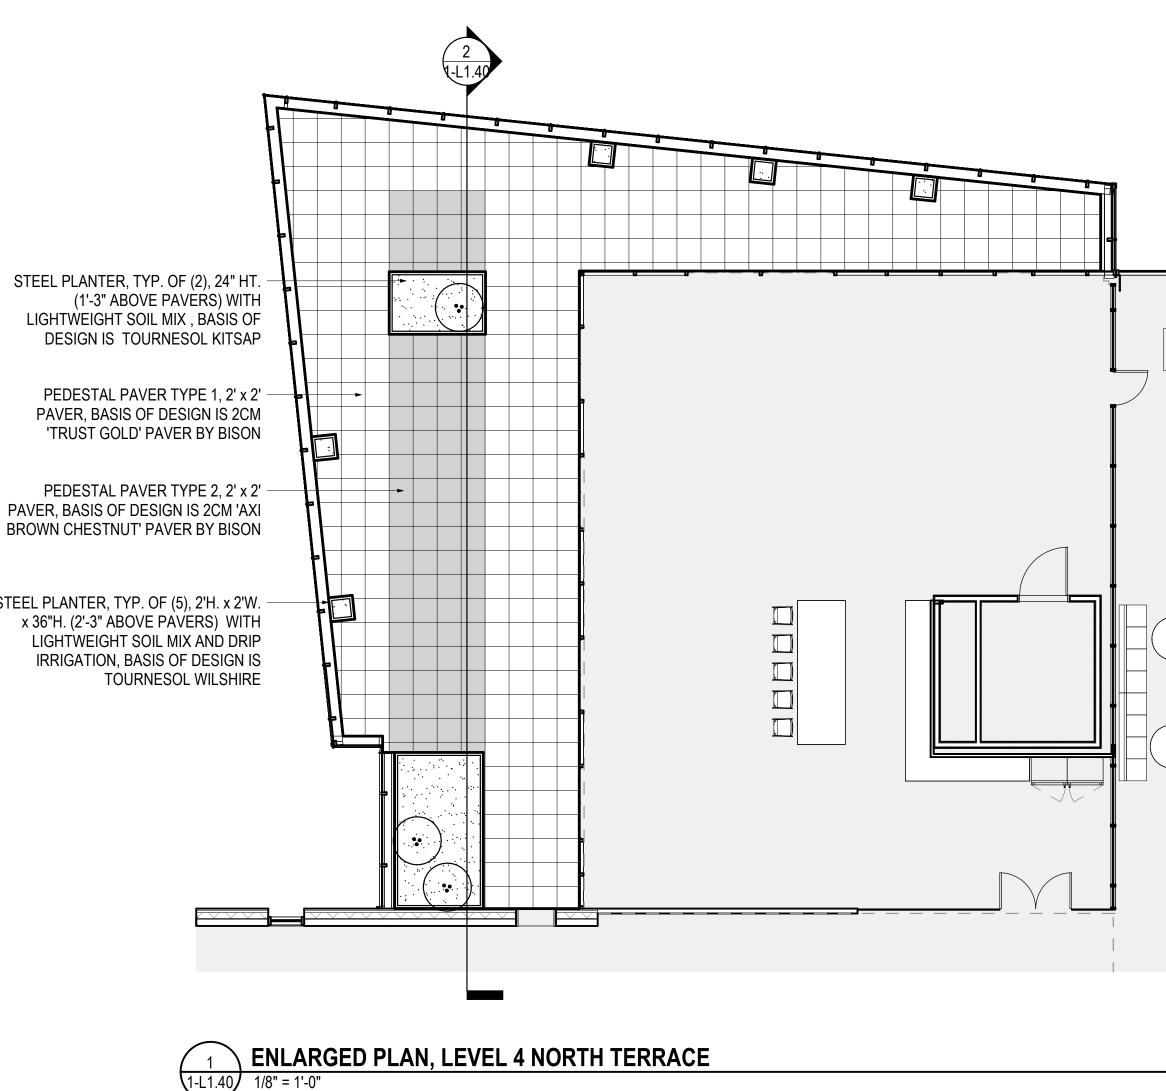SERVICE LINE AND DRAIN FITTING, LAP MEMBRANE OVER FLANGE OF FITTING.

WATER FEATURE RETURN CHANNEL (1-L1.41) 1" = 1'-0"

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WATER FEATURE SOURCE CHANNEL

1-L1.41 1" = 1'-0"


9"

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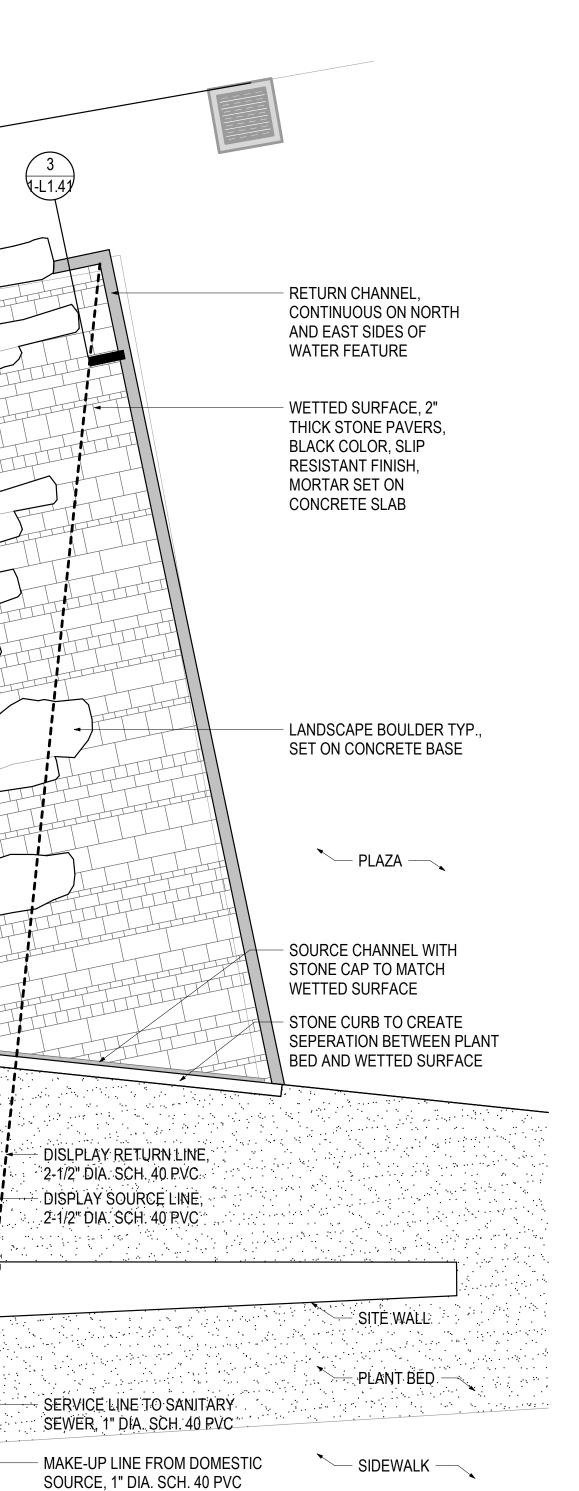
STONE CAP STONE VENEER ALUMINUM ANGLE STONE POOL FLOOR MORTAR SETTING BED, TYP.

WATERPROOF MEMBRANE, CONT. - CONCRETE BASIN

**REVERSIBLE SOURCE/DRAIN LINE** AND FITTING, LAP MEMBRANE OVER FLANGE OF FITTING



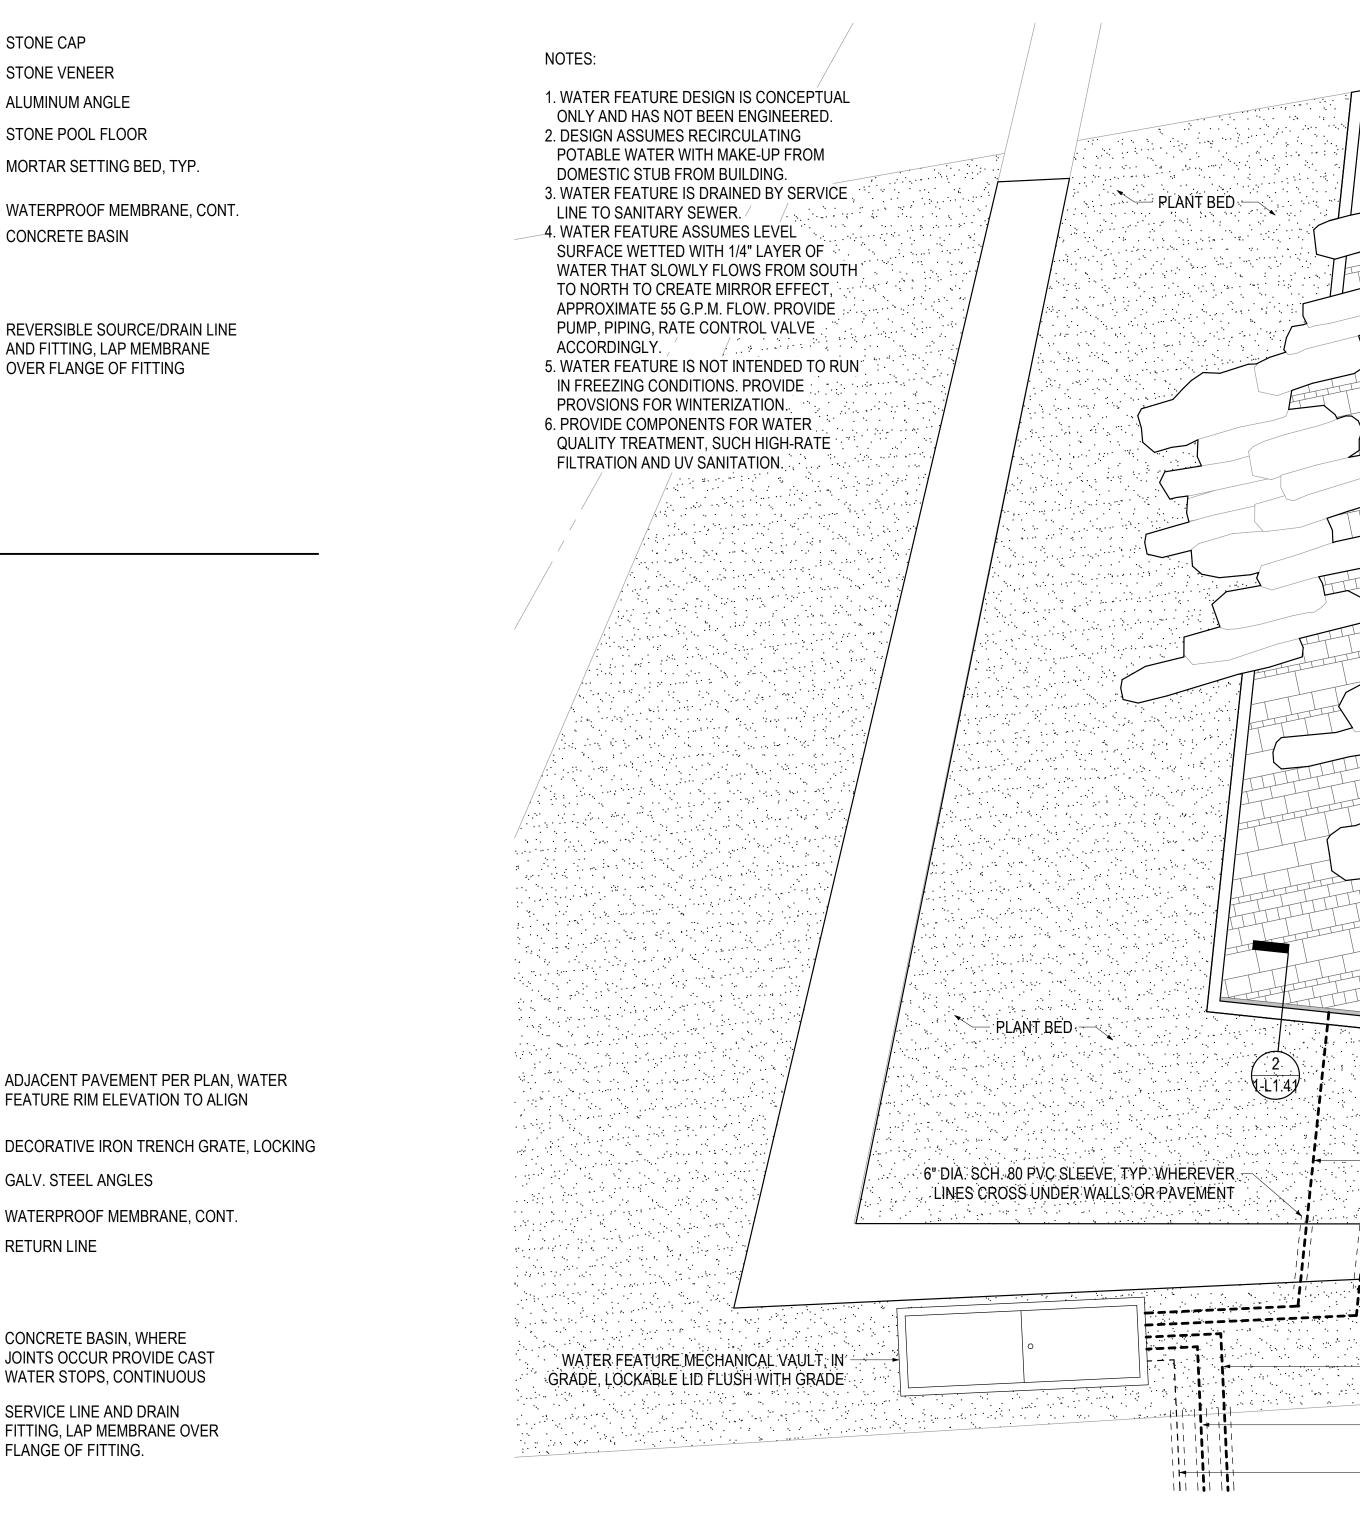



ELECTRICAL SERVICE



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**RENDERING - PASEO AND PLAZA** 



RENDERING - PLAZA STAIRS AND SITE WALL

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3D VIEWS - PLAZA

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1-L2.00

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**RENDERING - NORTH ENTRANCE** 



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ENTITLEMENTS STUDIO ARCHITECTURE 2995 55TH STREET, #17983 BOULDER, CO 80301 T 720 491 1167 LANDSCAPE

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**3D VIEWS-ENTRIES** 

Sheet Number



Current Issue SITE REVIEW

## CITY OF BOULDER **DESIGN AND CONSTRUCTION STANDARDS** 3.05 Tree Protection for Construction Sites

(A) Tree Protection Required (1) An applicant for construction approval shall protect trees and plants in the public right-of-way and on any project or construction site where public improvements are proposed.

(2) An applicant for construction approval shall submit a landscaping plan incorporating proposed tree protection measures for any existing trees located in the public right-of-way and on site at any project or construction site where public improvements are proposed in compliance with these Standards.

(3) The landscaping plan shall identify any potential detrimental effects to existing trees that might result from proposed construction activities within 20 feet of the dripline of any existing trees located on site or in the adjacent public right-of-way. The plan shall include the species, size, and location of all existing trees that are 1-inch or larger caliper size. If no existing trees are present that require protection, this shall be noted on the plan. Existing trees approved to be removed or relocated shall be clearly identified on the landscaping plan. (4) The applicant for construction approval shall notify the City within 24-hours of any suspected damage to trees resulting from construction activities. If damage occurs during construction, the applicant shall have the damaged tree restored immediately by a qualified arborist.

(B) Tree Protection Procedures

1) Protective Maintenance: An applicant for construction approval shall provide maintenance and care for existing trees required to be protected on site and in the public right-of-way adjacent to any project or construction site during construction activities and the public improvement warranty period to ensure that existing trees survive and are not damaged. (2) Soil Compaction Prevention

(a) To prevent soil compaction, designated routes for equipment and foot traffic by work crews shall be determined prior to commencing construction activities and indicated in the landscaping tree protection plan.

(b) These planned routes shall be marked at the site before construction commences with durable fencing material that is at least 4 feet high. Flagging tape or any other material that may be torn down, moved, or evaded is not acceptable.

(c) The contractor shall inform all construction crew members on the site of access routes and will ensure that only these routes are used.

(d) To prevent tree root smothering, no soil stockpiles, supplies, equipment, or any other material shall be placed or stored within a tree dripline or within 15 feet of the tree trunk for column-shaped trees, whichever distance is greater(e) Soil around a tree dripline may be required to be aerated during and after

construction activities. This is necessary even when compaction results from heavy foot traffic. A professional arborist shall do the vertical aeration or soil fracturing. Oil fracturing techniques comparable to using a "growgun" with Isolite material are acceptable. Conventional turf aeration is not acceptable

(f) When foot traffic or equipment use is unavoidable within the dripline, the area within the dripline shall be mulched with wood chips to a depth of 6 inches before construction activity begins. A 6-inch mulch depth shall be maintained for the

duration of the project, then removed when construction activities are completed. (3) Root Protection

(a) Tree roots shall not be cut unless cutting is unavoidable.

(b) When root cutting is unavoidable, a clean, sharp cut shall be made to avoid shredding or smashing. Root cuts should be made back to a lateral root. (c) Whenever possible, tree roots should be cut between late fall and bud opening, when root energy supplies are high and conditions are least favorable for disease causing

adents d) The City shall be notified of any cutting of the following roots:

Two roots having a diameter of more than 3 inches, or

) Four roots having diameters between 2 and 3 inches. (e) Trenches shall be hand-dug within the dripline in areas where roots 2 inches and larger in diameter are present, and when low branches which may be damaged by equipment are present.

(f) Whenever possible, roots 2 inches or larger in diameter shall be tunneled or bored under and shall be covered to prevent dehydration. Exposed roots shall be covered immediately with soil or burlap and kept moist.

(g) Power tools shall not be used to prune roots, with the exception of arboriculturally approved root-cutting equipment used under the supervision of the City. Only the following approved tools shall be acceptable: scissors-type hand pruners and loppers, except anvil-types, and arborist-type pruning saws.

(h) When more than one root 2 inches or larger in diameter on any public tree is cut, supplemental watering shall be provided if the tree lacks an operational sprinkler system. The applicant or abutting landowner shall provide the watering.

(i) Sidewalk and paving surfaces shall be sufficiently contoured to avoid cutting surface tree roots. Whenever possible, tree roots should be bridged or floated over with walks.

(i) To allow maximum aeration and water penetration to roots, walk materials other than concrete may be selected (e.g., brick, flagstone, honeycomb block, chips, gravel) subject to City approval. Under no circumstances shall impervious material make contact with or completely encircle a tree trunk.

(k) Auger tunneling, not trenching, shall be used where possible for utility placement within the dripline of a tree.

(I) If roots are cut between March and August, trees may need supplemental deep root watering once per week for at least 2 months after the roots are cut. When roots are cut between September 1 and October 15, trees may need supplemental watering once per week until at least October 31

(m) Tree roots shall not be fertilized for a period of 1 year following the cessation of construction activities. Thereafter, for the next 2 years, a light annual fertilization using a slow release nitrogen source is acceptable. (4) Tree Fencing

(a) Fencing material shall encircle any tree whose outer dripline edge is within 20 feet of any construction activities.

(b) Fencing material shall be a bright, contrasting color, durable, and at least 4 feet high. Fence posts shall be comparable to metal T-posts or heavier posts and placed at least 2 feet below ground.

(c) Fencing material shall be placed at the dripline or at least 15 feet from any tree trunk, whichever distance is greater, and maintained in an upright position throughout the duration of construction activities.

(d) The applicant for construction approval shall indicate fencing locations on the landscaping tree protection plan.

(e) Heavy objects, such as wood pallets or metal railings, shall not lean against or come into contact with any tree trunk.

(5) Grade Changes: Grade changes, such as removing topsoil or adding fill material, shall not occur within the dripline of any existing tree. If necessary as part of project or site development, retaining walls and tree wells to maintain the existing grade within the dripline

of any tree may be acceptable when constructed prior to site grading changes near the tree. A landscaping plan containing an illustrated design scheme of the tree protection improvement shall be approved by the City prior to initiating any grade changes near existing trees.


(6) Transplanting: Any proposed or required transplanting shall conform with the requirements in Section 3.04(D), "Tree Relocation (Transplanting)." (7) Chemical/Foreign Material Disposal


(a) Disposing of chemicals or foreign material anywhere on site or in the public

right-of-way is prohibited. This shall include, but is not limited to: paint, stain, solvents, concrete or any construction material onsite, and rinse water from any cans or tools containing chemicals.

(b) Soil samples may be taken to determine the presence of chemicals or foreign

materials for any planter containing proposed or existing plant material. (8) Pruning: Pruning shall not occur during construction activities or the public improvement warranty period, except to remove dead or damaged branches or to prevent branch damage that could occur during construction, without the prior approval of the City. Pruning of healthy branches shall be delayed for a period of 2 years after construction activities are completed

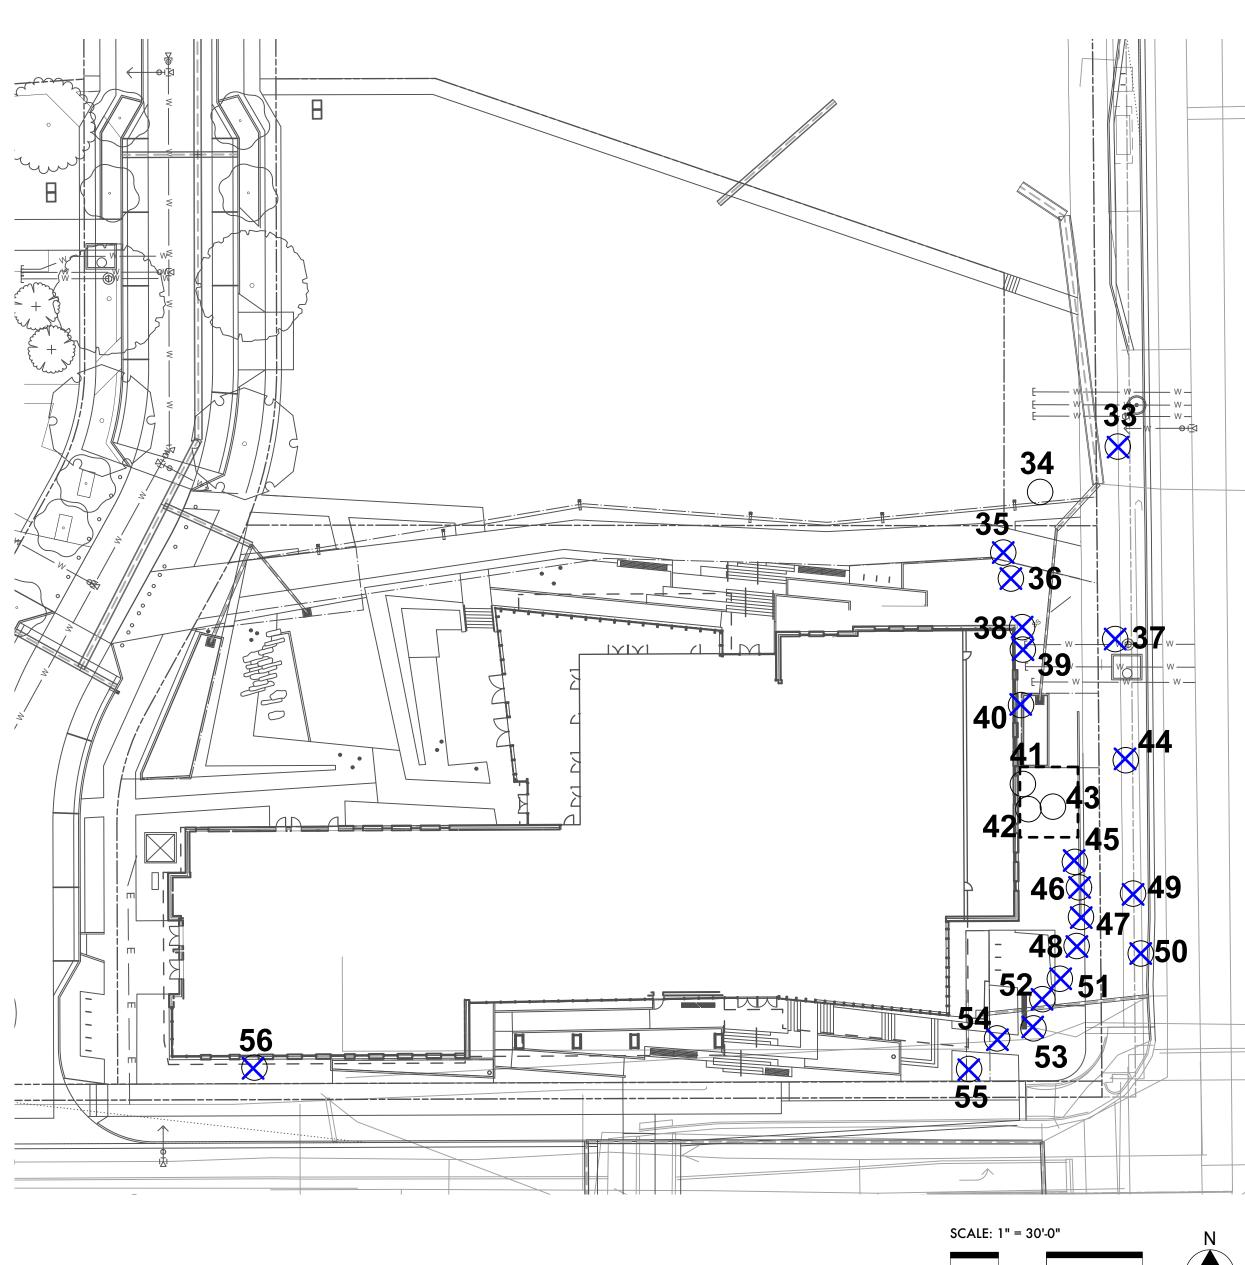

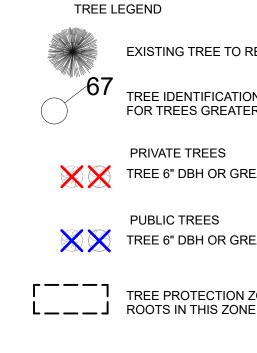

All tree protection standards of Ch. 3 and 10 of the Design and Construction Standards shall be met with particular attention given to grading impacts, limitations of stockpiling, soil compaction prevention and vehicular routes. Tree protection fencing shall be installed prior to any site disturbance and remain in place for the duration of the project. Only hand digging may occur within the dripline of any tree to be preserved. Provide sufficient irrigation throughout construction to maintain the long term health of the tree(s).

<b>D</b> #	Common Name	Scientific Name	DBH (in)	Condition Rating	Comments
5	Austrian pine	Pinus nigra	13.0	Good	Remove
6	Austrian pine	Pinus nigra	13.5	Good	Remove
57	Crabapple	Malus sp.	38.0	Good	Remove
8	Hawthorn	Crataegus sp.	6.0	Good	Remove
9	Hawthorn	Crataegus sp.	7.0	Good	Remove
10	Hawthorn	Crataegus sp.	8.0	Good	Remove
1	Austrian pine	Pinus nigra	15.5	Good	Try to keep
12	Austrian pine	Pinus nigra	17.0	Good	Try to keep
13	Austrian pine	Pinus nigra	16.0	Good	Try to keep
14	Red oak	Quercus rubra	7.5	Fair	Remove
15	Hawthorn	Crataegus sp.	6.0	Good	Remove
16	Hawthorn	Crataegus sp.	6.0	Good	Remove
17	Hawthorn	Crataegus sp.	6.0	Good	Remove
8	Hawthorn	Crataegus sp.	6.0	Good	Remove
19	Red oak	Quercus rubra	8.5	Fair	Remove
50	Red oak	Quercus rubra	7.5	Fair	Remove
51	Hawthorn	Crataegus sp.	6.0	Good	Remove
52	Hawthorn	Crataegus sp.	6.0	Good	Remove
53	Hawthorn	Crataegus sp.	6.0	Good	Remove
54	Austrian pine	Pinus nigra	16.0	Good	Remove
55	Austrian pine	Pinus nigra	17.0	Good	Remove
56	Quaking aspen	Populus tremuloides	12.0	Very Poor	Remove
<b>59</b>	Norway maple	Acer platanoides	6.0	Good	Remove
70	Norway maple	Acer platanoides	9.0	Good	Remove
71	Amur maple	Acer ginnala	8.0	Good	Remove
72	Norway maple	Acer platanoides	8.0	Good	Remove
73	Swamp white oak	Quercus bicolor	8.5	Good	Remove
74	Tree of heaven	Ailanthus altissima	11.0	Good	Remove
75	Tree of heaven	Ailanthus altissima	8.0	Poor	Remove
76	Tree of heaven	Ailanthus altissima	8.0	Poor	Remove
7	Tree of heaven	Ailanthus altissima	9.0	Poor	Remove
78	Tree of heaven	Ailanthus altissima	12.0	Poor	Remove
79	Red oak	Quercus rubra	6.0	Good	Off property
<b>30</b>	Honey locust	Gleditsia triacanthos	9.0	Fair	Remove
81	Honey locust	Gleditsia triacanthos	8.0	Good	Remove
32	Siberian elm	Ulmus pumila	14.5	Good	Remove
33	Siberian elm	Ulmus pumila	19.5	Good	Remove
34	Plains cottonwood	Populus deltoides ssp. monilifera	24.0	Good	Remove
85	Plains cottonwood	Populus deltoides ssp. monilifera	15.0	Poor	Remove
36	Plains cottonwood	Populus deltoides ssp. monilifera	19.0	Fair	Remove
<b>37</b>	Plains cottonwood	Populus deltoides ssp. monilifera	20.0	Fair	Remove

EXISTING TREE TO REMAIN

TREE IDENTIFICATION CIRCLE/NUMBER FOR TREES GREATER THAN 6" DBH

TREE 6" DBH OR GREATER TO BE REMOVED

TREE 6" DBH OR GREATER TO BE REMOVED


TREE PROTECTION ZONE. PROTECT ALL

# West City Campus Site **Tree Inventory**

# PRICING NOTE:

**ERC** 

CITY FORESTOR WILL ASSESS MITIGATION FEE FOR ALL HEALTHY PUBLIC TREES TO BE REMOVED. NEW TREES PLANTED CAN OFFSET THIS FEE.

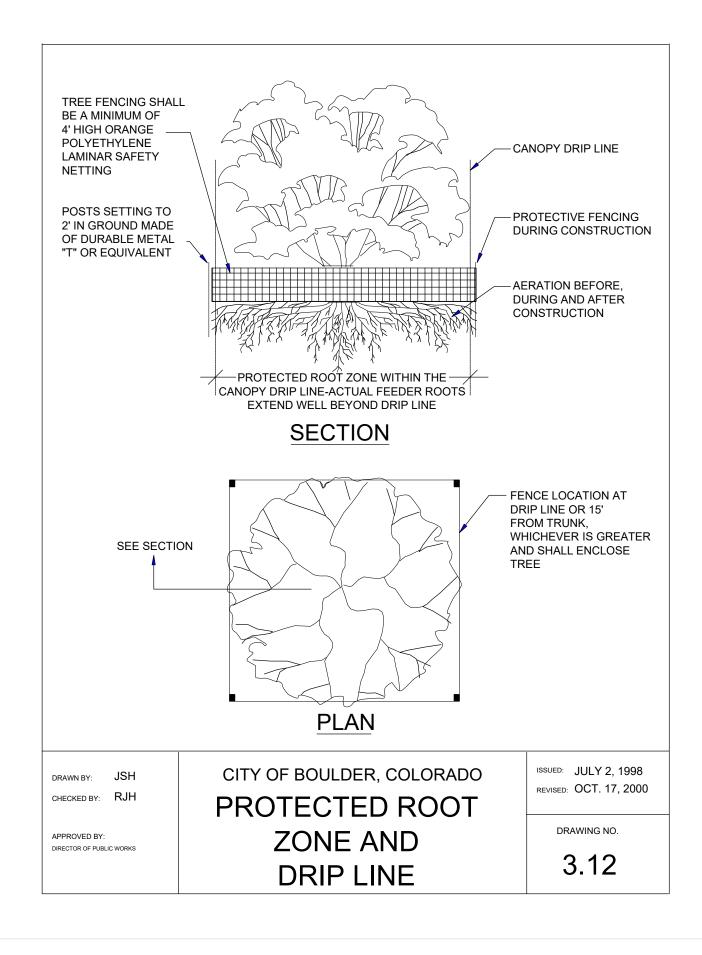



DENVER LOS ANGELES NEW YORK PORTLAND SEATTLE WASHINGTON, DC VANCOUVER, BC

1350 17th Street Suite 202 Denver, Colorado 80202 303.557.6420 www.zgf.com Consultant

CIVIL THE SANITAS GROUP 901 FRONT STREET, SUITE 350 LOUISVILLE, CO 80027 T 303 481 2710

ENTITLEMENTS STUDIO ARCHITECTURE 2995 55TH STREET, #1798 BOULDER, CO 80301 T 720 491 1167

LANDSCAPE STUDIO TERRA INC 758 CLUB CIRCLE LOUISVILLE, CO 8002 T 303 494 9138

STRUCTURAL ANTHEM STRUCTURAL ENGINEERS FLATIRON OFFICE PAR 2213 CENTRAL AVENU BOULDER, CO 80301 T 303 848 8497

MFP BRANCH PATTER 3344 WALNUT STREE **DENVER, CO 80205** T 303 382 1920

LIGHTING AE DESIGN 1900 WAZEE STREET, #20 DENVER, CO 80202 T 303 296 3034

AV/TECHNOLOGY/SECURITY SALAS O'BRIEN 4900 NAUTILUS CT. N. SUITE 200

BOULDER, CO 80301 T 303 865 5500

Full Design Team Roster on Sheet 1-G0.01 Client and Project Information



Boulder Western City Campus - Volume 1-Pavilion Office Building 1155 Alpine Ave Boulder, CO 80302

Original Issue

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OVALS



Current Issue SITE REVIEW

# **PLANT SCHEDULE**

						CDDEAD		EVERCLIPE		CEACON
KEY	SIZE				HEIGHT		WATER USE		FLOWER COLOR	SEASON
MTC RU	1 GAL	TBD	ACHILLEA MILLEFOLIUM 'TERRA COTTA'		18-24" 2. 2'	18-24" 2. 21	LOW	SUN	PEACH	SUMMER
	1 GAL	TBD	AGASTACHE RUPESTRIS	SUNSET HYSSOP	2-3'	2-3'	LOW	SUN	ORANGE PINK	SUMMER TO FALL
IMG	1 GAL	TBD	ALYSSUM MONTANUM 'MOUNTAIN GOLD'	MOUNTAIN BASKET OF GOLD	6-12"	12-18"				
OE	1 GAL	TBD	AQUILEGIA COERULEA		18-24"	12-18"	MEDIUM		E BLUE WITH WHITE CENTER	LATE SPRING TO EARLY SUMM
CC	1 GAL	TBD	ARCTOSTAPHYLOS X COLORADOENSIS CHIEFTAN	CHIEFTAN MANZANITA	3-4'	5-6;	LOW	SUN TO FILTERED SHADE	SOFT PINK	
	1 GAL	TBD	CERATOSTIGMA PLUMBAGINOIDES	PLUMBAGO	8-12"	18-24"	LOW	ADAPTABLE	BLUE	MID TO LATE SUMMER
Z	1 GAL	TBD	COREOPSIS VERTICILLATA 'ZAGREB'	ZAGREB COREOPSIS	12-18"	12-18"	LOW	SUN	GOLD	MID-SUMMER TO FALL
C	1 GAL	TBD	EUONUMUS FORTUNEI 'COLORATUS'	PURPLELEAF WINTERCREEPER	12-18"	3-6'	LOW	ADAPTABLE	INSIGNIFICANT	EARLY SUMMER
1	1 GAL	TBD	GERANIUM VISCOSISSIMUM	STICKY GERANIUM	1-3'	18-24"	LOW	ADAPTABLE	ROSE-PURPLE	LATE SPRING TO SUMMER
FM	1 GAL	TBD	MONARDA FISTULOSA MENTHIFOLIA	NATIVE LAVENDER BEE-BALM	2-3'	18-24"	LOW	SUN	LAVENDER	MID-SUMMER
1C	1 GAL	TBD	PENSTEMON X MEXICALI 'CAROLYN'S HOPE'	CAROLYN'S HOPE PINK PENSTEMON	12-15"	8-12"	LOW	SUN	PINK	SPRING TO SUMMER
TR	1 GAL	TBD	PEROVSKIA ATRIPLICIFOLIA	RUSSIAN SAGE	3-4'	3-4'	VERY LOW	SUN	BLUE	MID TO LATE SUMMER
G	1 GAL	TBD	ZINNIA GRANDLIFLORA 'GOLD ON BLUE'	GOLD ON BLUE ROCKY MOUNTAIN ZINNIA	6-8"	8-12"	VERY LOW	SUN	GOLDEN YELLOW	MID TO LATE SUMMER
NAMENT	TAL GRASSES									
· · · · · · · · · · · · · · · · · · ·	SIZE	QUANTITY	BOTANICAL NAME		HEIGHT	SPREAD	WATER USE	EXPOSURE	FLOWER COLOR	SEASON
	1 GAL	TBD	ACHNATHERUM CALAMAGROSTIS	UNDAUNTED APLINE PLUME GRASS	2-3'	2-3'	LOW	SUN	TAN	MID-SUMMER
W	1 GAL	TBD	ANDROPOGON GERARDII WINDWALKER	WINDWALKER BIG BLUESTEM GRASS	4-6'	2-3'	LOW	SUN	PURPLE	SUMMER
	1 GAL	TBD	CALAMAGROSTIS BRACHYTRICHA	KOREAN FEATHER REED GRASS	3-4'	2-3'	LOW	SUN TO FILTERED SHADE	PINKISH-TAN	LATE SUMMER
	1 GAL	TBD	MUHLENBERGIA REVERCHONII UNDAUNTED	UNDAUNTED RUBY MUHLY GRASS	15-30"	18-24"	LOW	SUN	RUBY-PINK	FALL
5	1 GAL	TBD	SCHIZACHYRIUM SCOPARIUM 'STANDING OVATION'	STANDING OVATION LITTLE BLUESTEM GRASS	3-4'	12-18"	LOW	SUN	SILVER	LATE SUMMER
, Т	1 GAL	TBD	SORGHASTRUM NUTANS 'THIN MAN'	THIN MAN INDIAN GRASS	5-7'	2-3'	LOW	SUN	YELLOW	SUMMER
	1 0/12	100			3,	2.5	2011	5011		SOMMEN
	S SHRUBS					000000				
,	5 GAL	QUANTITY TBD	BOTANICAL NAME           AMORPHA NANA	DWARF FALSE INDIGO	HEIGHT 1-2'	SPREAD 1-2'	VERY LOW	SUN	PURPLE	SUMMER
L	5 GAL	TBD	ARONIA MELANOCARPA LOW SCAPE MOUND	LOW SCAPE MOUND BLACK CHOKEBERRY	1-2'	18-24"	LOW	ADAPTABLE	WHITE	
2	5 GAL	TBD	BUDDLEJA 'BLUE CHIP'	DWARF PURPLE-BLUE BUTTERFLY BUSH	24-30"	2-4'	MEDIUM	SUN	PURPLE-BLUE	SUMMER TO FALL
Л	5 GAL	TBD	CHAMAEBATIARIA MILLEFOLIUM	FERNBUSH	3-5'	3-6'	VERY LOW	SUN	WHITE	MID TO LATE SPRING
	5 GAL	TBD	DAPHNE X BURKWOODII 'CAROL MACKIE'	CAROL MACKIE DAPHNE	3-5'	3-5'	MEDIUM	FILTERED SHADE TO SHADE		SPRING
	5 GAL	TBD	EUONYMUS FORTUNEI 'EMERALD GAIETY'	EMERALD GAIETY EUONYMUS	18-24"	3-4'	MEDIUM	FILTERED SHADE TO SHADE	E N/A	EARLY SUMMER
	5 GAL	TBD	FALLUGIA PARADOXA	APACHE PLUME	3-6'	3-6'	VERY LOW	SUN	WHITE	SUMMER
	5 GAL	TBD	HESPERALOE PARVIFLORA	RED FALSE YUCCA	3-4'	3-4'	VERY LOW	SUN	RED TO ORANGE-RED	SUMMER
(	5 GAL	TBD	HESPERALOE PARVIFLORA 'YELLOW'	YELLOW FALSE YUCCA	3-4'	3-4'	VERY LOW	SUN	YELLOW	SUMMER
	5 GAL	TBD	LIGUSTRUM VULGARE 'LODENSE'	LODENSE PRIVET	2-3'	3-4'	LOW	SUN TO FILTERED SHADE	WHITE	EARLY SUMMER
	5 GAL	TBD	PHILADELPHUS X 'SNOWBELLE'	SNOWBELLE MOCKORANGE	3-4'	3-4'	LOW	SUN	WHITE	LATE SPRING TO EARLY SUMM
N	5 GAL	TBD	PHYSOCARPUS OPULIFOLIUS 'NANUS'	DWARF NINEBARK	4-5'	4-5'	LOW	SUN TO FILTERED SHADE	WHITE	LATE SPRING
PB	5 GAL	TBD	PRUNUS BESSEYI PAWNEE BUTTES	CREEPING WESTER SAND CHEERY	15-30"	4-6'	LOW	SUN	WHITE	SPRING
G	5 GAL	TBD	RHUS AROMATICA 'GRO-LOW'	DWARF FRAGRANT SUMAC	2-3'	6-8'	LOW	SUN	YELLOW	EARLY SPRING
	5 GAL	TBD	RIBES ALPINUM	ALPINE CURRANT	2 S 3-6'	3-6'	LOW	SUN TO FILTERED SHADE	YELLOWISH-GREEN	MID-SPRING
/	5 GAL	TBD	ROSA WOODSII	WOODS' ROSE	3-6'	3-6'	LOW	SUN	PINK	EARLY SUMMER
ERGREEN Y	SIZE	QUANTITY	BOTANICAL NAME		HEIGHT	SPREAD	WATER USE	EXPOSURE	COLOR	SEASON
	5 GAL	TBD	JUNIPERUS COMMUNIS 'GREEN CARPET'	GREEN CARPET JUNIPER	8-10"	2-3'	LOW	SUN	N/A	N/A
	5 GAL	TBD	JUNIPERUS HORIZONTALIS ICEE BLUE	ICEE BLUE JUNIPER	2-4"	6-8'	LOW	SUN	N/A	N/A
	5 GAL	TBD	JUNIPERUS SABINA CALGARY CARPET	CALGARY CARPET JUNIPER	2-4 12-18"	6-8'		SUN TO FILTERED SHADE	N/A	N/A N/A
						0-8 2-3'	LOW		•	•
C	5 GAL	TBD			2-3'	-	LOW	SHADE	YELLOW	MID-SPRING
W	5 GAL	TBD	PINUS MUGO 'WHITE BUD' PINUS SYLVESTRIS 'ALBYN PROSTRATA'	WHITE BUD MUGO PINE SPREADING SCOTS PINE	2-3' 2'	3-4' 8'	LOW LOW	SUN TO FILTERED SHADE SUN	N/A N/A	N/A N/A
	5 G A I		THOS STEVESTING ALDIN THOSTHATA	STREADING SCOTS TIME	2	0	LOW	501		
r	5 GAL	TBD								
NAMENT	TAL TREES	_								
NAMENT	TAL TREES	QUANTITY				SPREAD	WATER USE	EXPOSURE	COLOR	SEASON
NAMENT (	TAL TREES SIZE 2.0" CAL	QUANTITY	AMELANCHIER LAEVIS SPRING FLURRY	SPRING FLURRY ALLEGHENY SERVICEBERRY	20-35'	15-20'	LOW	SUN	WHITE	SPRING
NAMENT Y AG	TAL TREES SIZE 2.0" CAL 2.0" CAL	QUANTITY	2 AMELANCHIER LAEVIS SPRING FLURRY 3 ACER RUBRUM ARMSTRONG GOLD	SPRING FLURRY ALLEGHENY SERVICEBERRY ARMSTRONG GOLD RED MAPLE	20-35' 30-40'	15-20' 10-12'	LOW MEDIUM	SUN SUN	WHITE N/A	SPRING N/A
NAMENT Y AG H	SIZE           2.0" CAL           2.0" CAL           2.0" CAL           2.0" CAL	QUANTITY	AMELANCHIER LAEVIS SPRING FLURRY ACER RUBRUM ARMSTRONG GOLD ACER TATARICUM HOT WINGS	SPRING FLURRY ALLEGHENY SERVICEBERRY ARMSTRONG GOLD RED MAPLE HOT WINGS TATARIAN MAPLE	20-35' 30-40' 15-20'	15-20' 10-12' 15-20'	LOW MEDIUM LOW	SUN SUN ADAPTABLE	WHITE N/A GREENISH-WHITE	SPRING N/A SPRING
AG 1	SIZE           2.0" CAL           2.0" CAL           2.0" CAL           2.0" CAL           2.0" CAL           2.0" CAL	QUANTITY	2 AMELANCHIER LAEVIS SPRING FLURRY 3 ACER RUBRUM ARMSTRONG GOLD 3 ACER TATARICUM HOT WINGS 3 CRATAEGUS AMBIGUA	SPRING FLURRY ALLEGHENY SERVICEBERRY ARMSTRONG GOLD RED MAPLE HOT WINGS TATARIAN MAPLE RUSSIAN HAWTHORN	20-35' 30-40' 15-20' 15-25'	15-20' 10-12' 15-20' 15-20'	LOW MEDIUM LOW LOW	SUN SUN ADAPTABLE SUN TO FILTERED SHADE	WHITE N/A GREENISH-WHITE WHITE	SPRING N/A SPRING SPRING
NAMENT Y AG H VI S	SIZE           2.0" CAL	QUANTITY	AMELANCHIER LAEVIS SPRING FLURRY ACER RUBRUM ARMSTRONG GOLD ACER TATARICUM HOT WINGS CRATAEGUS AMBIGUA MALUS 'SPRING SNOW'	SPRING FLURRY ALLEGHENY SERVICEBERRY ARMSTRONG GOLD RED MAPLE HOT WINGS TATARIAN MAPLE RUSSIAN HAWTHORN SPRING SNOW CRABAPPLE	20-35' 30-40' 15-20' 15-25' 20-25'	15-20' 10-12' 15-20' 15-20' 20-25'	LOW MEDIUM LOW LOW MEDIUM	SUN SUN ADAPTABLE SUN TO FILTERED SHADE SUN	WHITE N/A GREENISH-WHITE WHITE WHITE	SPRING N/A SPRING SPRING SPRING
NAMENT 7 AG H VI S M	SIZE           2.0" CAL	QUANTITY	AMELANCHIER LAEVIS SPRING FLURRY ACER RUBRUM ARMSTRONG GOLD ACER TATARICUM HOT WINGS CRATAEGUS AMBIGUA MALUS 'SPRING SNOW' PRUNUS PADUS 'MERLOT'	SPRING FLURRY ALLEGHENY SERVICEBERRY ARMSTRONG GOLD RED MAPLE HOT WINGS TATARIAN MAPLE RUSSIAN HAWTHORN SPRING SNOW CRABAPPLE PURPLE LEAF MAYDAY TREE	20-35' 30-40' 15-20' 15-25' 20-25' 15-20'	15-20' 10-12' 15-20' 15-20' 20-25' 15-20'	LOW MEDIUM LOW LOW MEDIUM MEDIUM	SUN SUN ADAPTABLE SUN TO FILTERED SHADE SUN ADAPTABLE	WHITE N/A GREENISH-WHITE WHITE WHITE WHITE	SPRING N/A SPRING SPRING SPRING SPRING
AG AG A A A A A A A A	SIZE           2.0" CAL	QUANTITY	2 AMELANCHIER LAEVIS SPRING FLURRY 3 ACER RUBRUM ARMSTRONG GOLD 3 ACER TATARICUM HOT WINGS 3 CRATAEGUS AMBIGUA 5 MALUS 'SPRING SNOW' 4 PRUNUS PADUS 'MERLOT' 3 PYRUS CALLERYANA 'CHANTICLEER'	SPRING FLURRY ALLEGHENY SERVICEBERRY ARMSTRONG GOLD RED MAPLE HOT WINGS TATARIAN MAPLE RUSSIAN HAWTHORN SPRING SNOW CRABAPPLE	20-35' 30-40' 15-20' 15-25' 20-25' 15-20' 20-30'	15-20' 10-12' 15-20' 15-20' 20-25' 15-20' 15-20'	LOW MEDIUM LOW LOW MEDIUM MEDIUM MEDIUM	SUN SUN ADAPTABLE SUN TO FILTERED SHADE SUN ADAPTABLE SUN	WHITE N/A GREENISH-WHITE WHITE WHITE WHITE WHITE	SPRING N/A SPRING SPRING SPRING SPRING SPRING
AG AG A A A A A A A A A A	SIZE           2.0" CAL	QUANTITY	2 AMELANCHIER LAEVIS SPRING FLURRY 3 ACER RUBRUM ARMSTRONG GOLD 3 ACER TATARICUM HOT WINGS 3 CRATAEGUS AMBIGUA 5 MALUS 'SPRING SNOW' 4 PRUNUS PADUS 'MERLOT' 3 PYRUS CALLERYANA 'CHANTICLEER' 3 PYRUS CALLERYANA JACK	SPRING FLURRY ALLEGHENY SERVICEBERRY ARMSTRONG GOLD RED MAPLE HOT WINGS TATARIAN MAPLE RUSSIAN HAWTHORN SPRING SNOW CRABAPPLE PURPLE LEAF MAYDAY TREE	20-35' 30-40' 15-20' 15-25' 20-25' 15-20'	15-20' 10-12' 15-20' 15-20' 20-25' 15-20'	LOW MEDIUM LOW LOW MEDIUM MEDIUM	SUN SUN ADAPTABLE SUN TO FILTERED SHADE SUN ADAPTABLE	WHITE N/A GREENISH-WHITE WHITE WHITE WHITE	SPRING N/A SPRING SPRING SPRING SPRING
NAMENT AG 1 A 5 A	SIZE           2.0" CAL	QUANTITY	2 AMELANCHIER LAEVIS SPRING FLURRY 3 ACER RUBRUM ARMSTRONG GOLD 3 ACER TATARICUM HOT WINGS 3 CRATAEGUS AMBIGUA 5 MALUS 'SPRING SNOW' 4 PRUNUS PADUS 'MERLOT' 3 PYRUS CALLERYANA 'CHANTICLEER' 3 PYRUS CALLERYANA JACK	SPRING FLURRY ALLEGHENY SERVICEBERRY ARMSTRONG GOLD RED MAPLE HOT WINGS TATARIAN MAPLE RUSSIAN HAWTHORN SPRING SNOW CRABAPPLE PURPLE LEAF MAYDAY TREE CHANTICLEER PEAR	20-35' 30-40' 15-20' 15-25' 20-25' 15-20' 20-30'	15-20' 10-12' 15-20' 15-20' 20-25' 15-20' 15-20'	LOW MEDIUM LOW LOW MEDIUM MEDIUM MEDIUM	SUN SUN ADAPTABLE SUN TO FILTERED SHADE SUN ADAPTABLE SUN	WHITE N/A GREENISH-WHITE WHITE WHITE WHITE WHITE	SPRING N/A SPRING SPRING SPRING SPRING SPRING
AG AG M SS M C J <b>ADE TRE</b>	SIZE           2.0" CAL	QUANTITY	2 AMELANCHIER LAEVIS SPRING FLURRY 3 ACER RUBRUM ARMSTRONG GOLD 3 ACER TATARICUM HOT WINGS 3 CRATAEGUS AMBIGUA 5 MALUS 'SPRING SNOW' 4 PRUNUS PADUS 'MERLOT' 3 PYRUS CALLERYANA 'CHANTICLEER' 3 PYRUS CALLERYANA JACK	SPRING FLURRY ALLEGHENY SERVICEBERRY ARMSTRONG GOLD RED MAPLE HOT WINGS TATARIAN MAPLE RUSSIAN HAWTHORN SPRING SNOW CRABAPPLE PURPLE LEAF MAYDAY TREE CHANTICLEER PEAR	20-35' 30-40' 15-20' 15-25' 20-25' 15-20' 20-30' 14-16'	15-20' 10-12' 15-20' 15-20' 20-25' 15-20' 15-20'	LOW MEDIUM LOW LOW MEDIUM MEDIUM MEDIUM	SUN SUN ADAPTABLE SUN TO FILTERED SHADE SUN ADAPTABLE SUN	WHITE N/A GREENISH-WHITE WHITE WHITE WHITE WHITE	SPRING N/A SPRING SPRING SPRING SPRING SPRING
A RNAMENT Y S AG H M SS M C J IADE TRE Y GRM	SIZE           2.0" CAL	QUANTITY 2 QUANTITY	2 AMELANCHIER LAEVIS SPRING FLURRY 3 ACER RUBRUM ARMSTRONG GOLD 3 ACER TATARICUM HOT WINGS 3 CRATAEGUS AMBIGUA 5 MALUS 'SPRING SNOW' 4 PRUNUS PADUS 'MERLOT' 3 PYRUS CALLERYANA 'CHANTICLEER' 3 PYRUS CALLERYANA JACK	SPRING FLURRY ALLEGHENY SERVICEBERRY ARMSTRONG GOLD RED MAPLE HOT WINGS TATARIAN MAPLE RUSSIAN HAWTHORN SPRING SNOW CRABAPPLE PURPLE LEAF MAYDAY TREE CHANTICLEER PEAR PEAR JACK	20-35' 30-40' 15-20' 15-25' 20-25' 15-20' 20-30' 14-16'	15-20' 10-12' 15-20' 15-20' 20-25' 15-20' 15-20' 8-10'	LOW MEDIUM LOW MEDIUM MEDIUM MEDIUM MEDIUM	SUN SUN ADAPTABLE SUN TO FILTERED SHADE SUN ADAPTABLE SUN SUN	WHITE N/A GREENISH-WHITE WHITE WHITE WHITE WHITE WHITE	SPRING N/A SPRING SPRING SPRING SPRING SPRING
RNAMENT Y S AG H M SS M C J ADE TRE Y	SIZE         2.0" CAL         SIZE	QUANTITY 2 QUANTITY	AMELANCHIER LAEVIS SPRING FLURRY ACER RUBRUM ARMSTRONG GOLD ACER TATARICUM HOT WINGS CRATAEGUS AMBIGUA MALUS 'SPRING SNOW' PRUNUS PADUS 'MERLOT' PYRUS CALLERYANA 'CHANTICLEER' PYRUS CALLERYANA JACK	SPRING FLURRY ALLEGHENY SERVICEBERRY ARMSTRONG GOLD RED MAPLE HOT WINGS TATARIAN MAPLE RUSSIAN HAWTHORN SPRING SNOW CRABAPPLE PURPLE LEAF MAYDAY TREE CHANTICLEER PEAR PEAR JACK COMMON NAME	20-35' 30-40' 15-20' 15-25' 20-25' 15-20' 20-30' 14-16' HEIGHT	15-20' 10-12' 15-20' 15-20' 20-25' 15-20' 15-20' 8-10' SPREAD	LOW MEDIUM LOW MEDIUM MEDIUM MEDIUM MEDIUM	SUN SUN ADAPTABLE SUN TO FILTERED SHADE SUN ADAPTABLE SUN SUN	WHITE N/A GREENISH-WHITE WHITE WHITE WHITE WHITE WHITE	SPRING N/A SPRING SPRING SPRING SPRING SPRING SPRING SPRING
AG AG M SS M C J ADE TRE	TAL TREES         SIZE         2.0" CAL	QUANTITY 2 QUANTITY	AMELANCHIER LAEVIS SPRING FLURRY     ACER RUBRUM ARMSTRONG GOLD     ACER TATARICUM HOT WINGS     CRATAEGUS AMBIGUA     MALUS 'SPRING SNOW'     PRUNUS PADUS 'MERLOT'     PYRUS CALLERYANA 'CHANTICLEER'     PYRUS CALLERYANA JACK     BOTANICAL NAME     ACER GRANDIDENTATUM ROCKY MOUNTAIN GLOW	SPRING FLURRY ALLEGHENY SERVICEBERRY ARMSTRONG GOLD RED MAPLE HOT WINGS TATARIAN MAPLE RUSSIAN HAWTHORN SPRING SNOW CRABAPPLE PURPLE LEAF MAYDAY TREE CHANTICLEER PEAR PEAR JACK COMMON NAME ROCKY MOUNTAIN GLOW MAPLE WESTERN HACKBERRY	20-35' 30-40' 15-20' 15-25' 20-25' 15-20' 20-30' 14-16' <b>HEIGHT</b> 20-30' 50-60'	15-20' 10-12' 15-20' 20-25' 15-20' 15-20' 8-10' <b>SPREAD</b> 20-30' 40-50'	LOW MEDIUM LOW MEDIUM MEDIUM MEDIUM MEDIUM MEDIUM	SUN SUN ADAPTABLE SUN TO FILTERED SHADE SUN ADAPTABLE SUN SUN	WHITE N/A GREENISH-WHITE WHITE WHITE WHITE WHITE WHITE WHITE GREEN-YELLOW N/A	SPRING N/A SPRING SPRING SPRING SPRING SPRING SPRING SPRING SPRING N/A
NAMENT Y AG H M SS M C C I <b>ADE TRE</b> Y RM	SIZE           2.0" CAL	QUANTITY 2 QUANTITY	AMELANCHIER LAEVIS SPRING FLURRY     ACER RUBRUM ARMSTRONG GOLD     ACER TATARICUM HOT WINGS     ACER TATARICUM HOT WINGS     CRATAEGUS AMBIGUA     MALUS 'SPRING SNOW'     PRUNUS PADUS 'MERLOT'     PYRUS CALLERYANA 'CHANTICLEER'     PYRUS CALLERYANA JACK     BOTANICAL NAME     ACER GRANDIDENTATUM ROCKY MOUNTAIN GLOW     CELTIS OCCIDENTALIS     CORYLUS COLURNA	SPRING FLURRY ALLEGHENY SERVICEBERRY ARMSTRONG GOLD RED MAPLE HOT WINGS TATARIAN MAPLE RUSSIAN HAWTHORN SPRING SNOW CRABAPPLE PURPLE LEAF MAYDAY TREE CHANTICLEER PEAR PEAR JACK COMMON NAME ROCKY MOUNTAIN GLOW MAPLE WESTERN HACKBERRY TURKISH FILBERT	20-35' 30-40' 15-20' 15-25' 20-25' 15-20' 20-30' 14-16' <b>HEIGHT</b> 20-30' 50-60' 30-45'	15-20' 10-12' 15-20' 20-25' 15-20' 15-20' 8-10' <b>SPREAD</b> 20-30' 40-50' 25-30'	LOW MEDIUM LOW MEDIUM MEDIUM MEDIUM MEDIUM MEDIUM	SUN SUN ADAPTABLE SUN TO FILTERED SHADE SUN ADAPTABLE SUN SUN SUN	WHITE N/A GREENISH-WHITE WHITE WHITE WHITE WHITE COLOR GREEN-YELLOW N/A N/A	SPRING N/A SPRING SPRING SPRING SPRING SPRING SPRING SPRING N/A N/A
NAMENT Y AG H M S M S M C ADE TRE Y R M	TAL TREES         SIZE         2.0" CAL         2.5" CAL         2.5" CAL         2.5" CAL         2.5" CAL         2.5" CAL	QUANTITY 2 QUANTITY	<ul> <li>AMELANCHIER LAEVIS SPRING FLURRY</li> <li>ACER RUBRUM ARMSTRONG GOLD</li> <li>ACER TATARICUM HOT WINGS</li> <li>CRATAEGUS AMBIGUA</li> <li>MALUS 'SPRING SNOW'</li> <li>PRUNUS PADUS 'MERLOT'</li> <li>PYRUS CALLERYANA 'CHANTICLEER'</li> <li>PYRUS CALLERYANA JACK</li> <li>BOTANICAL NAME</li> <li>ACER GRANDIDENTATUM ROCKY MOUNTAIN GLOW</li> <li>CELTIS OCCIDENTALIS</li> <li>CORYLUS COLURNA</li> <li>GYMNOCLADUS DIOICUS 'ESPRESSO'</li> </ul>	SPRING FLURRY ALLEGHENY SERVICEBERRY ARMSTRONG GOLD RED MAPLE HOT WINGS TATARIAN MAPLE RUSSIAN HAWTHORN SPRING SNOW CRABAPPLE PURPLE LEAF MAYDAY TREE CHANTICLEER PEAR PEAR JACK COMMON NAME ROCKY MOUNTAIN GLOW MAPLE WESTERN HACKBERRY TURKISH FILBERT SEEDLESS KENTUCKY COFFEETREE	20-35' 30-40' 15-20' 15-25' 20-25' 15-20' 20-30' 14-16' <b>HEIGHT</b> 20-30' 50-60' 30-45' 50-60'	15-20' 10-12' 15-20' 20-25' 15-20' 15-20' 8-10' <b>SPREAD</b> 20-30' 40-50' 25-30' 40-50'	LOW MEDIUM LOW MEDIUM MEDIUM MEDIUM MEDIUM MEDIUM MEDIUM	SUN SUN ADAPTABLE SUN TO FILTERED SHADE SUN ADAPTABLE SUN SUN SUN SUN SUN SUN	WHITE N/A GREENISH-WHITE WHITE WHITE WHITE WHITE WHITE GREEN-YELLOW N/A N/A YELLOW-GREEN	SPRING N/A SPRING SPRING SPRING SPRING SPRING SPRING N/A N/A SPRING
NAMENT Y AG H M S M S M Z ADE TRE Y R M E	SIZE         2.0" CAL         2.5" CAL         2.5" CAL         2.5" CAL         2.5" CAL         2.5" CAL         2.5" CAL	QUANTITY 2 QUANTITY	<ul> <li>AMELANCHIER LAEVIS SPRING FLURRY</li> <li>ACER RUBRUM ARMSTRONG GOLD</li> <li>ACER TATARICUM HOT WINGS</li> <li>CRATAEGUS AMBIGUA</li> <li>MALUS 'SPRING SNOW'</li> <li>PRUNUS PADUS 'MERLOT'</li> <li>PYRUS CALLERYANA 'CHANTICLEER'</li> <li>PYRUS CALLERYANA JACK</li> <li>CELTIS OCCIDENTALIS</li> <li>CORYLUS COLURNA</li> <li>GYMNOCLADUS DIOICUS 'ESPRESSO'</li> <li>QUERCUS BICOLOR</li> </ul>	SPRING FLURRY ALLEGHENY SERVICEBERRY ARMSTRONG GOLD RED MAPLE HOT WINGS TATARIAN MAPLE RUSSIAN HAWTHORN SPRING SNOW CRABAPPLE PURPLE LEAF MAYDAY TREE CHANTICLEER PEAR PEAR JACK COMMON NAME ROCKY MOUNTAIN GLOW MAPLE WESTERN HACKBERRY TURKISH FILBERT SEEDLESS KENTUCKY COFFEETREE SWAMP WHITE OAK	20-35' 30-40' 15-20' 15-25' 20-25' 15-20' 20-30' 14-16' <b>HEIGHT</b> 20-30' 50-60' 30-45' 50-60' 40-60'	15-20' 10-12' 15-20' 20-25' 15-20' 15-20' 8-10' <b>SPREAD</b> 20-30' 40-50' 25-30' 40-50' 40-50' 40-60'	LOW MEDIUM LOW MEDIUM MEDIUM MEDIUM MEDIUM MEDIUM MEDIUM	SUN SUN ADAPTABLE SUN TO FILTERED SHADE SUN ADAPTABLE SUN SUN SUN SUN SUN SUN SUN SUN	WHITE N/A GREENISH-WHITE WHITE WHITE WHITE WHITE WHITE COLOR GREEN-YELLOW N/A N/A YELLOW-GREEN N/A	SPRING N/A SPRING SPRING SPRING SPRING SPRING SPRING N/A N/A SPRING N/A SPRING N/A
NAMENT ( AG H M S M ADE TRE ( RM E	SIZE         2.0" CAL         2.5" CAL	QUANTITY 2 QUANTITY	<ul> <li>AMELANCHIER LAEVIS SPRING FLURRY</li> <li>ACER RUBRUM ARMSTRONG GOLD</li> <li>ACER TATARICUM HOT WINGS</li> <li>CRATAEGUS AMBIGUA</li> <li>MALUS 'SPRING SNOW'</li> <li>PRUNUS PADUS 'MERLOT'</li> <li>PYRUS CALLERYANA 'CHANTICLEER'</li> <li>PYRUS CALLERYANA JACK</li> <li>BOTANICAL NAME</li> <li>ACER GRANDIDENTATUM ROCKY MOUNTAIN GLOW</li> <li>CELTIS OCCIDENTALIS</li> <li>CORYLUS COLURNA</li> <li>GYMNOCLADUS DIOICUS 'ESPRESSO'</li> <li>QUERCUS BICOLOR</li> <li>ULMUS ACCOLADE</li> </ul>	SPRING FLURRY ALLEGHENY SERVICEBERRY ARMSTRONG GOLD RED MAPLE HOT WINGS TATARIAN MAPLE RUSSIAN HAWTHORN SPRING SNOW CRABAPPLE PURPLE LEAF MAYDAY TREE CHANTICLEER PEAR PEAR JACK COMMON NAME ROCKY MOUNTAIN GLOW MAPLE WESTERN HACKBERRY TURKISH FILBERT SEEDLESS KENTUCKY COFFEETREE SWAMP WHITE OAK ACCOLADE ELM	20-35' 30-40' 15-20' 15-25' 20-25' 15-20' 20-30' 14-16' <b>HEIGHT</b> 20-30' 50-60' 30-45' 50-60' 40-60' 50-70'	15-20' 10-12' 15-20' 20-25' 15-20' 15-20' 8-10' <b>SPREAD</b> 20-30' 40-50' 25-30' 40-50' 40-60' 30-40'	LOW MEDIUM LOW MEDIUM MEDIUM MEDIUM MEDIUM MEDIUM <b>WATER USE</b> LOW LOW LOW LOW LOW	SUN SUN ADAPTABLE SUN TO FILTERED SHADE SUN ADAPTABLE SUN SUN SUN SUN SUN SUN SUN SUN SUN SUN	WHITE N/A GREENISH-WHITE WHITE WHITE WHITE WHITE WHITE COLOR GREEN-YELLOW N/A N/A YELLOW-GREEN N/A N/A	SPRING N/A SPRING SPRING SPRING SPRING SPRING SPRING N/A N/A SPRING N/A N/A SPRING N/A
NAMENT / AG H / S / ADE TRE / RM E	SIZE         2.0" CAL         2.5" CAL         2.5" CAL         2.5" CAL         2.5" CAL         2.5" CAL         2.5" CAL	QUANTITY 2 QUANTITY	<ul> <li>AMELANCHIER LAEVIS SPRING FLURRY</li> <li>ACER RUBRUM ARMSTRONG GOLD</li> <li>ACER TATARICUM HOT WINGS</li> <li>CRATAEGUS AMBIGUA</li> <li>MALUS 'SPRING SNOW'</li> <li>PRUNUS PADUS 'MERLOT'</li> <li>PYRUS CALLERYANA 'CHANTICLEER'</li> <li>PYRUS CALLERYANA JACK</li> <li>CELTIS OCCIDENTALIS</li> <li>CORYLUS COLURNA</li> <li>GYMNOCLADUS DIOICUS 'ESPRESSO'</li> <li>QUERCUS BICOLOR</li> </ul>	SPRING FLURRY ALLEGHENY SERVICEBERRY ARMSTRONG GOLD RED MAPLE HOT WINGS TATARIAN MAPLE RUSSIAN HAWTHORN SPRING SNOW CRABAPPLE PURPLE LEAF MAYDAY TREE CHANTICLEER PEAR PEAR JACK COMMON NAME ROCKY MOUNTAIN GLOW MAPLE WESTERN HACKBERRY TURKISH FILBERT SEEDLESS KENTUCKY COFFEETREE SWAMP WHITE OAK	20-35' 30-40' 15-20' 15-25' 20-25' 15-20' 20-30' 14-16' <b>HEIGHT</b> 20-30' 50-60' 30-45' 50-60' 40-60'	15-20' 10-12' 15-20' 20-25' 15-20' 15-20' 8-10' <b>SPREAD</b> 20-30' 40-50' 25-30' 40-50' 40-50' 40-60'	LOW MEDIUM LOW MEDIUM MEDIUM MEDIUM MEDIUM MEDIUM MEDIUM	SUN SUN ADAPTABLE SUN TO FILTERED SHADE SUN ADAPTABLE SUN SUN SUN SUN SUN SUN SUN SUN	WHITE N/A GREENISH-WHITE WHITE WHITE WHITE WHITE WHITE COLOR GREEN-YELLOW N/A N/A YELLOW-GREEN N/A	SPRING N/A SPRING SPRING SPRING SPRING SPRING SPRING N/A N/A SPRING N/A SPRING N/A

# CITY OF BOULDER LANDSCAPE NOTES:

WITHOUT PRIOR WRITTEN APPROVAL OF THE CITY. STOCK, OTHER THAN CONTAINER-GROWN STOCK, SHALL NOT BE PLANTED BETWEEN JUNE 1 AND SEPTEMBER 1 WITHOUT PRIOR WRITTEN APPROVAL OF THE CITY. BARE ROOT STOCK SHALL NOT BE PLANTED AFTER APRIL 30 OR IF PLANTS HAVE BEGUN TO LEAF OUT. (B) NOTHING SHALL BE PLANTED DURING FREEZING OR EXCESSIVELY WINDY, HOT, OR WET WEATHER OR WHEN THE GROUND CONDITIONS CANNOT BE PROPERLY WORKED FOR DIGGING, MIXING, RAKING, OR GRADING. (C) NOTHING SHALL BE PLANTED UNTIL THE ADJACENT SITE IMPROVEMENTS, PAVEMENTS, IRRIGATION INSTALLATION AND FINISH GRADING IS COMPLETED. THE CONTRACTOR SHALL TEST THE IRRIGATION SYSTEM IN THE PRESENCE OF THE DIRECTOR. THE IRRIGATION SYSTEM SHALL BE IN APPROVED, OPERATING CONDITION PRIOR TO ANY PLANTING. 2. SITE PREPARATION AND ALL PLANTING SHALL BE COMPLETED, AT A MINIMUM, IN ACCORDANCE WITH THE CITY OF BOULDER DESIGN AND CONSTRUCTION STANDARDS. SITE PREPARATION SHALL INCLUDE TILLING THE SOIL TO A MINIMUM DEPTH OF SIX INCHES BELOW THE FINISHED GRADE, TOGETHER WITH SOIL AMENDMENTS THAT ARE APPROPRIATE TO ENSURE THE HEALTH AND SUSTAINABILITY OF THE LANDSCAPING TO BE PLANTED. 3. TURF GRASS SHALL BE LIMITED TO A MAXIMUM OF 25 PERCENT OF ALL LANDSCAPE AREAS ON THE SITE. 4. ALL PLANTING BEDS AND A 3-FOOT DIAMETER RING AT THE BASE OF EACH TREE WITHIN SOD OR SEEDED AREAS SHALL BE MULCHED WITH ORGANIC MULCH AT LEAST 4" DEEP. 5. GRAVEL, ROCK MULCH, OR CRUSHER FINES SHALL NOT BE USED UNDER TREES OR ANY PLANTING AREAS. ROCK OR GRAVEL MAY ONLY BE USED AS A SPECIFIC ORNAMENTAL FEATURE IN LIMITED AREAS (SUCH AS AT THE BOTTOM OF A DRAINAGE SWALE OR DRY RIVER BED) OR AS A PEDESTRIAN PATH OR PATIO. 6. WEED BARRIER FABRIC SHALL NOT TO BE USED IN ANY PLANTING AREAS. ALL PLANTS SHALL BE GROUPED BY WATER NEEDS. A MINIMUM OF 75 PERCENT OF ALL LANDSCAPED AREAS (INCLUDING ANY TURF GRASS) MUST USE LOW TO MODERATE WATER DEMAND PLANTS. THE LANDSCAPE SHALL BE DESIGNED SO THAT, AT MATURITY, NOT MORE THAN 10 PERCENT OF THE LANDSCAPED AREA IS

EXPOSED MULCH.

(ONLY APPLICABLE TO EXISTING PUBLIC STREET TREES OR EXISTING PRIVATE TREES THAT WILL MEET THE STREET TREE REQUIREMENTS OF SECTION 9-9-13 BRC 1981) 10. ALL NEW TREES SHALL BE LOCATED A MINIMUM OF 10' FROM ANY EXISTING WATER OR SEWER UTILITY LINES OR FROM LIGHT POLES OR OVERHEAD UTILITY POLES. ALL NEW UTILITY LINES SHALL BE LOCATED A MINIMUM OF 10' FROM ANY EXISTING PUBLIC STREET TREE.

# **OTHER LANDSCAPE NOTES:**

ROOT BALL OF THE PLANT PRIOR TO PLANTING. 8. PLANTS ARE GROUPED BY WATER USE ZONE TO CONSERVE WATER. WITHIN PUBLIC AREAS. REQUIREMENTS.

1. LANDSCAPING SCHEDULE: (A) NOTHING SHALL BE PLANTED BETWEEN OCTOBER 15 AND MARCH 1

8. ALL LANDSCAPE AREAS SHALL BE WATERED BY AN AUTOMATIC IRRIGATION SYSTEM. THE IRRIGATION SYSTEM MUST BE ZONED TO DELIVER DIFFERENT APPROPRIATE AMOUNTS OF WATER TO DIFFERENT PLANT ZONES. THE SITE SHOULD BE IRRIGATED WITH DRIP IRRIGATION, BUBBLER, OR MICRO-SPRAY SYSTEMS. ALL TREES WILL BE ZONED SEPARATELY FROM TURF GRASS. ALL IRRIGATION ZONES SHALL USE A SMART SYSTEM THAT ADJUSTS FOR RAINFALL, SOIL MOISTURE, AND OTHER WEATHER FACTORS.

 PROTECTIVE MAINTENANCE: AN APPLICANT FOR CONSTRUCTION APPROVAL SHALL PROVIDE MAINTENANCE AND CARE FOR ALL EXISTING TREES REQUIRED TO BE PROTECTED IN THE PUBLIC RIGHT-OF-WAY ADJACENT TO ANY PROJECT OR CONSTRUCTION SITE DURING CONSTRUCTION ACTIVITIES AND THE PUBLIC IMPROVEMENT WARRANTY PERIOD TO ENSURE THAT EXISTING TREES SURVIVE AND ARE NOT DAMAGED. REFER TO CHAPTER 3 OF THE DESIGN AND CONSTRUCTION STANDARDS FOR ALL TREE PROTECTION REQUIREMENTS.

1. ALL PLANT MATERIAL SHALL MEET SPECIFICATIONS OF THE AMERICAN ASSOCIATION OF NURSERYMEN (AAN) FOR NUMBER ONE GRADE. ALL TREES SHALL BE BALLED AND BURLAPPED OR EQUIVALENT. ALL PLANT MATERIALS SHALL HAVE ALL WIRE, TWINE OR OTHER CONTAINMENT MATERIALS, EXCEPT FOR BURLAP, REMOVED FROM TRUNK AND

2. GRADES SHALL BE SET TO ALLOW FOR PROPER DRAINAGE AWAY FROM STRUCTURES. GRADES SHALL MAINTAIN SMOOTH PROFILES AND BE FREE OF SURFACE DEBRIS, BUMPS, AND DEPRESSIONS.

3. OWNERS SHALL ENSURE THAT THE LANDSCAPE PLAN IS COORDINATED WITH THE PLANS DONE BY OTHER CONSULTANTS SO THAT THE PROPOSED GRADING, STORM DRAINAGE, OR OTHER CONSTRUCTIONS DOES NOT CONFLICT NOR PRECLUDE INSTALLATION AND MAINTENANCE OF LANDSCAPE ELEMENTS ON THIS PLAN.

4. ALL SHRUB BEDS ADJACENT TO TURF AREAS SHALL BE EDGED WITH ROLLED TOP STEEL EDGER. 5. ALL SHRUB BED AREAS, PERENNIALS AND GROUNDCOVER SHALL BE MULCHED WITH A 4" LAYER OF GORILLA HAIR MULCH. DO NOT USE WEED BARRIER FABRIC IN ANY OF THE LANDSCAPE BEDS.

6. PRIOR TO INSTALLATION OF PLANT MATERIALS, AREAS THAT HAVE BEEN COMPACTED OR DISTURBED BY CONSTRUCTION ACTIVITY SHALL BE THOROUGHLY LOOSENED; ORGANIC SOIL AMENDMENTS SHALL BE INCORPORATED AT THE RATE OF AT LEAST FOUR (4) CUBIC YARDS PER 1000 SQUARE FEET OF LANDSCAPE AREA. 7. PROVIDE 12" OF TOPSOIL IN ALL PLANTING AREAS THAT WERE PREVIOUSLY HARDSCAPE.

9. CONTRACTOR SHALL VERIFY ALL MATERIAL QUANTITIES PRIOR TO INSTALLATION. ACTUAL NUMBER OF PLANT SYMBOLS SHALL HAVE PRIORITY OVER THE QUANTITY DESIGNATED.

10. REFER TO THE CITY OF BOULDER DESIGN AND CONSTRUCTION STREETSCAPING STANDARDS FOR ALL WORK

11. REFER TO THE CIVIL ENGINEER DRAWINGS FOR GRADING AND UTILITY INFORMATION. 12. REFER TO THE CITY OF BOULDER DESIGN AND CONSTRUCTION STANDARDS FOR TREE PROTECTION



DENVER LOS ANGELES NEW YORK PORTLAND SEATTLE WASHINGTON, DC

VANCOUVER, BC 1350 17th Street Suite 202 Denver, Colorado 80202 303.557.6420 www.zgf.com

CIVIL THE SANITAS GROUP 901 FRONT STREET, SUITE 350 LOUISVILLE, CO 80027 T 303 481 2710

Consultant

ENTITLEMENTS STUDIO ARCHITECTURE 2995 55TH STREET, #17983 BOULDER, CO 80301 T 720 491 1167

LANDSCAPE STUDIO TERRA INC. 758 CLUB CIRCLE LOUISVILLE, CO 80027

T 303 494 9138

STRUCTURAL ANTHEM STRUCTURAL ENGINEERS FLATIRON OFFICE PARE 2213 CENTRAL AVENUE BOULDER, CO 80301 T 303 848 8497

MFP **BRANCH PATTERN** 3344 WALNUT STREET DENVER, CO 80205 T 303 382 1920

LIGHTING AE DESIGN 1900 WAZEE STREET, #205 DENVER, CO 80202 T 303 296 3034

AV/TECHNOLOGY/SECURITY SALAS O'BRIEN 4900 NAUTILUS CT. N. SUITE 200

BOULDER, CO 80301 T 303 865 5500

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Full Design Team Roster on Sheet 1-G0.01



Boulder Western City Campus - Volume 1-Pavilion Office Building 1155 Alpine Ave Boulder, CO 80302

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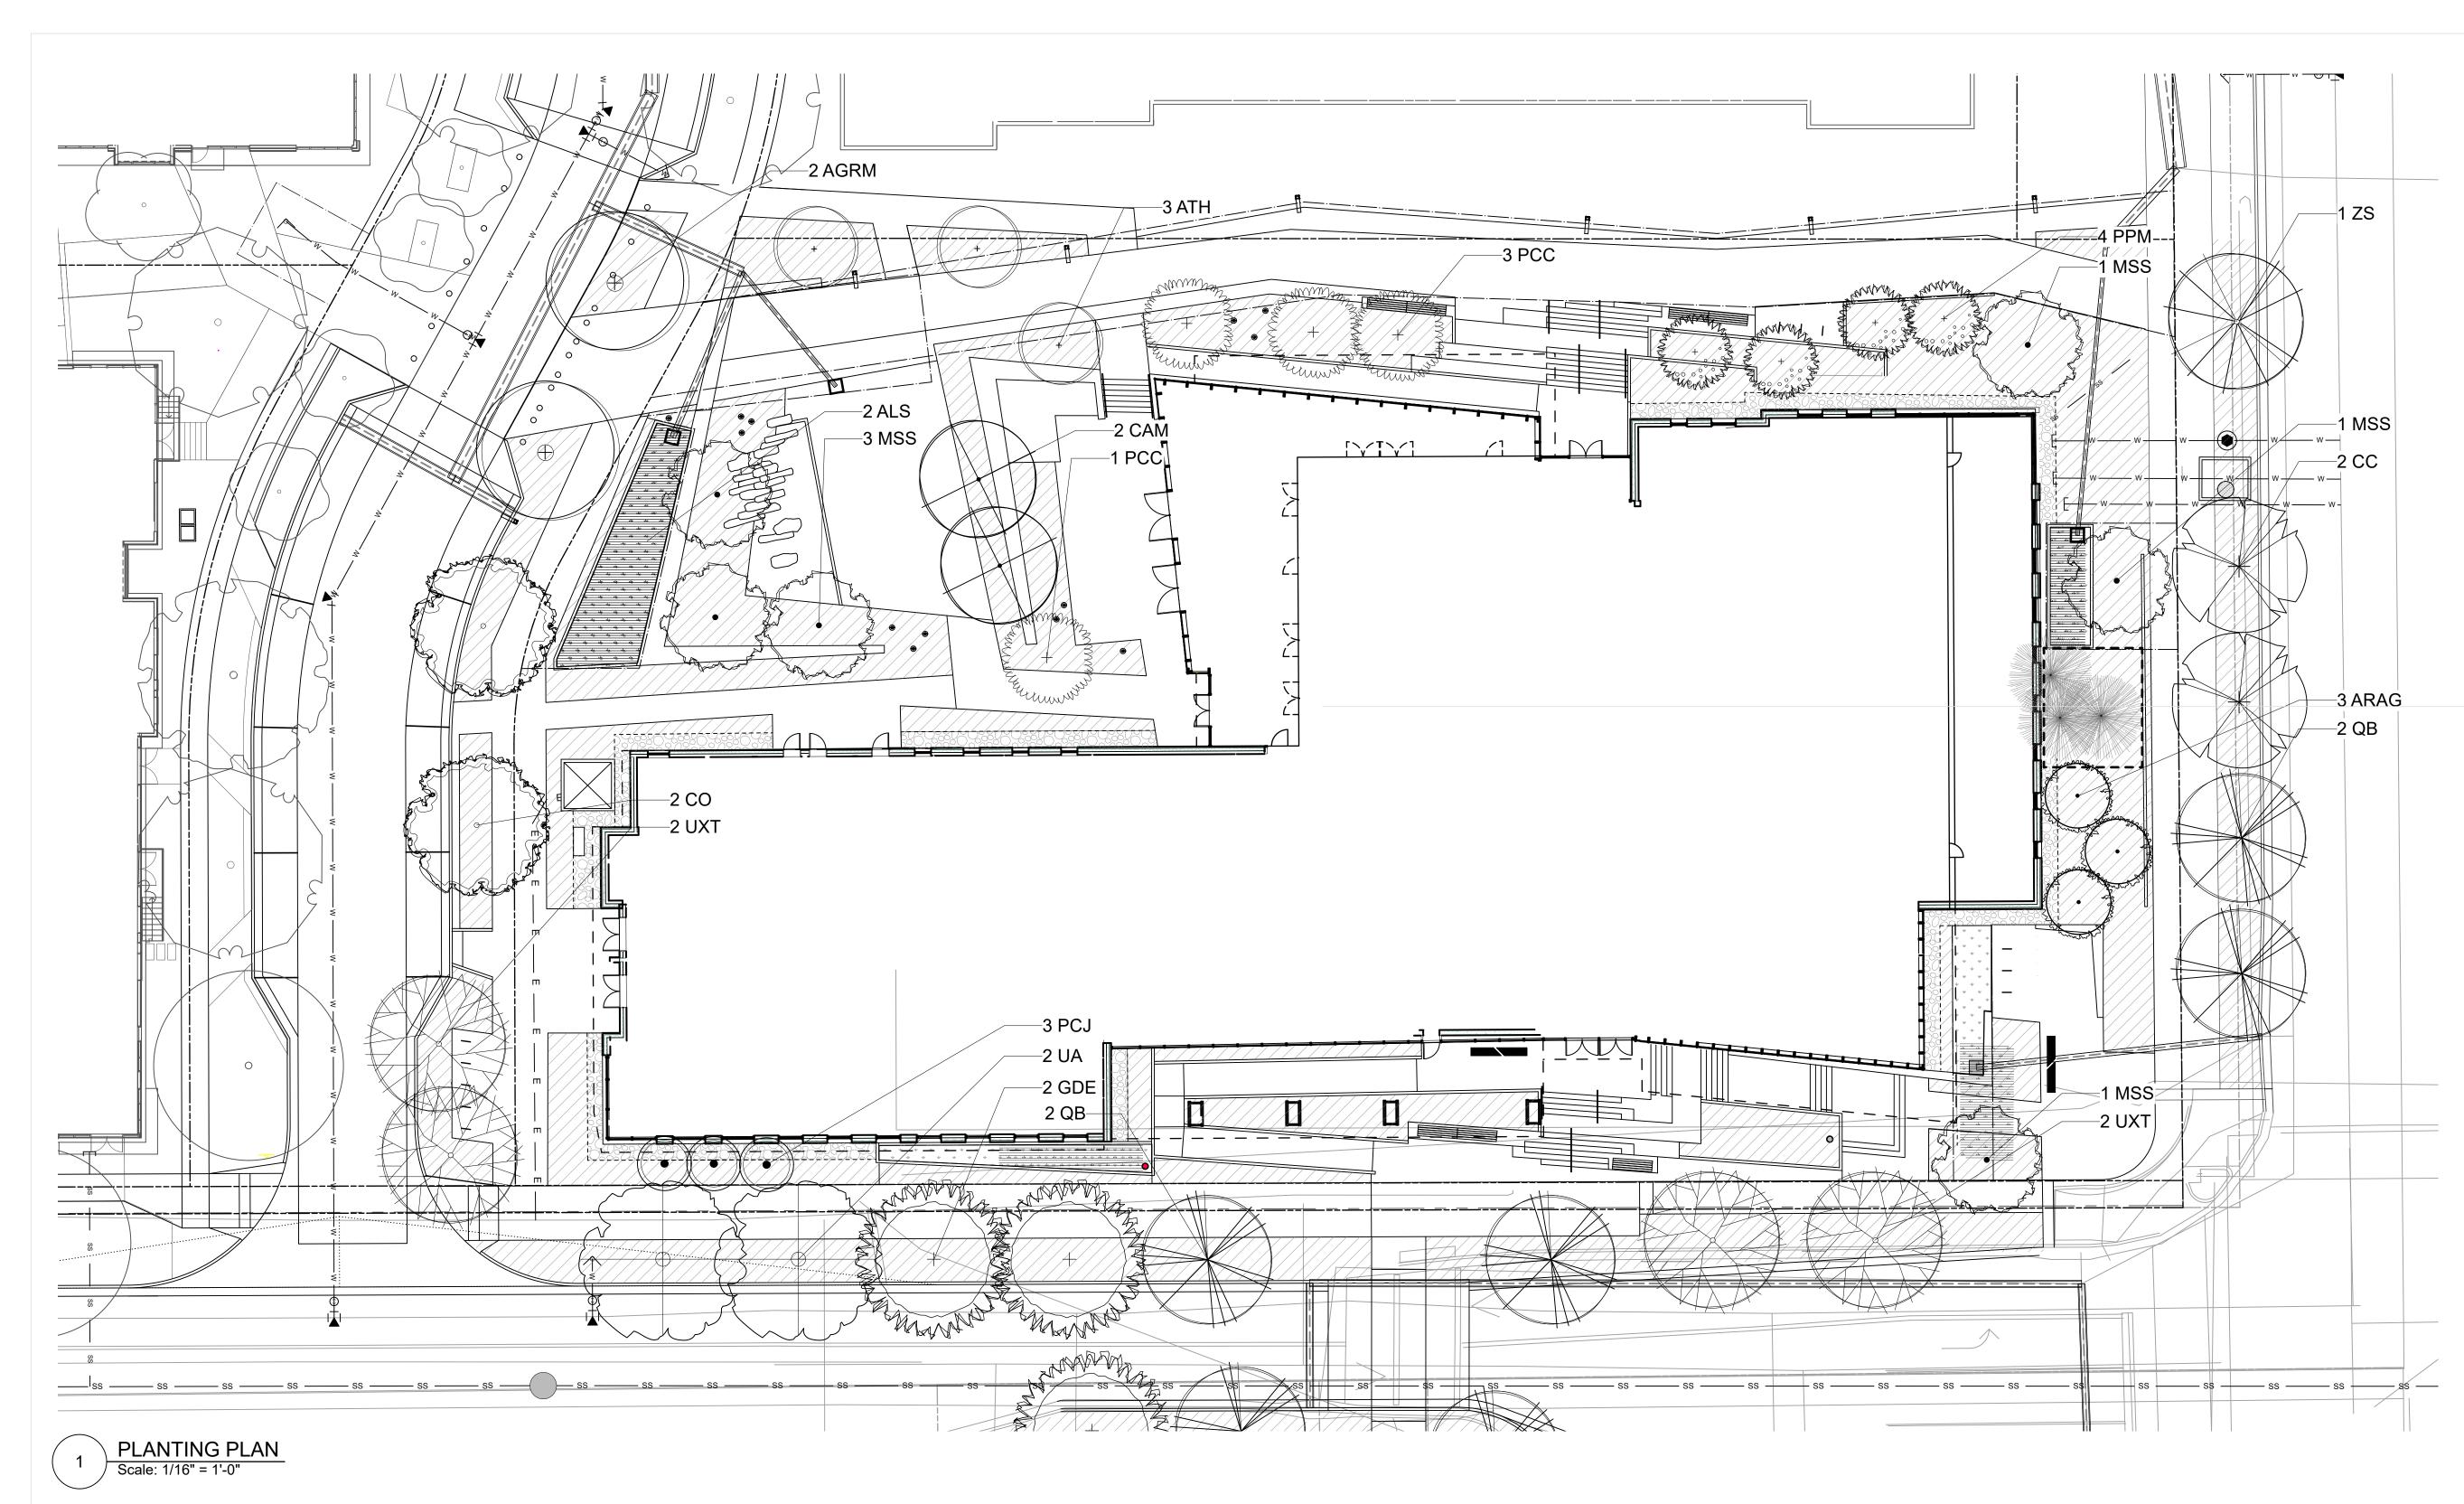
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PLANT SCHEDULE AND NOTES



Current Issue SITE REVIEW




# SIGHT TRIANGLE NOTES:

PER BOULDER REVISED CODE 9-9-7(B):

OBSTRUCTION PROHIBITED: NO PERSON SHALL PLACE OR MAINTAIN ANY STRUCTURES, FENCES, LANDSCAPING, OR ANY OTHER OBJECTS WITHIN ANY SIGHT TRIANGLE AREA DESCRIBED IN SUBSECTION (C) OF THIS SECTION THAT OBSTRUCTS OR OBSCURES SIGHT DISTANCE VISIBILITY THROUGH SUCH STRUCTURES, FENCING, LANDSCAPING, OR OTHER OBJECTS BY MORE THAN TWENTY-FIVE PERCENT OF THE TOTAL VIEW IN THE VERTICAL PLANE ABOVE THE SIGHT TRIANGLE AREA BETWEEN A HEIGHT OF THIRTY INCHES AND NINETY-SIX INCHES ABOVE THE ROADWAY SURFACE, EXCEPT FOR THE FOLLOWING:

(1) LANDSCAPING, STRUCTURES, OR FENCES THAT PROTRUDE NO MORE THAN THIRTY INCHES ABOVE THE ADJACENT ROADWAY SURFACE MAY BE PERMITTED WITHIN THE SIGHT TRIANGLE AREA.

(2) TREES MAY BE PLANTED AND MAINTAINED WITHIN THE SIGHT TRIANGLE AREA IF ALL BRANCHES ARE TRIMMED TO MAINTAIN A CLEAR VISION FOR A VERTICAL HEIGHT OF NINETY-SIX INCHES ABOVE THE ROADWAY SURFACE AND THE LOCATION OF THE TREES PLANTED, BASED ON THE TREE SPECIES EXPECTED MATURE HEIGHT AND SIZE, DOES NOT OBSTRUCT SIGHT VISIBILITY BY MORE THAN TWENTY-FIVE PERCENT OF THE SIGHT TRIANGLE AREA.

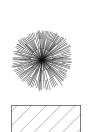





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# LEGEND

- EXISTING TREE TO REMAIN
- PLANTING BED SHRUBS, ORN GRASSES, PERENNIALS -5 GAL SHRUBS, 1 GAL GRASSES AND PERENNIALS
- PLANTING BED WATER QUALITY PLANTINGS
- ROCK MULCH
- ----- LANDSCAPE EDGER
  - TREE PROTECTION ZONE

# TREE KEY

ORNAM	IENTAL TR	EES	
KEY	SIZE	BOTANICAL NAME	COMMON NAME
ALS	2.0" CAL	AMELANCHIER LAEVIS SPRING FLURRY	SPRING FLURRY ALLEGHEN
ARAG	2.0" CAL	ACER RUBRUM ARMSTRONG GOLD	ARMSTRONG GOLD RED MA
ATH	2.0" CAL	ACER TATARICUM HOT WINGS	HOT WINGS TATARIAN MAR
CAM	2.0" CAL	CRATAEGUS AMBIGUA	RUSSIAN HAWTHORN
MSS	2.0" CAL	MALUS 'SPRING SNOW'	SPRING SNOW CRABAPPLE
PPM	2.0" CAL	PRUNUS PADUS 'MERLOT'	PURPLE LEAF MAYDAY TREE
PCC	2.0" CAL	PYRUS CALLERYANA 'CHANTICLEER'	CHANTICLEER PEAR
PCJ	2.0" CAL	PYRUS CALLERYANA JACK	PEAR JACK
SHADE	TREES		
KEY	SIZE	BOTANICAL NAME	COMMON NAME
AGRM	2.5" CAL	ACER GRANDIDENTATUM ROCKY MOUNTAIN GLOW	ROCKY MOUNTAIN GLOW N
CO	2.5" CAL	CELTIS OCCIDENTALIS	WESTERN HACKBERRY
CC	2.5" CAL	CORYLUS COLURNA	TURKISH FILBERT
GDE	2.5" CAL	GYMNOCLADUS DIOICUS 'ESPRESSO'	SEEDLESS KENTUCKY COFFE
QB	2.5" CAL	QUERCUS BICOLOR	SWAMP WHITE OAK
UA	2.5" CAL	ULMUS ACCOLADE	ACCOLADE ELM
UXT	2.5" CAL	ULMUS X TRIUMPH	TRIUMPH ELM
ZS	2.5" CAL	ZELKOVA SERRATA 'GREEN VASE'	GREEN VASE ZELKOVA

ENY SERVICEBERRY MAPLE IAPLE

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MAPLE

FEETREE

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16	8	0	16 FT	

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1350 17th Street Suite 202 Denver, Colorado 80202 303.557.6420 www.zgf.com

CIVIL THE SANITAS GROUP 901 FRONT STREET, SUITE 350 LOUISVILLE, CO 80027 T 303 481 2710

Consultant

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LANDSCAPE STUDIO TERRA INC. 758 CLUB CIRCLE LOUISVILLE, CO 80027 T 303 494 9138

STRUCTURAL ANTHEM STRUCTURAL ENGINEERS FLATIRON OFFICE PARK 2213 CENTRAL AVENUE BOULDER, CO 80301 T 303 848 8497

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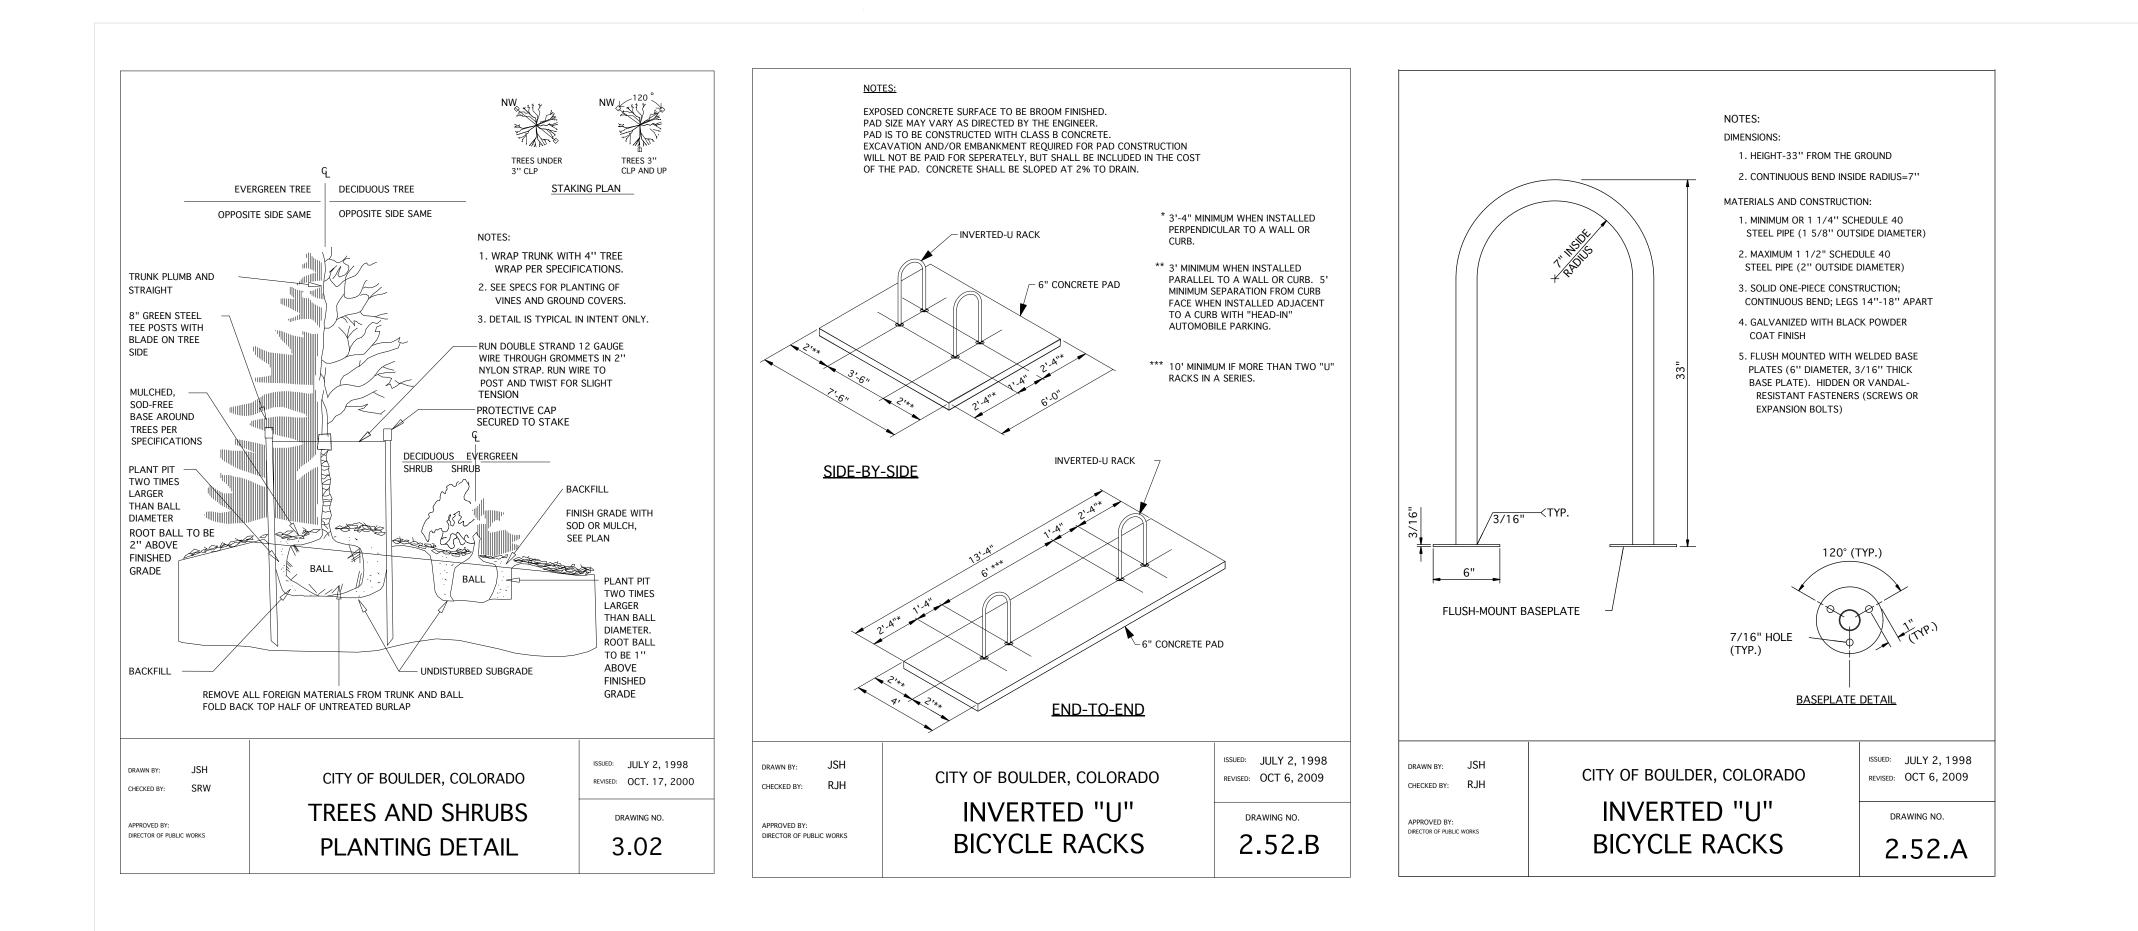
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LANDSCAPE PLAN



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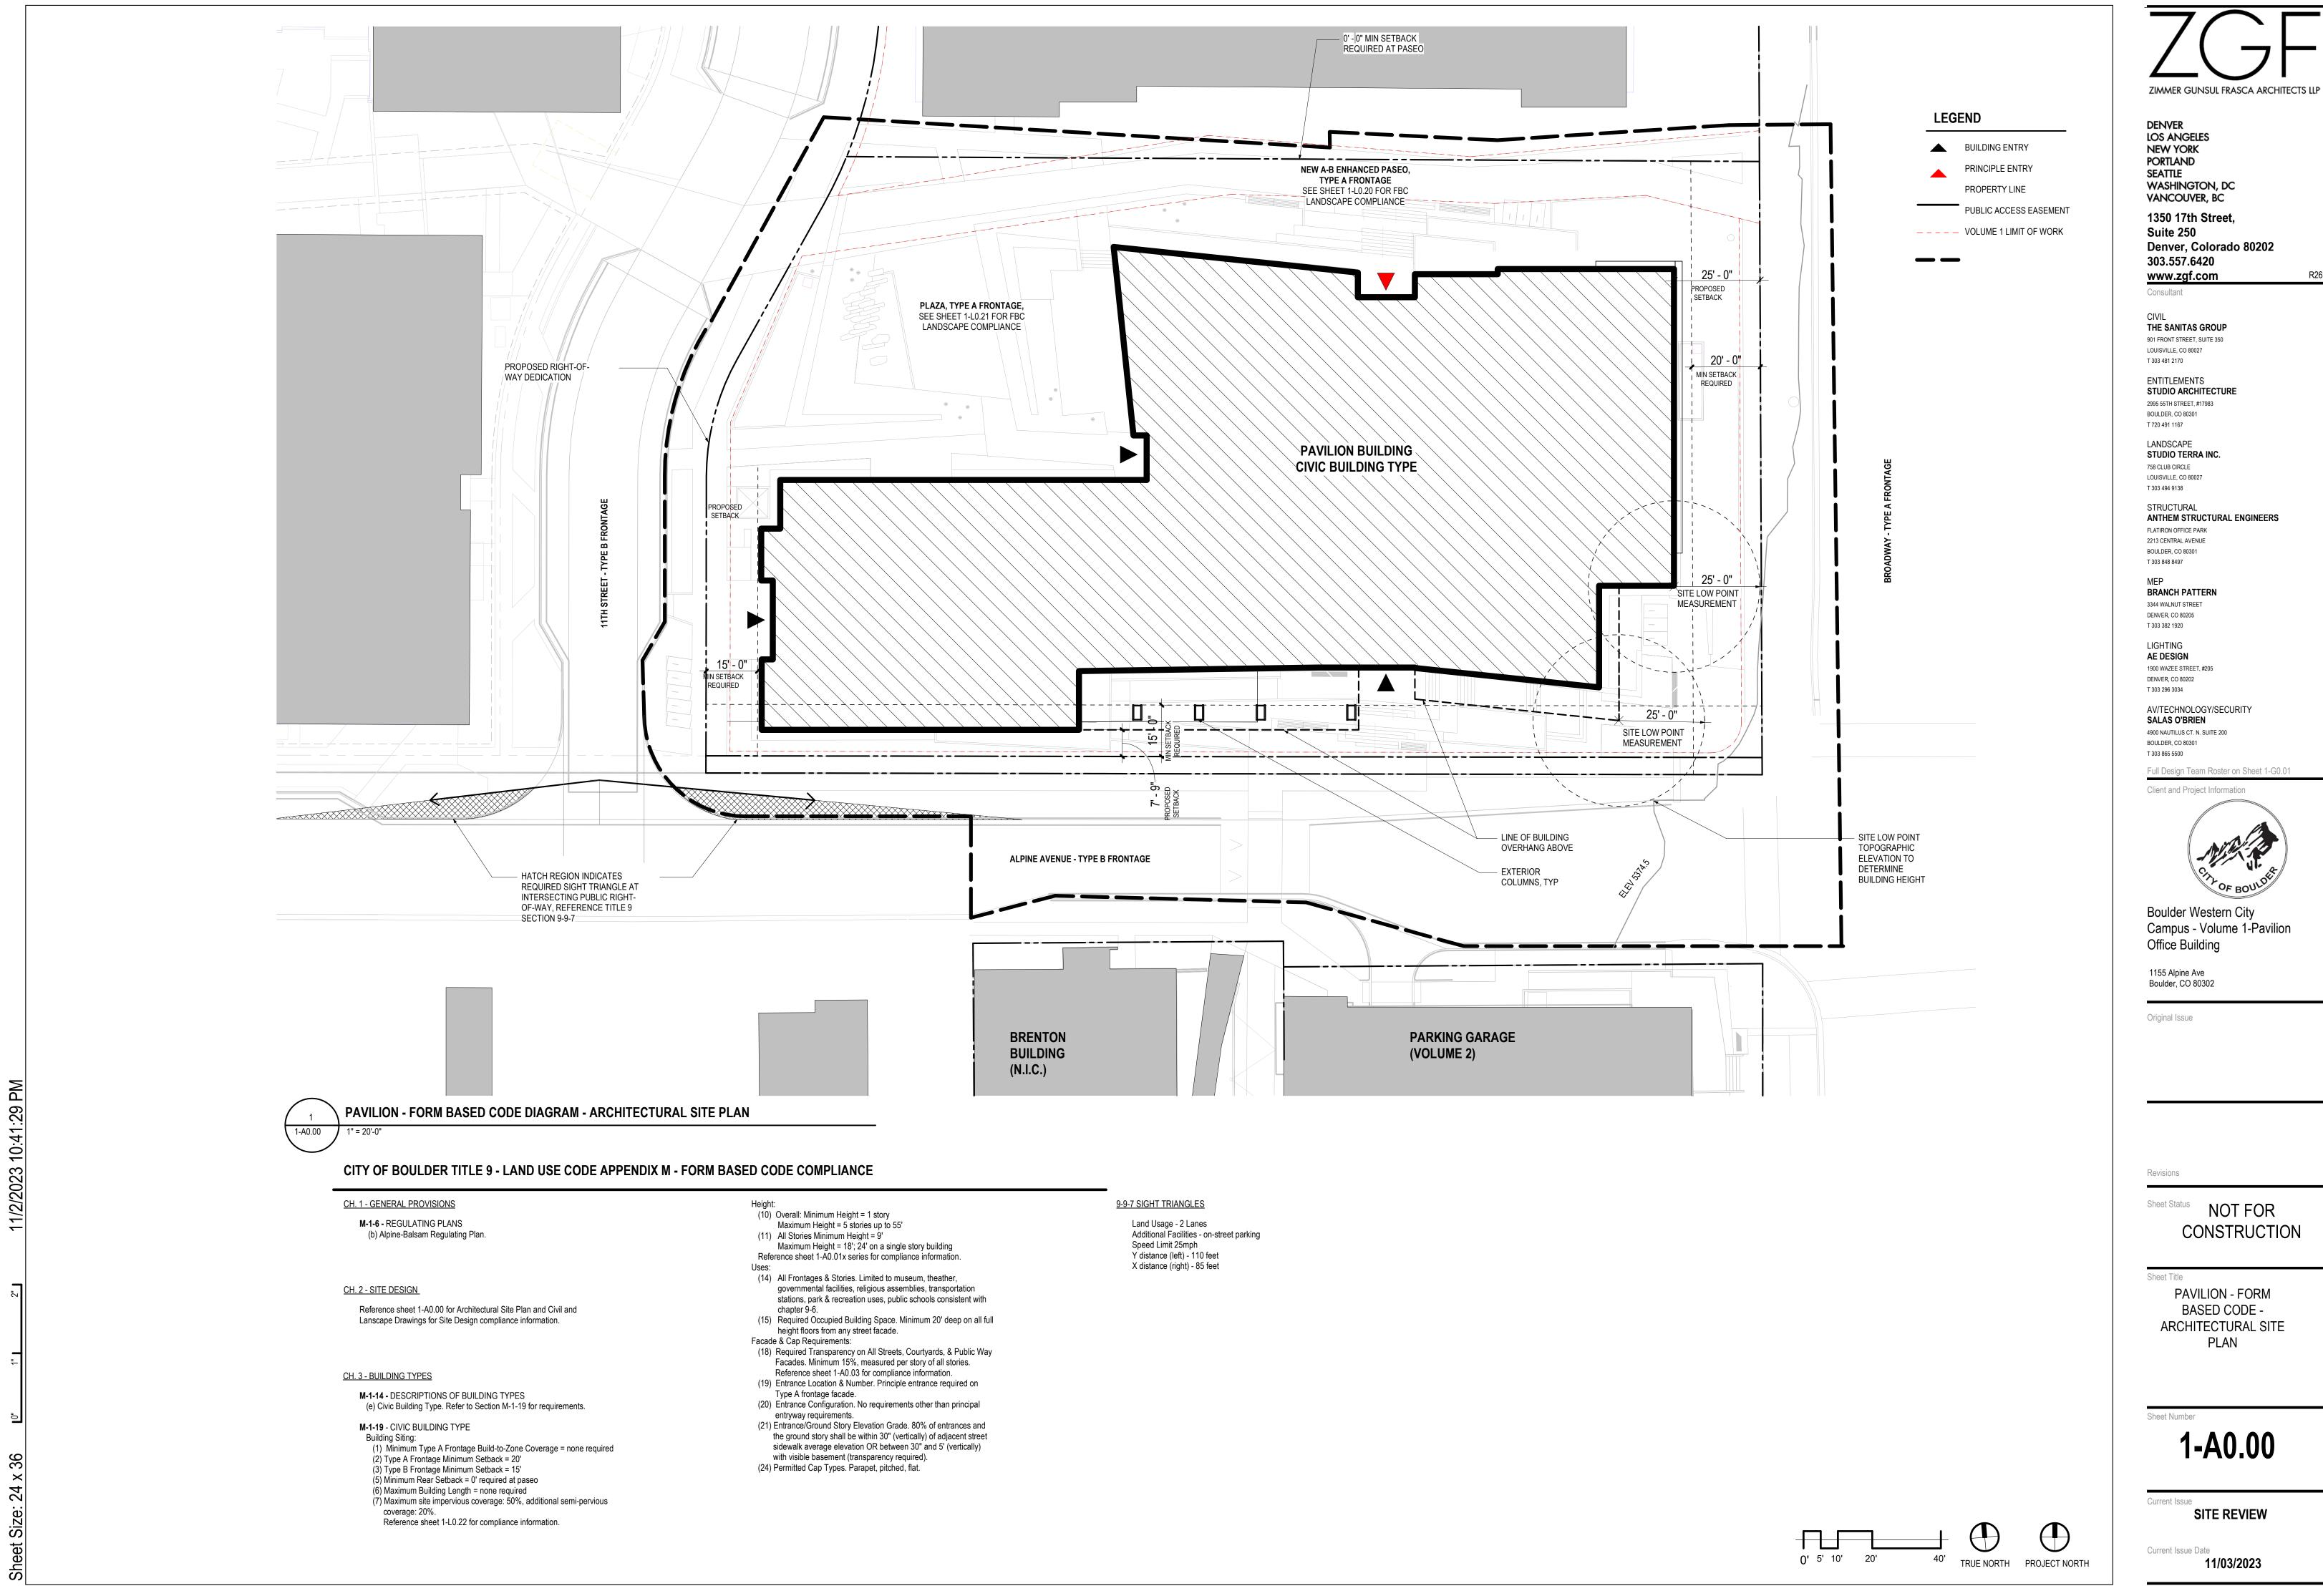
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Sheet Title

PLANTING DETAILS



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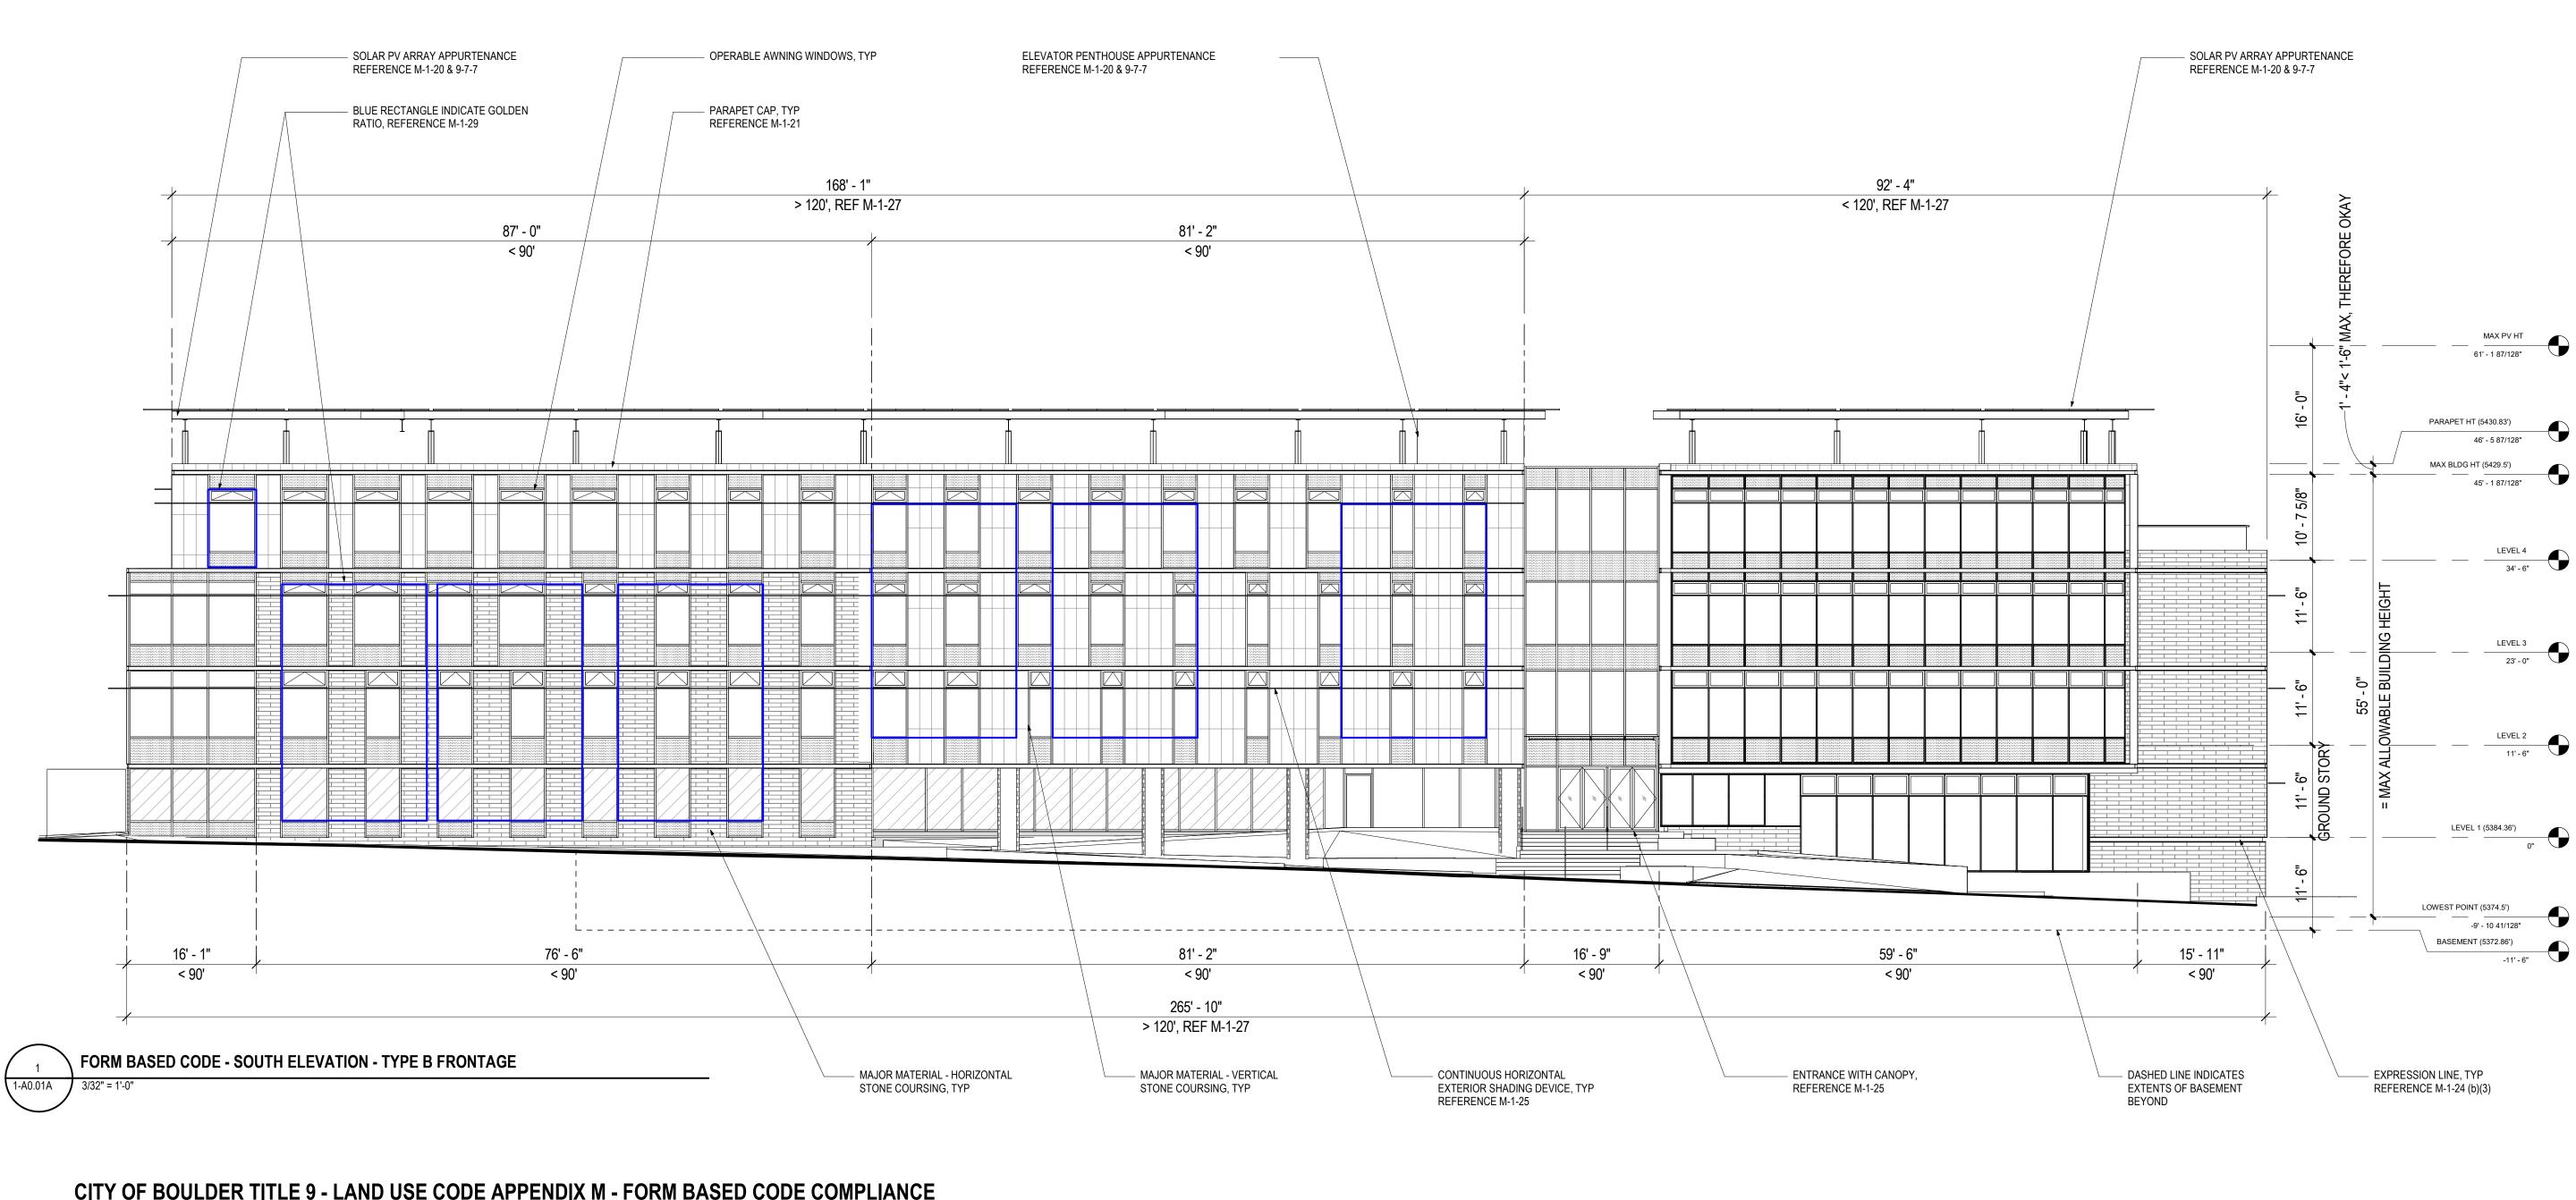


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# CH. 1 - GENERAL PROVISIONS

- M-1-6 REGULATING PLANS
- (b) Alpine-Balsam Regulating Plan.

## CH. 2 - SITE DESIGN

Reference sheet 1-A0.00 for Architectural Site Plan and Civil and Lanscape Drawings for Site Design compliance information.

## CH. 3 - BUILDING TYPES

- **M-1-14 -** DESCRIPTIONS OF BUILDING TYPES (e) Civic Building Type. Refer to Section M-1-19 for requirements.
- M-1-19 CIVIC BUILDING TYPE
- M-1-20 MEASUREMENT OF BUILDING TYPE REQUIREMENTS
- (d) Overall Minimum and Maximum Height.
- (2)(D) Height Measurement Standards. Height shall be measured consistent with height measurement standards of Section 9-7-5, "Building Height," B.R.C. 1981, and the definition of "height" within Section 9-16-1 "General Definitions," B.R.C. 1981.
- Section 84 of the charter of the City of Boulder. All buildings and other structures throughout the city shall be limited
- to a height not exceeding fifty-five feet. This height limit shall not apply to: (d) Renewable energy improvements carried on or above the roof level. Section 9-7-7, "Building Height, Appurtenances," B.R.C. 1981.
- (3) No appurtenance may have useable floor area except for mechanical equipment installations or be more than sixteen feet in height.
- (e) Minimum and Maximum Height per Story.
- (1) Measurement. Story height shall be measured in feet between the floor of a story to the floor of the story above it.
- (f) Minimum Required Transparency.
- Reference sheet 1-A0.03 for compliance information.

- **M-1-21 -** CAP TYPES (b) Parapet Cap Type.
- (1) Parapet Height. Parapet Height is measured from the top of the upper story to the top of the parapet. (A) Minimum parapet height is two feet with a maximum height of six feet.
- (2) Horizontal Expression Lines. An expression line that is at least two inches deep and extends along at least eighty percent of the facade shall define the parapet from the upper stories of the building and shall define the top of the cap.
- (3) Occupied Building Space. No building shall have occupied space behind the parapet cap.
- (4) Roof terraces and roof decks are permitted on the parapet cap type. (5) Rooftop Appertenances. Any rooftop appertenance shall be located towards the rear or interior of the parapet roof. The parapet shall screen the mechanicals when viewed from the sidewalk across the street and from and adjacent outdoor space. See Section M-1-26,
- CH. 4 BUILDING DESIGN

requirements.

- M-1-23 FACADE MATERIALS
- (b) Major Materials. A minimum of eighty percent of each facade, not including windows and door areas, shall be faced of a single major material, not including architectural metal panel systems. Reference sheet 1-A0.02 for compliance information.
- M-1-24 BUILDING CONSTRUCTION QUALITY
- (b) Changes in Materials. Changes in the vertical surface material shall
- meet the following standards:
- (1) Changes in the Surface Materials. (2) Materials Hierarchy.
- (3) Expression Lines of Surfaces.
- (c) Appropriate Grade of Materials.
- (d) Applique Materials.

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"Mechanical Equipment & Appurtenances," B.R.C. 1981, for additional

- **M-1-25 -** BUILDING FACADE ELEMENTS
- (a) Windows. Windows on all buildings shall be constructed consistent with the following requirements:
- (1) Amount. Each building shall meet the transparency requirements applicable to the building type pursuant to Sections M-1-15 through M-1-19, B.R.C. 1981.
- (2) Recessed. All windows, with the exception of ground story storefront systems, shall be recessed with the glass a minimum of two inches back from the facade surface material or adjacent trim.
- (3) Vertically Oriented. All windows shall be vertically oriented unless the following standards are met: (A) through (C). (4) Visibility Through Glass. Reflective glass and glass block are
- prohibited on street facades. Windows shall meet the transmittance and reflectance factors established in the transparency definition of Section M-1-8 "Definitions," B.R.C. 1981. Windows on the ground story shall meet the transmittance and reflectance factors established in the ground story transparency definition of Section M-1-8 "Definitions," B.R.C. 1981.
- (5) Expressed Lintels. Lintels shall be expressed above all windows and doors by a change in brick coursing or by a separate element. (b) Awnings, Canopies, & Light Shelves. Awning, canopies, and light shelves shall be constructed consistent with the requirements of this
- subsection. (1) Encroachment.
- (2) Attached Awnings & Canopies.
- (3) Canopies & Light Shelves.
- (4) Clearance. (c) Balconies.
- (d) Shutters.
- (e) Principal Entryways. Principle entrances to buildings or units shall be clearly delineated through one or more of the design features listed in paragraph (1) through (4) of this subsection:
- (1) Cap or Canopy.
- (2) Porch (3) Sidelights or Transom.
- (4) Extended Articulation.
- (5) Other Design.
- (6) Right-of-Way. Doors shall not swing into city right-of-way or easemet.

- M-1-26 MECHANICAL EQUIPMENT & APPURTENANCES
- (c) Rooftop Mechanical Equipment. Any rooftop mechanical equipment, including without limitation vents, ventilators, skylights, antennas, and excluding solar energy and wind energy conversion systems, shall meet the following standards:
- (1) Rooftop mechanical equipment shall be located consistent with one of the following methods: (A) - (B)
- (2) The requirements of Section 9-7-7, "Building Height,
- Appurtenances," B.R.C. 1981, shall be met.
- (e) Mechanical Equipment on Other Horizontal Surfaces.
- M-1-27 BUILDING ARTICULATION
- (c) Building Facade Variety. See Figure M-1(52). All buildings 120 feet in width or greater along any Type A or B frontage shall fulfill the following requirements:
- (1) Increments. Each Type A or B frontage facade shall be varied in segments less than or equal to ninety feet.
- (2) Requirements.
- (3) Alternative Method of Compliance.
- M-1-28 BUILDING MASS

Regulations are not required on the civic building per M-1-19 HEIGHT table.

M-1-29 - BUILDING PROPORTIONS (c) Use of Golden Ratio.



ZIMMER GUNSUL FRASCA ARCHITECTS LLP

DENVER LOS ANGELES NEW YORK PORTLAND SEATTLE WASHINGTON, DC VANCOUVER, BC 1350 17th Street, Suite 250 Denver, Colorado 80202 303.557.6420 www.zgf.com

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CIVII THE SANITAS GROUP 901 FRONT STREET, SUITE 350 LOUISVILLE, CO 80027 T 303 481 2170

Consultant

ENTITLEMENTS STUDIO ARCHITECTURE 2995 55TH STREET, #17983 BOULDER, CO 80301 T 720 491 1167 LANDSCAPE

STUDIO TERRA INC. 758 CLUB CIRCLE LOUISVILLE, CO 80027 T 303 494 9138

STRUCTURAL ANTHEM STRUCTURAL ENGINEERS FLATIRON OFFICE PARK 2213 CENTRAL AVENUE BOULDER, CO 80301 T 303 848 8497 MFP

**BRANCH PATTERN** 3344 WALNUT STREET DENVER, CO 80205 T 303 382 1920

LIGHTING AE DESIGN 1900 WAZEE STREET, #205 DENVER, CO 80202 T 303 296 3034

AV/TECHNOLOGY/SECURITY SALAS O'BRIEN 4900 NAUTILUS CT. N. SUITE 200 BOULDER, CO 80301 T 303 865 5500

Full Design Team Roster on Sheet 1-G0.01

Client and Project Information



Boulder Western City Campus - Volume 1-Pavilion Office Building

1155 Alpine Ave Boulder, CO 80302

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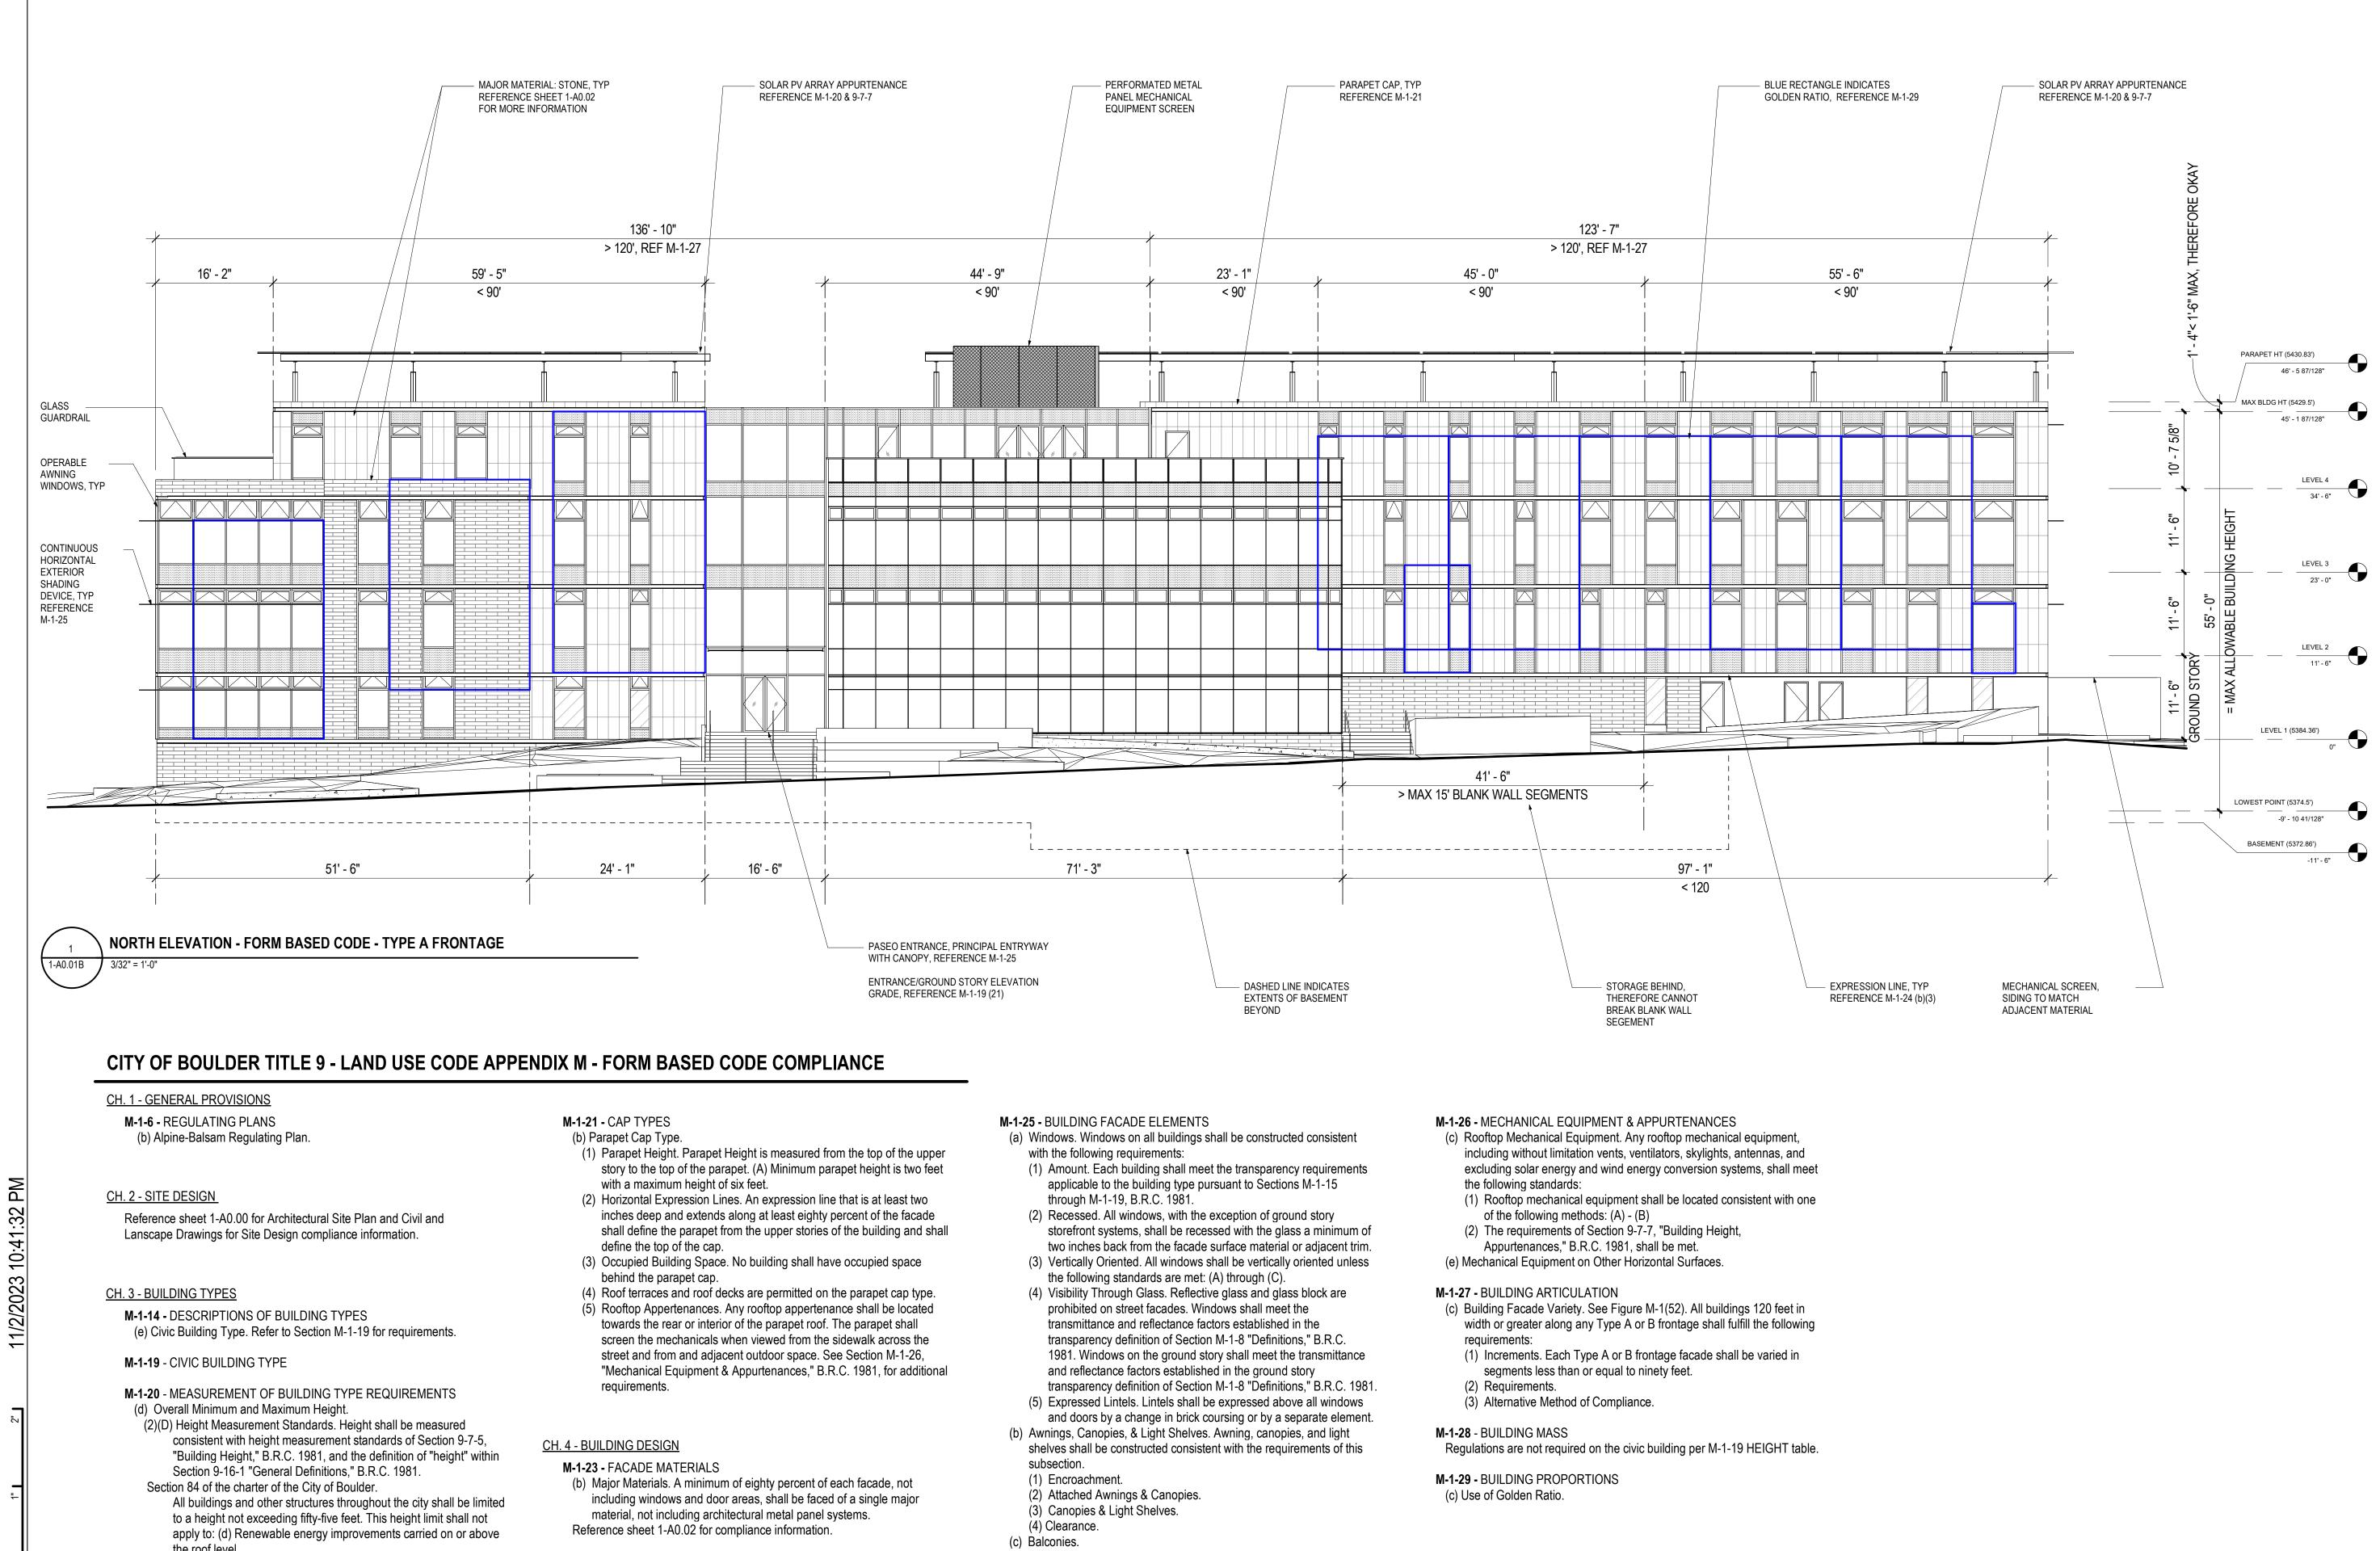
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Sheet Title **PAVILION - FORM** BASED CODE - SOUTH ELEVATION



Current Issue SITE REVIEW



- the roof level.
- Section 9-7-7, "Building Height, Appurtenances," B.R.C. 1981. (3) No appurtenance may have useable floor area except for mechanical equipment installations or be more than sixteen feet in height.
- (e) Minimum and Maximum Height per Story. (1) Measurement. Story height shall be measured in feet between the floor of a story to the floor of the story above it.
- (f) Minimum Required Transparency.
- Reference sheet 1-A0.03 for compliance information.

- M-1-24 BUILDING CONSTRUCTION QUALITY
- (b) Changes in Materials. Changes in the vertical surface material shall meet the following standards:
- (1) Changes in the Surface Materials.
- (2) Materials Hierarchy.
- (3) Expression Lines of Surfaces.
- (c) Appropriate Grade of Materials.

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- (d) Shutters.
- (e) Principal Entryways. Principle entrances to buildings or units shall be clearly delineated through one or more of the design features listed in paragraph (1) through (4) of this subsection:
- (1) Cap or Canopy.
- (2) Porch
- (3) Sidelights or Transom.
- (4) Extended Articulation. (5) Other Design.
- (6) Right-of-Way. Doors shall not swing into city right-of-way or easemet.



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STUDIO TERRA INC. 758 CLUB CIRCLE LOUISVILLE, CO 80027 T 303 494 9138

STRUCTURAL ANTHEM STRUCTURAL ENGINEERS FLATIRON OFFICE PARK 2213 CENTRAL AVENUE BOULDER, CO 80301 T 303 848 8497

MFP **BRANCH PATTERN** 3344 WALNUT STREET DENVER, CO 80205 T 303 382 1920

LIGHTING AE DESIGN 1900 WAZEE STREET, #205 DENVER, CO 80202 T 303 296 3034

AV/TECHNOLOGY/SECURITY SALAS O'BRIEN 4900 NAUTILUS CT. N. SUITE 200 BOULDER, CO 80301 T 303 865 5500

Full Design Team Roster on Sheet 1-G0.01

Client and Project Information



Boulder Western City Campus - Volume 1-Pavilion Office Building

1155 Alpine Ave Boulder, CO 80302

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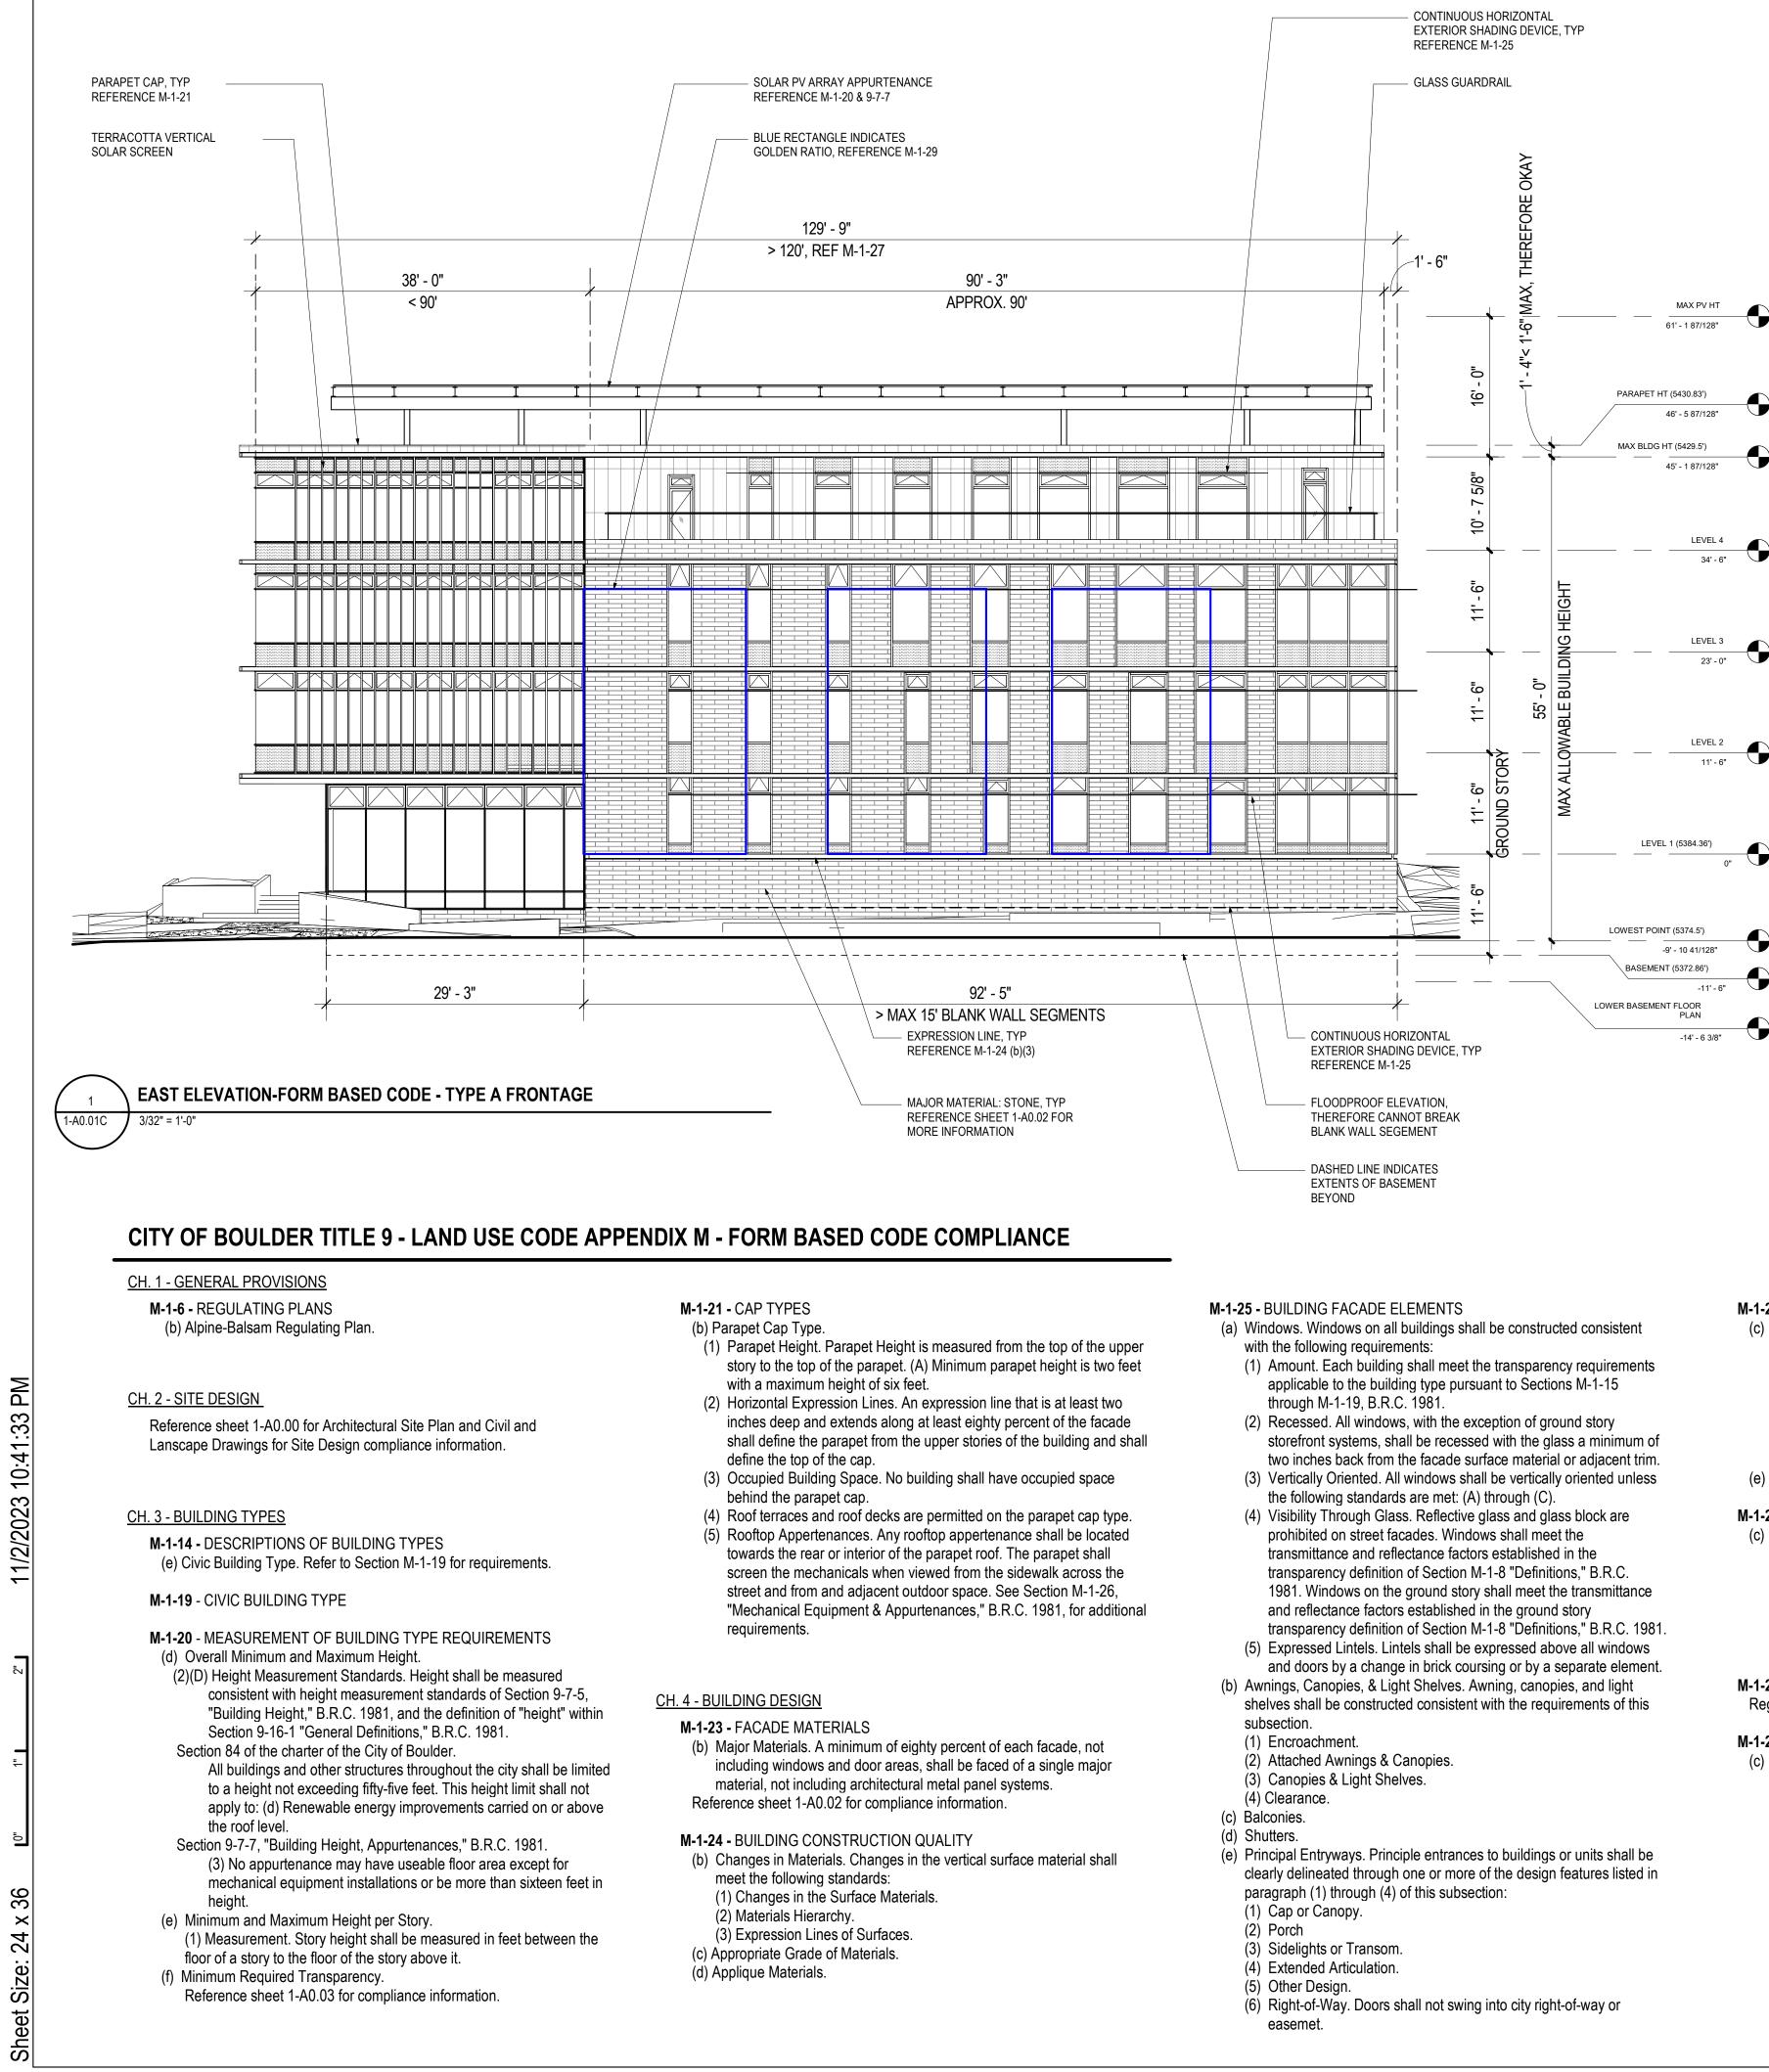
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Sheet Title **PAVILION - FORM** BASED CODE - NORTH ELEVATION

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Current Issue SITE REVIEW

Sheet Number



- M-1-26 MECHANICAL EQUIPMENT & APPURTENANCES
- (c) Rooftop Mechanical Equipment. Any rooftop mechanical equipment, including without limitation vents, ventilators, skylights, antennas, and excluding solar energy and wind energy conversion systems, shall meet
- the following standards: (1) Rooftop mechanical equipment shall be located consistent with one
- of the following methods: (A) (B)
- (2) The requirements of Section 9-7-7, "Building Height,
- Appurtenances," B.R.C. 1981, shall be met. (e) Mechanical Equipment on Other Horizontal Surfaces.
- M-1-27 BUILDING ARTICULATION
- (c) Building Facade Variety. See Figure M-1(52). All buildings 120 feet in width or greater along any Type A or B frontage shall fulfill the following requirements:
- (1) Increments. Each Type A or B frontage facade shall be varied in
- segments less than or equal to ninety feet. (2) Requirements.
- (3) Alternative Method of Compliance.
- M-1-28 BUILDING MASS
- Regulations are not required on the civic building per M-1-19 HEIGHT table.
- M-1-29 BUILDING PROPORTIONS (c) Use of Golden Ratio.



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Consultant

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LIGHTING AE DESIGN 1900 WAZEE STREET, #205 DENVER, CO 80202 T 303 296 3034

AV/TECHNOLOGY/SECURITY SALAS O'BRIEN 4900 NAUTILUS CT. N. SUITE 200

BOULDER, CO 80301 T 303 865 5500

Client and Project Information

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1155 Alpine Ave Boulder, CO 80302

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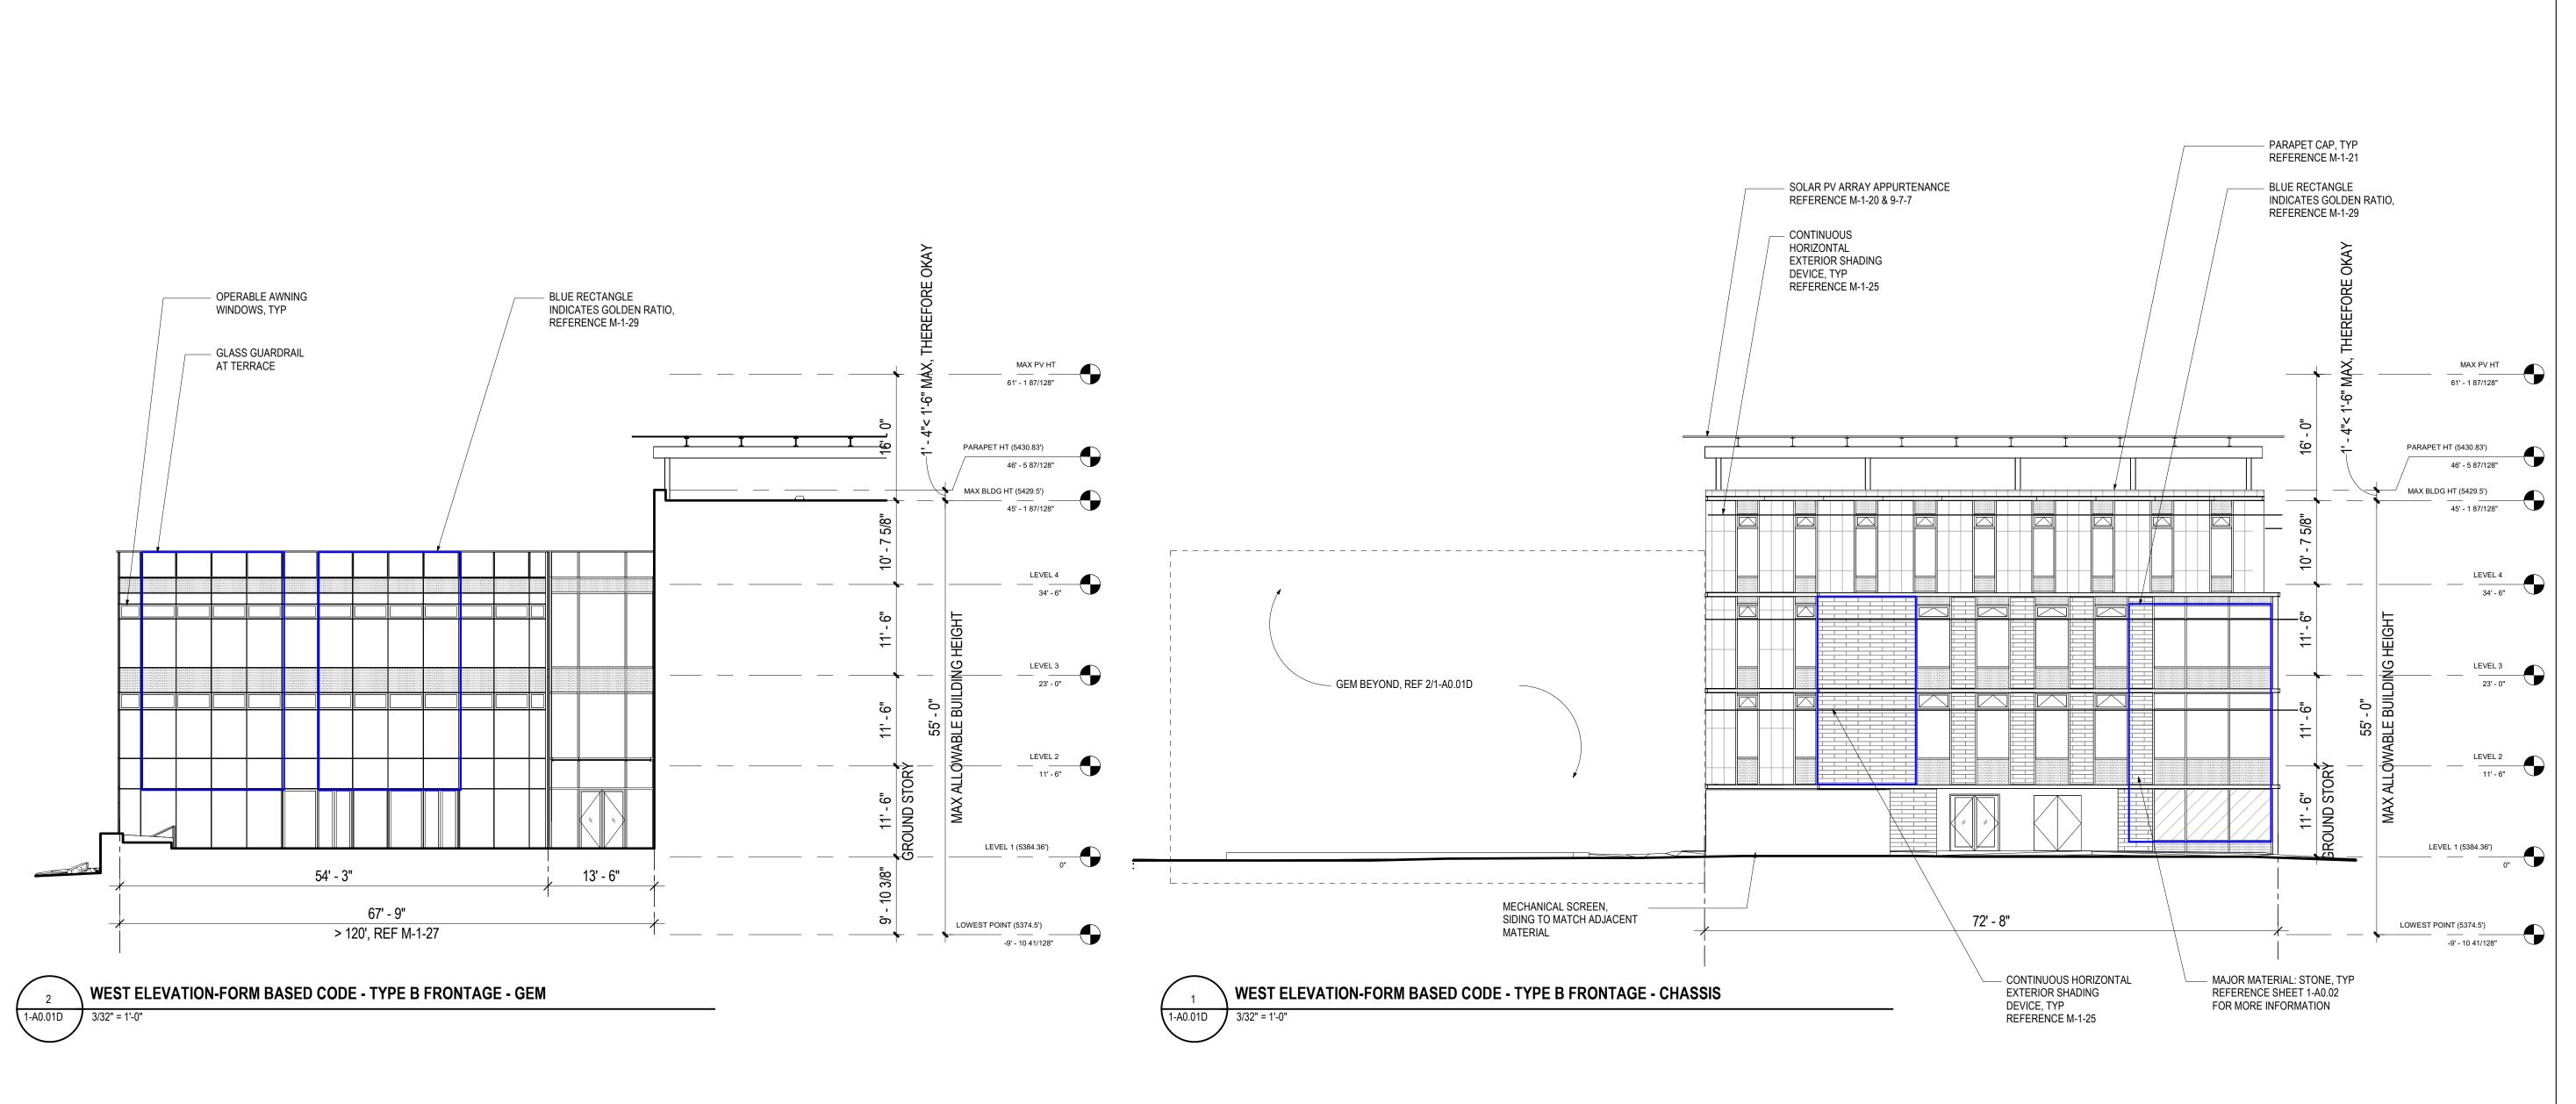
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**PAVILION - FORM BASED CODE - EAST** ELEVATION



Current Issue SITE REVIEW



# CITY OF BOULDER TITLE 9 - LAND USE CODE APPENDIX M - FORM BASED CODE COMPLIANCE

# CH. 1 - GENERAL PROVISIONS

- M-1-6 REGULATING PLANS
- (b) Alpine-Balsam Regulating Plan.

# CH. 2 - SITE DESIGN

Reference sheet 1-A0.00 for Architectural Site Plan and Civil and Lanscape Drawings for Site Design compliance information.

# CH. 3 - BUILDING TYPES

- M-1-14 DESCRIPTIONS OF BUILDING TYPES (e) Civic Building Type. Refer to Section M-1-19 for requirements.
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- M-1-20 MEASUREMENT OF BUILDING TYPE REQUIREMENTS
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- **M-1-21 -** CAP TYPES
- (b) Parapet Cap Type. (1) Parapet Height. Parapet Height is measured from the top of the upper story to the top of the parapet. (A) Minimum parapet height is two feet
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- (4) Roof terraces and roof decks are permitted on the parapet cap type. (5) Rooftop Appertenances. Any rooftop appertenance shall be located towards the rear or interior of the parapet roof. The parapet shall screen the mechanicals when viewed from the sidewalk across the street and from and adjacent outdoor space. See Section M-1-26, "Mechanical Equipment & Appurtenances," B.R.C. 1981, for additional requirements.
- CH. 4 BUILDING DESIGN
- M-1-23 FACADE MATERIALS
- (b) Major Materials. A minimum of eighty percent of each facade, not including windows and door areas, shall be faced of a single major material, not including architectural metal panel systems. Reference sheet 1-A0.02 for compliance information.
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- (3) Expression Lines of Surfaces.
- (c) Appropriate Grade of Materials.
- (d) Applique Materials.

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- M-1-25 BUILDING FACADE ELEMENTS
- (a) Windows. Windows on all buildings shall be constructed consistent with the following requirements:
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- (2) Recessed. All windows, with the exception of ground story storefront systems, shall be recessed with the glass a minimum of
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- (1) Rooftop mechanical equipment shall be located consistent with one of the following methods: (A) - (B)
- (2) The requirements of Section 9-7-7, "Building Height,
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- (e) Mechanical Equipment on Other Horizontal Surfaces.

# M-1-27 - BUILDING ARTICULATION

- (c) Building Facade Variety. See Figure M-1(52). All buildings 120 feet in width or greater along any Type A or B frontage shall fulfill the following requirements:
- (1) Increments. Each Type A or B frontage facade shall be varied in segments less than or equal to ninety feet.
- (2) Requirements.
- (3) Alternative Method of Compliance.
- M-1-28 BUILDING MASS

Regulations are not required on the civic building per M-1-19 HEIGHT table.

M-1-29 - BUILDING PROPORTIONS (c) Use of Golden Ratio.



DENVER LOS ANGELES NEW YORK PORTLAND SEATTLE WASHINGTON, DC VANCOUVER, BC 1350 17th Street, Suite 250 Denver, Colorado 80202 303.557.6420 www.zgf.com

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CIVII THE SANITAS GROUP 901 FRONT STREET, SUITE 350 LOUISVILLE, CO 80027

Consultant

T 303 481 2170

ENTITLEMENTS STUDIO ARCHITECTURE 2995 55TH STREET, #17983 BOULDER, CO 80301 T 720 491 1167

LANDSCAPE STUDIO TERRA INC. 758 CLUB CIRCLE LOUISVILLE, CO 80027 T 303 494 9138

STRUCTURAL ANTHEM STRUCTURAL ENGINEERS FLATIRON OFFICE PARK 2213 CENTRAL AVENUE BOULDER, CO 80301 T 303 848 8497 MFP

**BRANCH PATTERN** 3344 WALNUT STREET DENVER, CO 80205 T 303 382 1920

LIGHTING AE DESIGN 1900 WAZEE STREET, #205 DENVER, CO 80202 T 303 296 3034

AV/TECHNOLOGY/SECURITY SALAS O'BRIEN 4900 NAUTILUS CT. N. SUITE 200 BOULDER, CO 80301 T 303 865 5500

Full Design Team Roster on Sheet 1-G0.01





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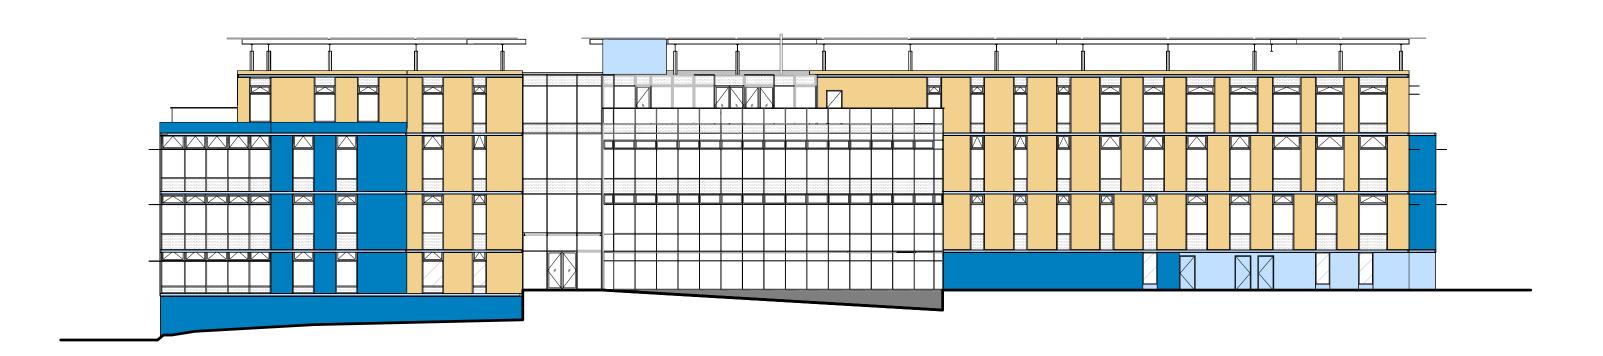
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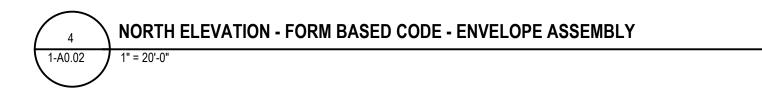
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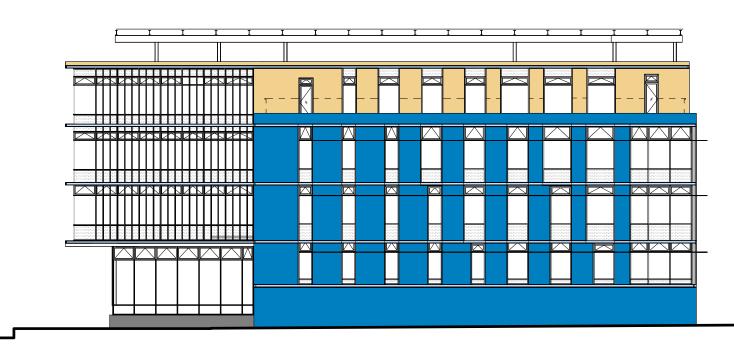











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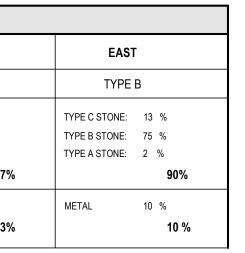


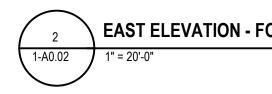


FBC FACADE MATERIALS							
	NORT	Ή	SOUT	гн	WES	т	
FRONTAGE TYPE	TYPE	A	TYPE	В	TYPE	В	
MAJOR MATERIAL 80% Minimum Required	TYPE C STONE: TYPE B STONE: TYPE A STONE:	51 % 28 % 2 %	TYPE C STONE: TYPE B STONE: TYPE A STONE:	46 % 38 % 1 %	TYPE C STONE: TYPE B STONE: TYPE A STONE:	41 % 45 % 1 %	
		85%		85%		87%	
MINOR MATERIAL 20% or Less Required	METAL	15 % <b>15%</b>	METAL	15 % <b>15%</b>	METAL	13 % <b>13%</b>	
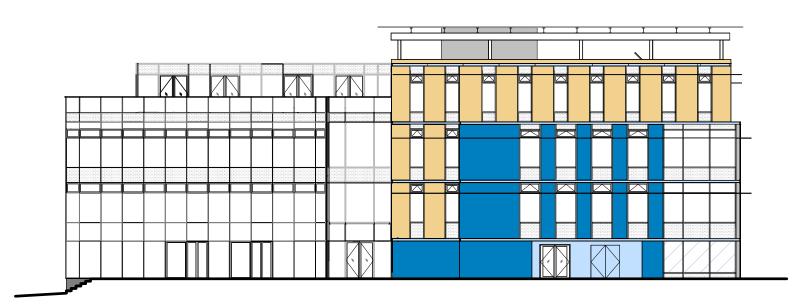
# EAST ELEVATION - FORM BASED CODE - ENVELOPE ASSEMBLY

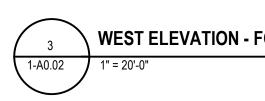WEST ELEVATION - FORM BASED CODE - ENVELOPE ASSEMBLY



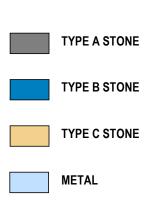



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CIVIL THE SANITAS GROUP 901 FRONT STREET, SUITE 350 LOUISVILLE, CO 80027

Consultant

T 303 481 2170

ENTITLEMENTS STUDIO ARCHITECTURE 2995 55TH STREET, #17983 BOULDER, CO 80301 T 720 491 1167

LANDSCAPE STUDIO TERRA INC. 758 CLUB CIRCLE LOUISVILLE, CO 80027 T 303 494 9138

STRUCTURAL ANTHEM STRUCTURAL ENGINEERS FLATIRON OFFICE PARK 2213 CENTRAL AVENUE BOULDER, CO 80301 T 303 848 8497

MEP BRANCH PATTERN 3344 WALNUT STREET DENVER, CO 80205 T 303 382 1920

LIGHTING AE DESIGN 1900 WAZEE STREET, #205 DENVER, CO 80202 T 303 296 3034

AV/TECHNOLOGY/SECURITY SALAS O'BRIEN

4900 NAUTILUS CT. N. SUITE 200 BOULDER, CO 80301 T 303 865 5500

Full Design Team Roster on Sheet 1-G0.01

Client and Project Information



Boulder Western City Campus - Volume 1-Pavilion Office Building

1155 Alpine Ave Boulder, CO 80302

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Revisions


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Sheet Title PAVILION - FORM BASED CODE -FACADE MATERIALS


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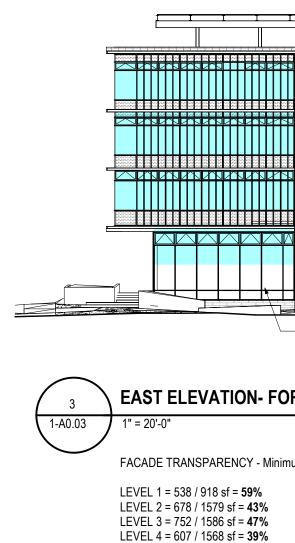
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Sheet Number





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- PORTION OF BASEMENT LEVEL EXPOSED ABOVE GRADE NOT INCLUDED IN TRANSPARENCY CALCULATION



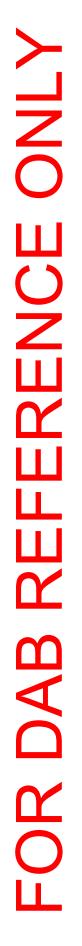

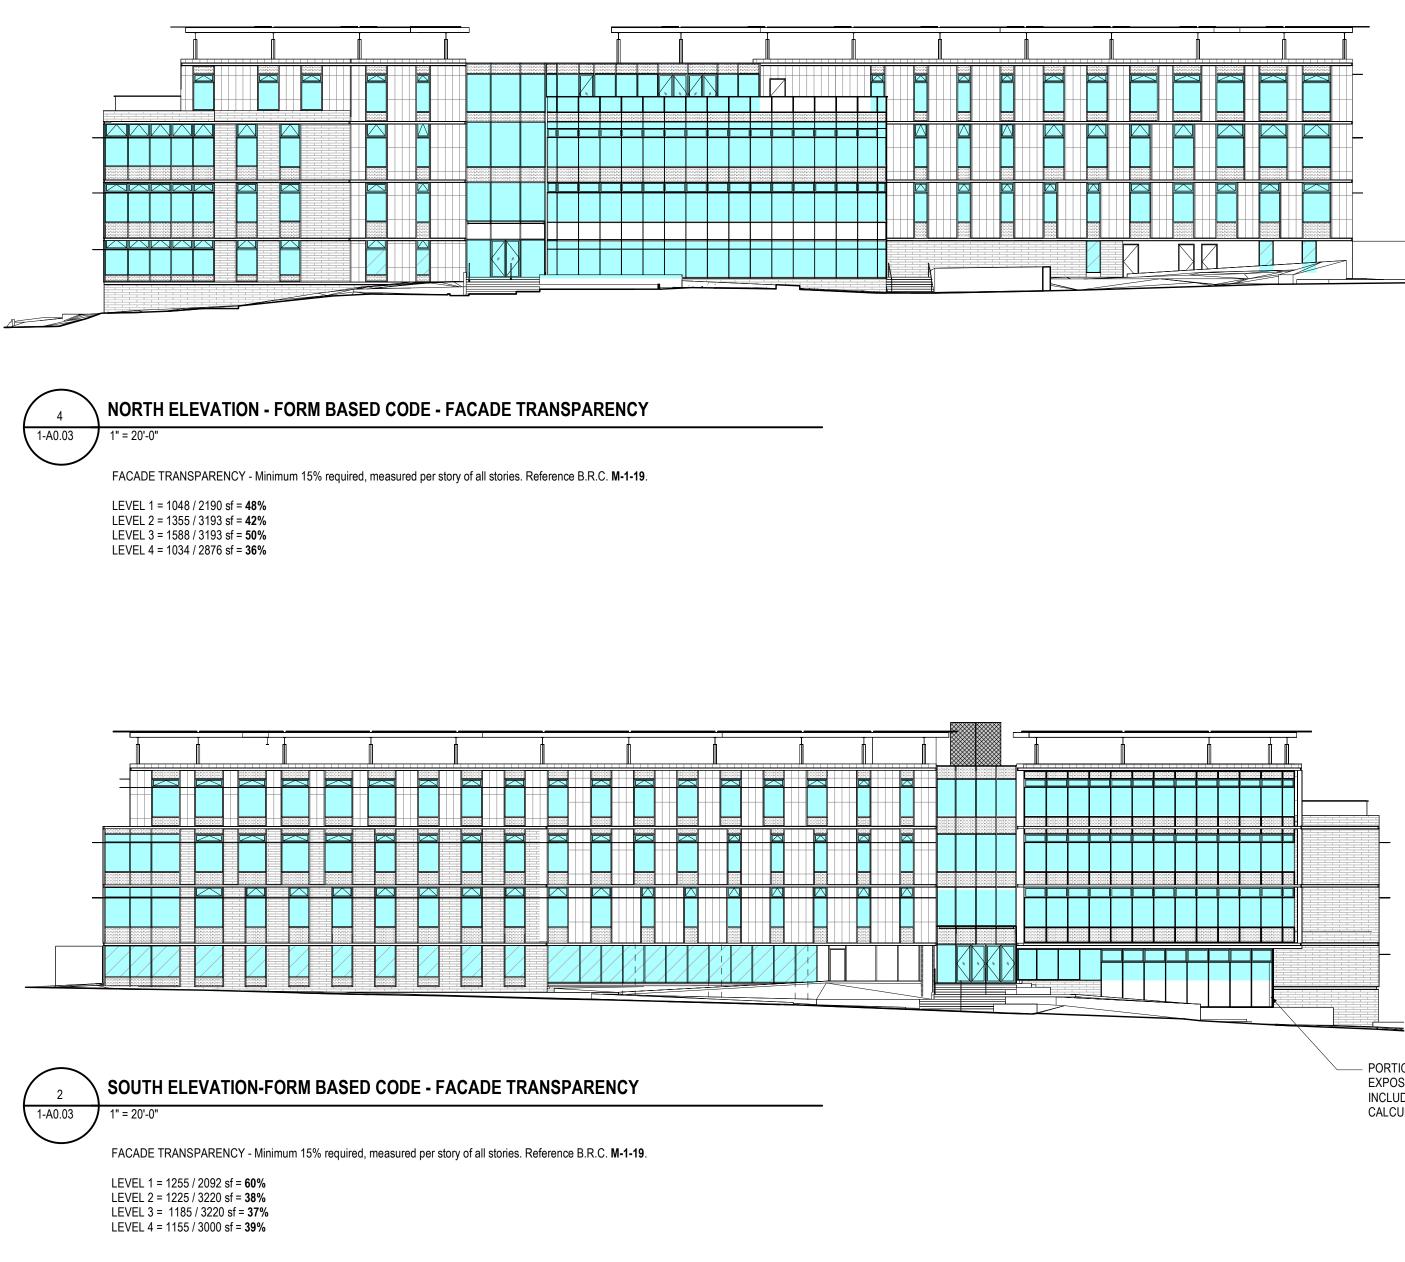

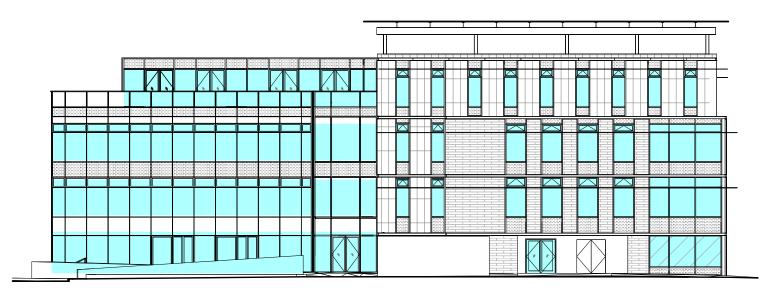 PORTION OF BASEMENT LEVEL EXPOSED ABOVE GRADE NOT INCLUDED IN TRANSPARENCY CALCULATION
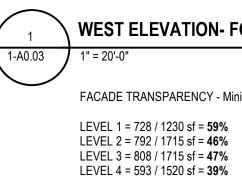
# **EAST ELEVATION- FORM BASED CODE - FACADE TRANSPARENCY**

FACADE TRANSPARENCY - Minimum 15% required, measured per story of all stories. Reference B.R.C. M-1-19.

# WEST ELEVATION- FORM BASED CODE - FACADE TRANSPARENCY

FACADE TRANSPARENCY - Minimum 15% required, measured per story of all stories. Reference B.R.C. M-1-19.



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ENTITLEMENTS STUDIO ARCHITECTURE 2995 55TH STREET, #17983 BOULDER, CO 80301 T 720 491 1167

LANDSCAPE STUDIO TERRA INC. 758 CLUB CIRCLE LOUISVILLE, CO 80027 T 303 494 9138

STRUCTURAL ANTHEM STRUCTURAL ENGINEERS FLATIRON OFFICE PARK 2213 CENTRAL AVENUE BOULDER, CO 80301 T 303 848 8497

MEP BRANCH PATTERN 3344 WALNUT STREET DENVER, CO 80205 T 303 382 1920

LIGHTING AE DESIGN 1900 WAZEE STREET, #205 DENVER, CO 80202 T 303 296 3034

AV/TECHNOLOGY/SECURITY SALAS O'BRIEN

4900 NAUTILUS CT. N. SUITE 200 BOULDER, CO 80301 T 303 865 5500

Full Design Team Roster on Sheet 1-G0.01

Client and Project Information



Boulder Western City Campus - Volume 1-Pavilion Office Building

1155 Alpine Ave Boulder, CO 80302

Original Issue

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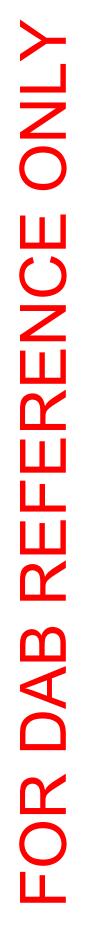
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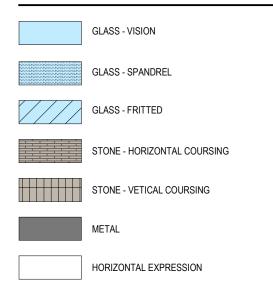
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Consultant

ENTITLEMENTS STUDIO ARCHITECTURE 2995 55TH STREET, #17983 BOULDER, CO 80301 T 720 491 1167 LANDSCAPE

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Boulder Western City Campus - Volume 1-Pavilion Office Building

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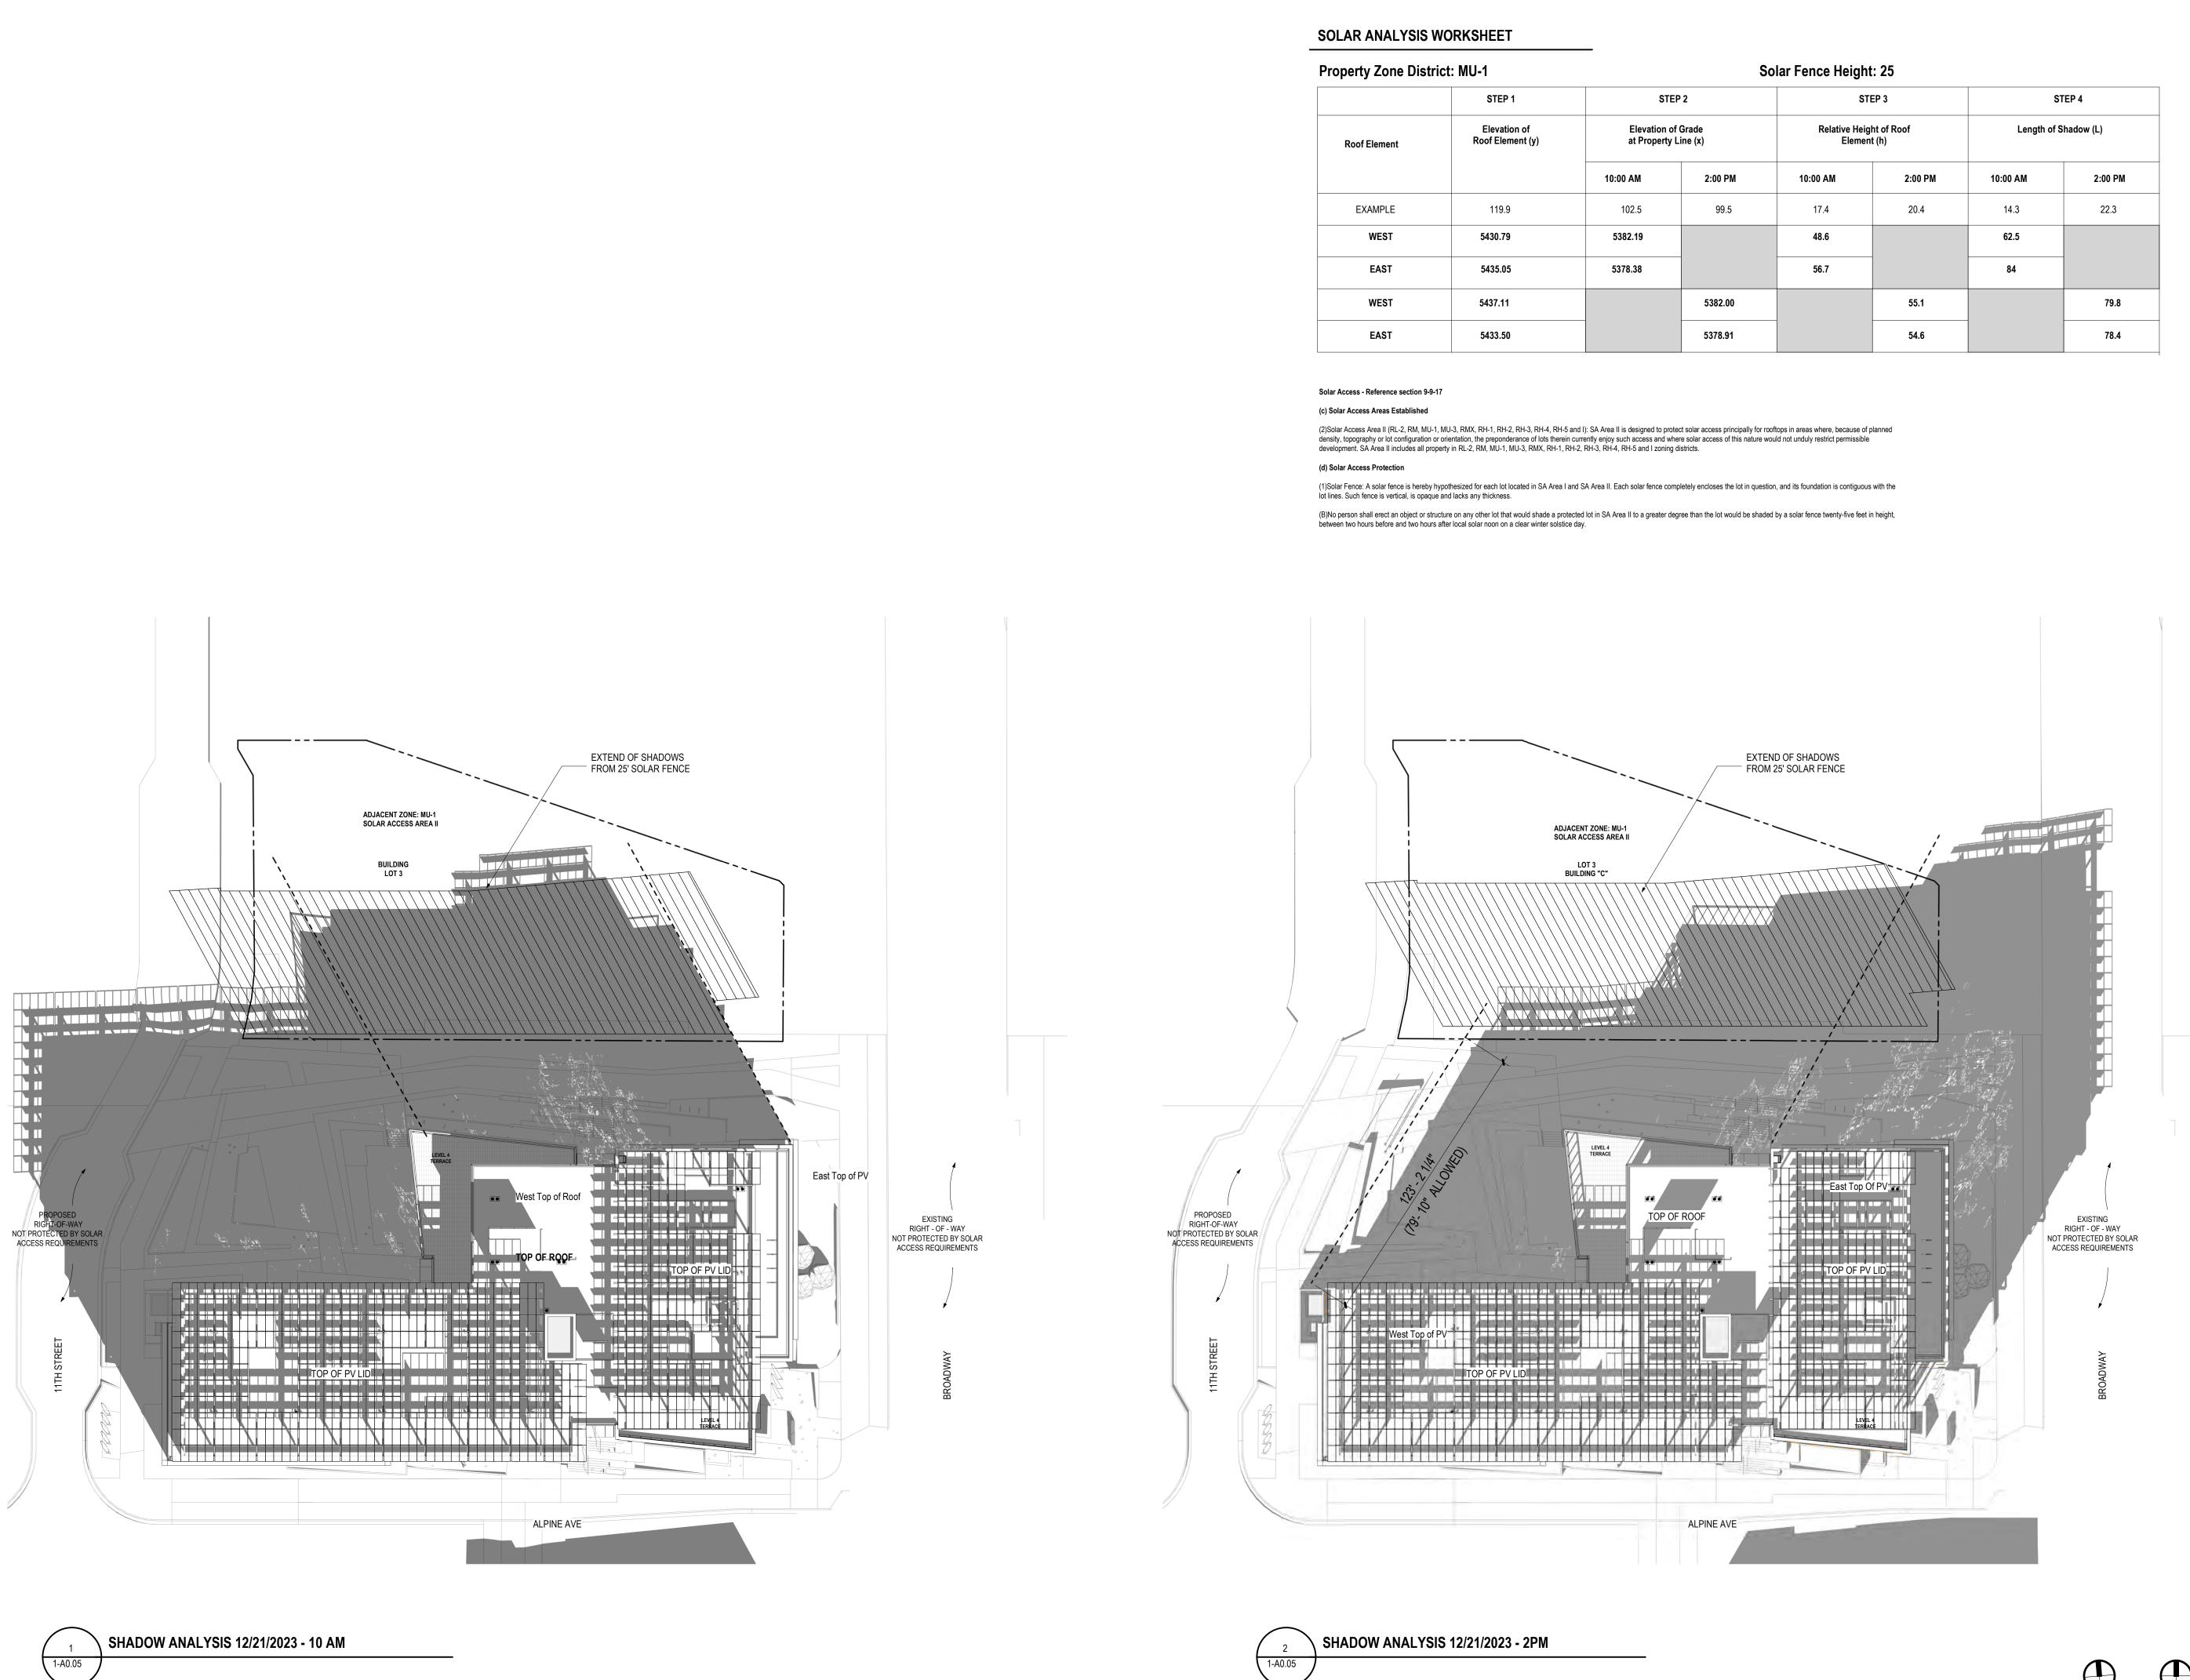
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WEST	5430.79	5382.19		48.6		62.5	
EAST	5435.05	5378.38		56.7	-	84	
WEST	5437.11		5382.00		55.1		79.8
EAST	5433.50		5378.91		54.6		78.4



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Consultant

T 303 481 2170

ENTITLEMENTS STUDIO ARCHITECTURE 2995 55TH STREET, #17983 BOULDER, CO 80301 T 720 491 1167 LANDSCAPE

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STRUCTURAL ANTHEM STRUCTURAL ENGINEERS FLATIRON OFFICE PARK 2213 CENTRAL AVENUE BOULDER, CO 80301 T 303 848 8497

MFP **BRANCH PATTERN** 3344 WALNUT STREET DENVER, CO 80205 T 303 382 1920

LIGHTING AE DESIGN 1900 WAZEE STREET, #205 DENVER, CO 80202 T 303 296 3034

AV/TECHNOLOGY/SECURITY SALAS O'BRIEN 4900 NAUTILUS CT. N. SUITE 200

BOULDER, CO 80301 T 303 865 5500

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Sheet Status NOT FOR CONSTRUCTION

Sheet Title **PAVILION - FORM** BASED CODE **DIAGRAMS - SHADOW** ANALYSIS

1-A0.05

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Sheet Number

Current Issue Date





TRUE NORTH PROJECT NORTH



PERSPECTIVE — SOUTHEAST VIEW FROM CAMPUS GATEWAY AT BROADWAY AND ALPINE AVE



PERSPECTIVE — NORTHWEST VIEW FROM PLAZA

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PERSPECTIVE — NORTHEAST VIEW FROM BRAODWAY AND PASEO





NOTES: IMAGES REPRESENT THREE-DIMENSIONAL PERSPECTIVES ILLUSTRATING THE SURROUNDING CONTEXT FOR VIEW AND SCALE



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STRUCTURAL ANTHEM STRUCTURAL ENGINEERS FLATIRON OFFICE PARK 2213 CENTRAL AVENUE BOULDER, CO 80301 T 303 848 8497 MEP

**BRANCH PATTERN** 3344 WALNUT STREET DENVER, CO 80205 T 303 382 1920

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T 303 865 5500

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> **PAVILION - FORM** BASED CODE - 3D VIEWS

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PERFERATED METAL PANEL (BRONZE VARIATION)

METAL WALL PANEL (BRONZE VARIATION)


STONE TYPE C (LIMESTONE) VERTICAL ORIENTATION, HONED FINISH

STONE TYPE B (LIMESTONE) HORIZONTAL ORIENTATION, ROUGH FINISH

MORTAR GROUT FOR STONE TYPE B

STONE TYPE A, REFER TO LANDSCAPE DRAWINGS —

# FBC - EXTERIOR MATERIALS BOARD

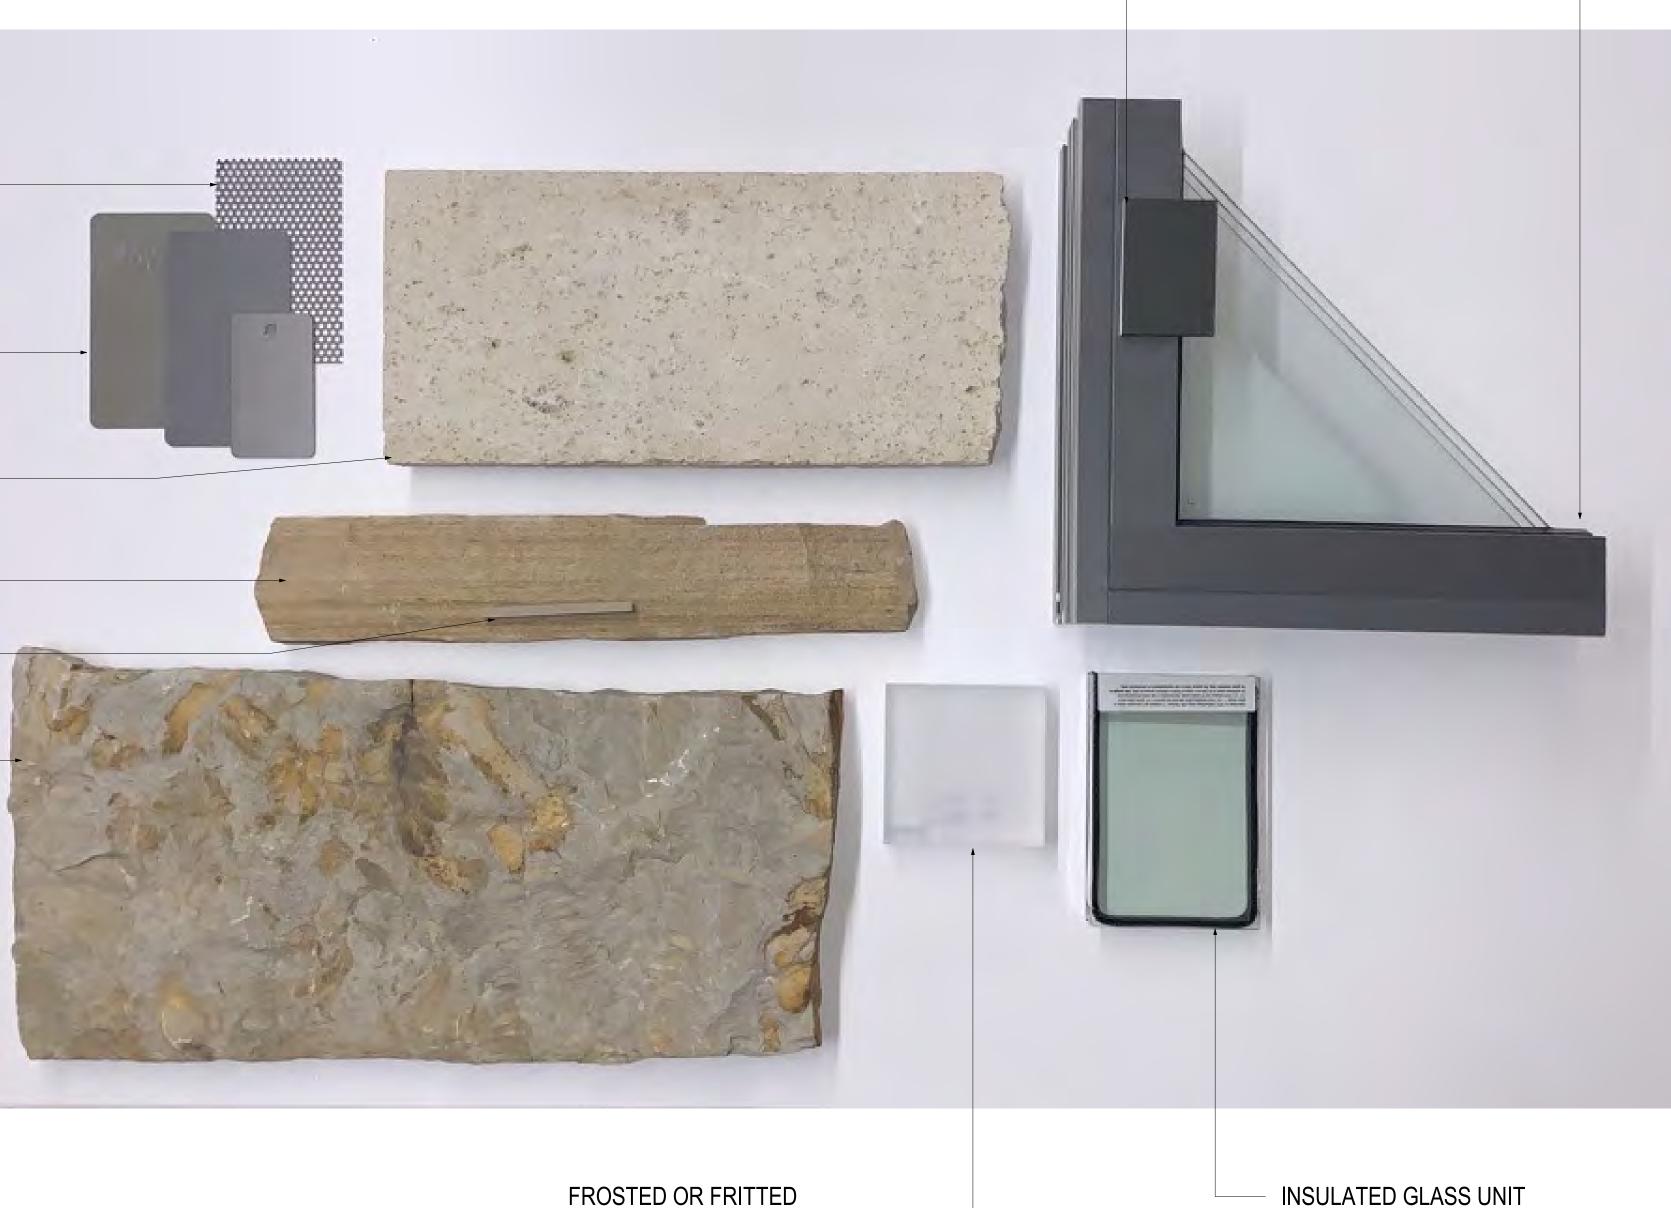

FROSTED OR FRITTED GLASS AT LEVEL 1

# INSULATED GLASS UNIT, FRAME --- INSULATED GLASS UNIT, FINISH

ZIMMER GUNSUL FRASCA ARCHITECTS LLP

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Full Design Team Roster on Sheet 1-G0.01

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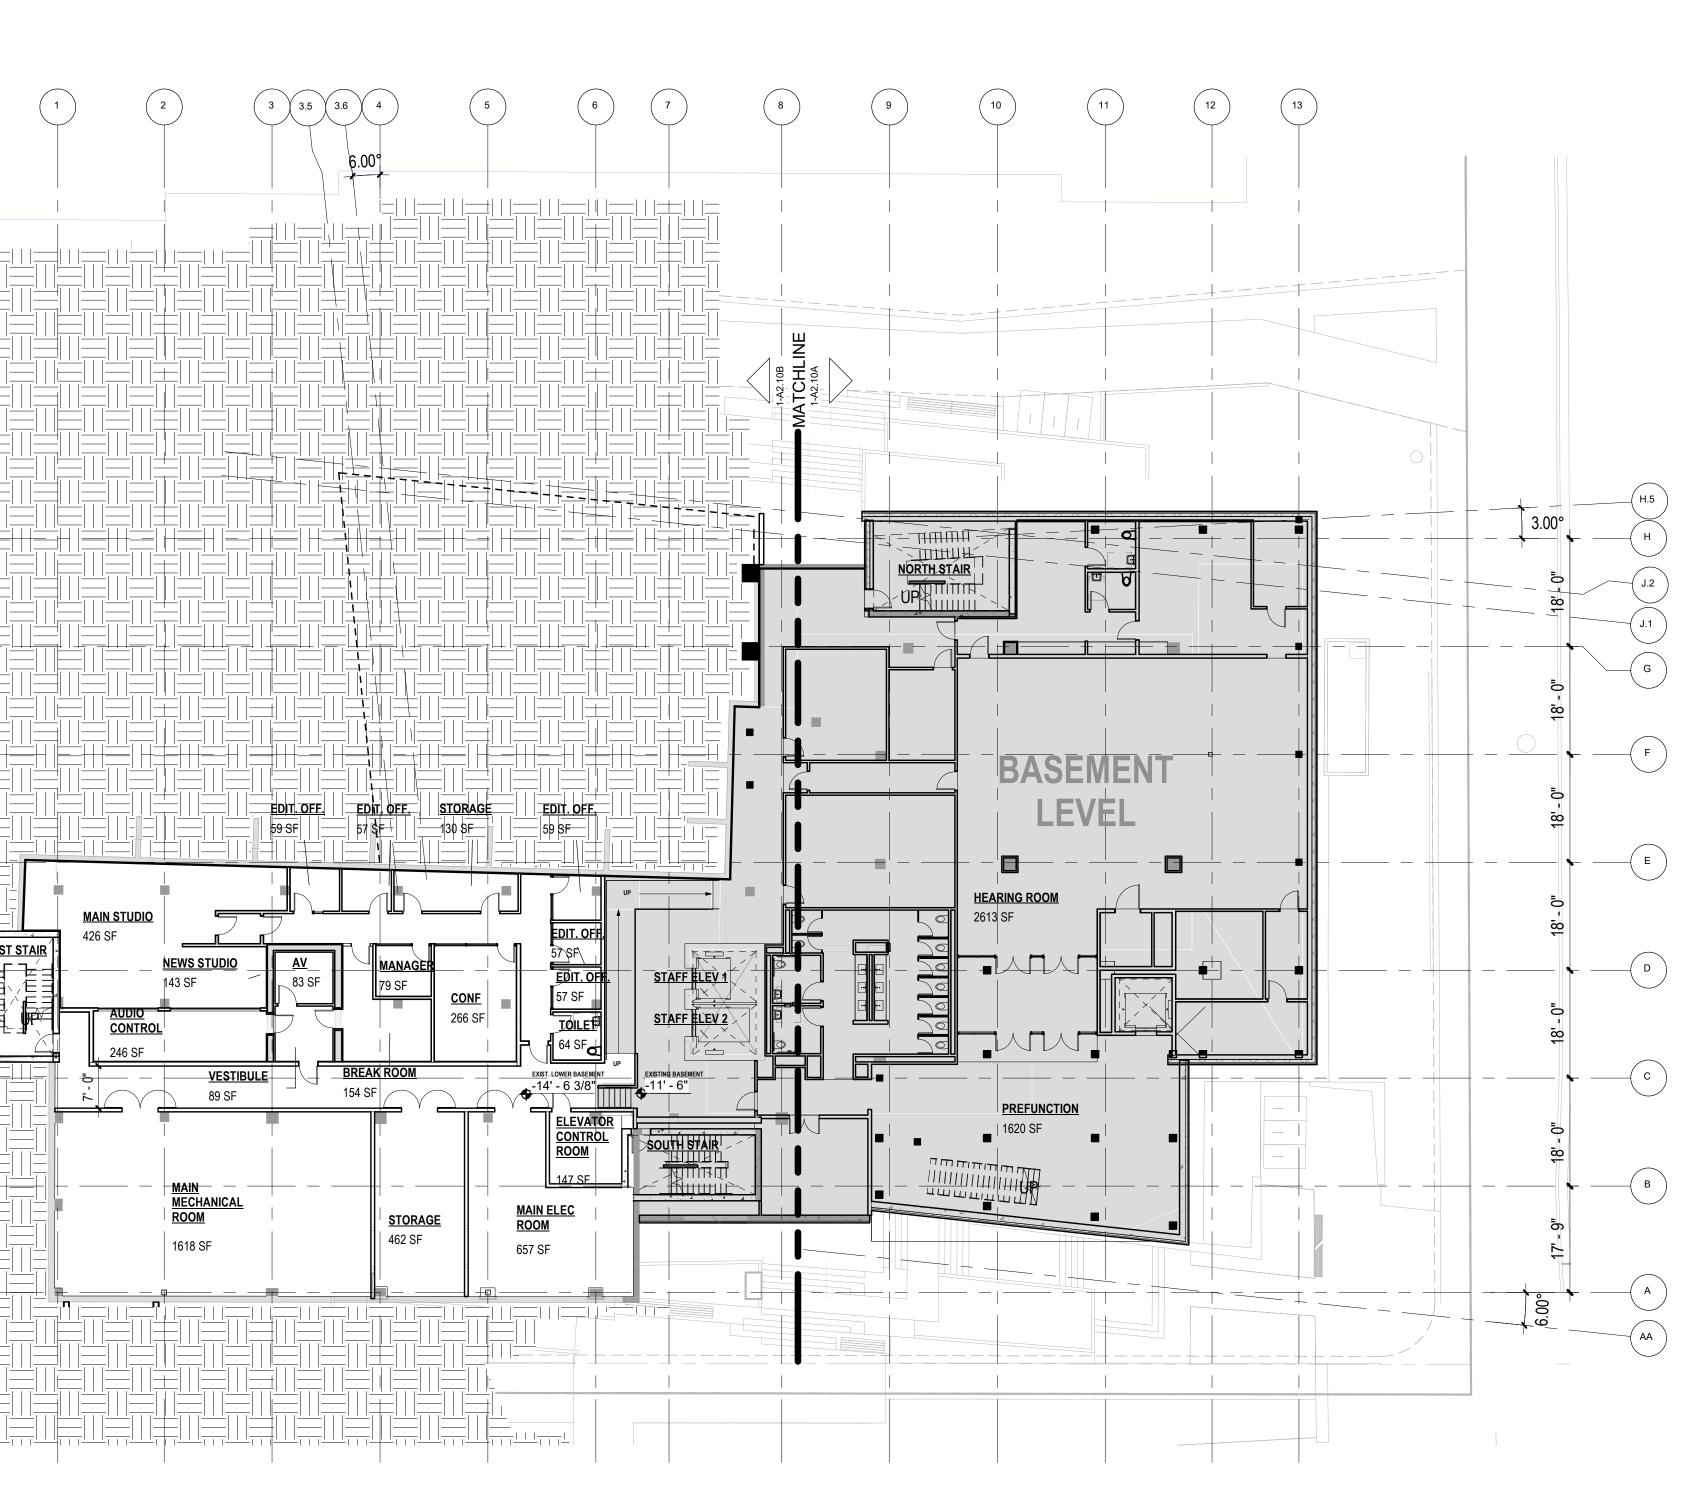
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 1
 LOWER BASEMENT FLOOR PLAN, SHELL & CORE

 1-A2.10
 1/16" = 1'-0"

# GENERAL NOTES

1. ALL WALLS SUPPORTED AT RAISED FLOOR AND TO STRUCTURE ABOVE UNLESS NOTED OTHERWISE. 2. REFER TO WALL SECTIONS FOR ADDITIONAL INFORMATION AT EXTERIOR WALLS AND SOFFIT ASSEMBLIES. 3. REFER TO LIFE SAFETY SHEET 1-LS0.01 FOR LOCATION AND EXTENT OF ALL FIRE RATED ASSEMBLIES. 4. SEE MECHANICAL, ELECTRICAL, AND PLUMBING DRAWINGS FOR ADDITIONAL OPENINGS IN WALLS. 5. ALL DOORS ARE 4" FROM FACE OF SCHEDULED PARTITION TO INSIDE FACE OF FRAME UNLESS NOTED OTHERWISE. 6. SEE SHEET 1-G0.03 FOR LEGENDS AND ABBREVIATIONS. 7. ALL WALLS TYPE UNO.





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STUDIO TERRA INC. 758 CLUB CIRCLE LOUISVILLE, CO 80027 T 303 494 9138

STRUCTURAL ANTHEM STRUCTURAL ENGINEERS FLATIRON OFFICE PARK 2213 CENTRAL AVENUE BOULDER, CO 80301 T 303 848 8497 MEP

BRANCH PATTERN 3344 WALNUT STREET DENVER, CO 80205 T 303 382 1920

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Full Design Team Roster on Sheet 1-G0.01





Boulder Western City Campus - Volume 1-Pavilion Office Building

1155 Alpine Ave Boulder, CO 80302

Original Issue


Key Plan and Orientation

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Sheet Title PLAN, FLOOR - LOWER BASEMENT, SHELL & CORE



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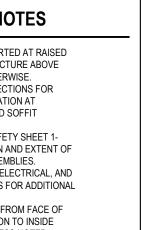
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ENTITLEMENTS STUDIO ARCHITECTURE 2995 55TH STREET, #17983 BOULDER, CO 80301 T 720 491 1167 LANDSCAPE

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Sheet Title PLAN, FLOOR - LOWER BASEMENT, WEST ENLARGED

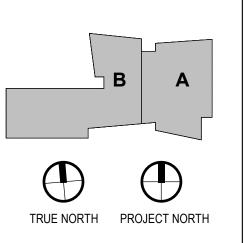


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 1
 BASEMENT FLOOR PLAN, SHELL & CORE

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 1/16" = 1'-0"

# GENERAL NOTES

1. ALL WALLS SUPPORTED AT RAISED FLOOR AND TO STRUCTURE ABOVE UNLESS NOTED OTHERWISE. 2. REFER TO WALL SECTIONS FOR ADDITIONAL INFORMATION AT EXTERIOR WALLS AND SOFFIT ASSEMBLIES. 3. REFER TO LIFE SAFETY SHEET 1-LS0.01 FOR LOCATION AND EXTENT OF ALL FIRE RATED ASSEMBLIES. 4. SEE MECHANICAL, ELECTRICAL, AND PLUMBING DRAWINGS FOR ADDITIONAL OPENINGS IN WALLS. 5. ALL DOORS ARE 4" FROM FACE OF SCHEDULED PARTITION TO INSIDE FACE OF FRAME UNLESS NOTED OTHERWISE. 6. SEE SHEET 1-G0.03 FOR LEGENDS AND ABBREVIATIONS. 7. ALL WALLS TYPE UNO.



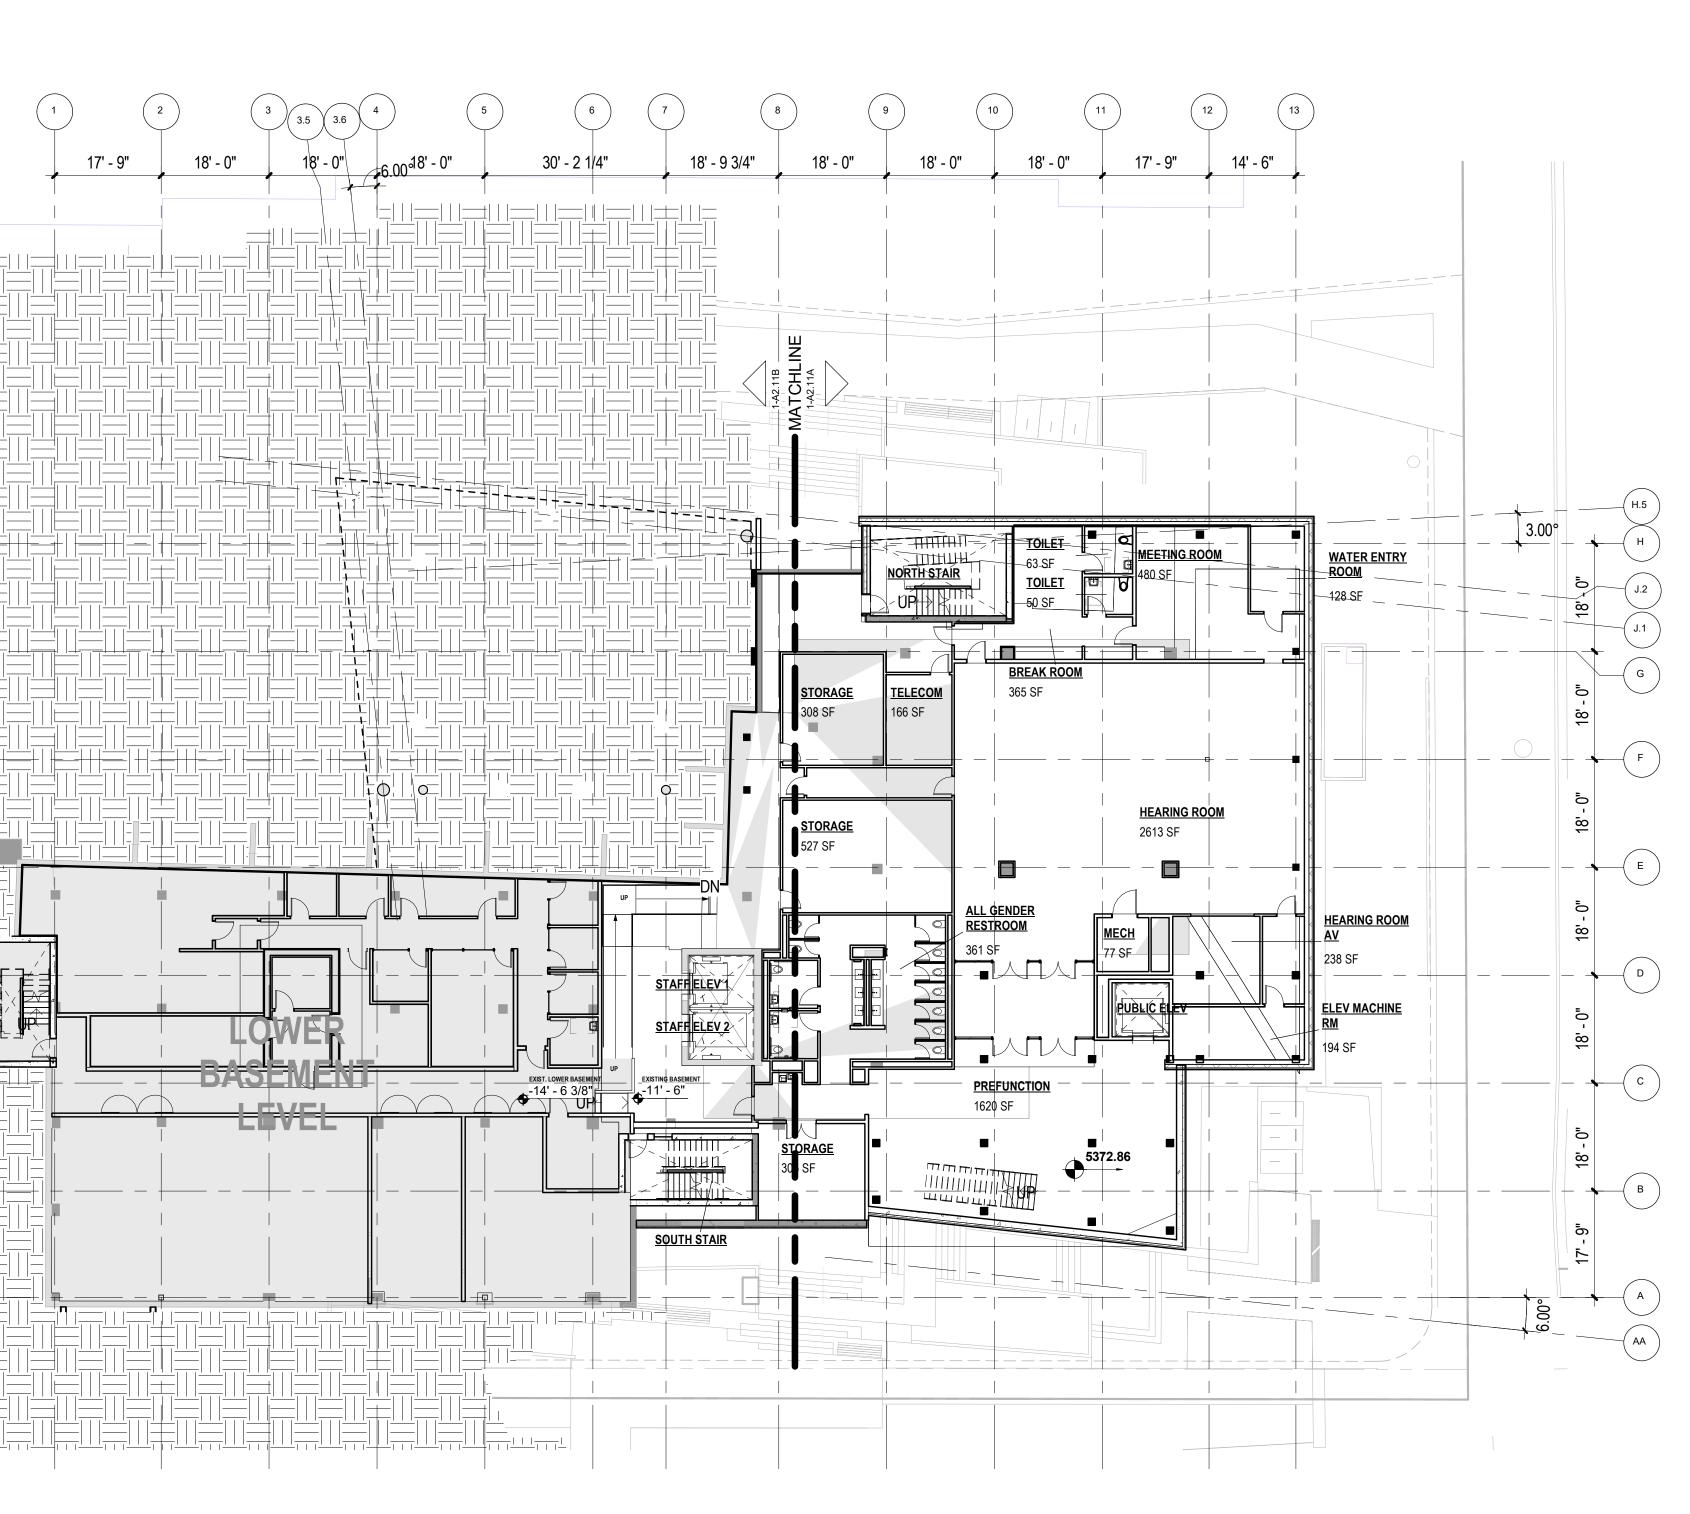

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CIVIL THE SANITAS GROUP 901 FRONT STREET, SUITE 350 LOUISVILLE, CO 80027 T 303 481 2170

ENTITLEMENTS STUDIO ARCHITECTURE 2995 55TH STREET, #17983 BOULDER, CO 80301 T 720 491 1167 LANDSCAPE

STUDIO TERRA INC. 758 CLUB CIRCLE LOUISVILLE, CO 80027 T 303 494 9138

STRUCTURAL ANTHEM STRUCTURAL ENGINEERS FLATIRON OFFICE PARK 2213 CENTRAL AVENUE BOULDER, CO 80301 T 303 848 8497

MEP BRANCH PATTERN 3344 WALNUT STREET DENVER, CO 80205 T 303 382 1920

LIGHTING AE DESIGN 1900 WAZEE STREET, #205 DENVER, CO 80202 T 303 296 3034

AV/TECHNOLOGY/SECURITY SALAS O'BRIEN 4900 NAUTILUS CT. N. SUITE 200 BOULDER, CO 80301

T 303 865 5500 Full Design Team Roster on Sheet 1-G0.01

Client and Project Information



Boulder Western City Campus - Volume 1-Pavilion Office Building

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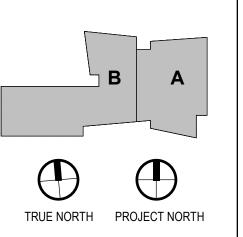
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Key Plan and Orientation

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Sheet Title PLAN, FLOOR -BASEMENT, SHELL & CORE



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# **GENERAL NOTES**

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CIVIL THE SANITAS GROUP 901 FRONT STREET, SUITE 350 LOUISVILLE, CO 80027 T 303 481 2170

ENTITLEMENTS STUDIO ARCHITECTURE 2995 55TH STREET, #17983 BOULDER, CO 80301 T 720 491 1167 LANDSCAPE

STUDIO TERRA INC. 758 CLUB CIRCLE LOUISVILLE, CO 80027 T 303 494 9138

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Client and Project Information



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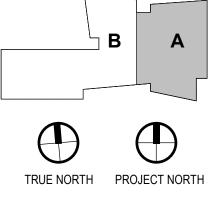
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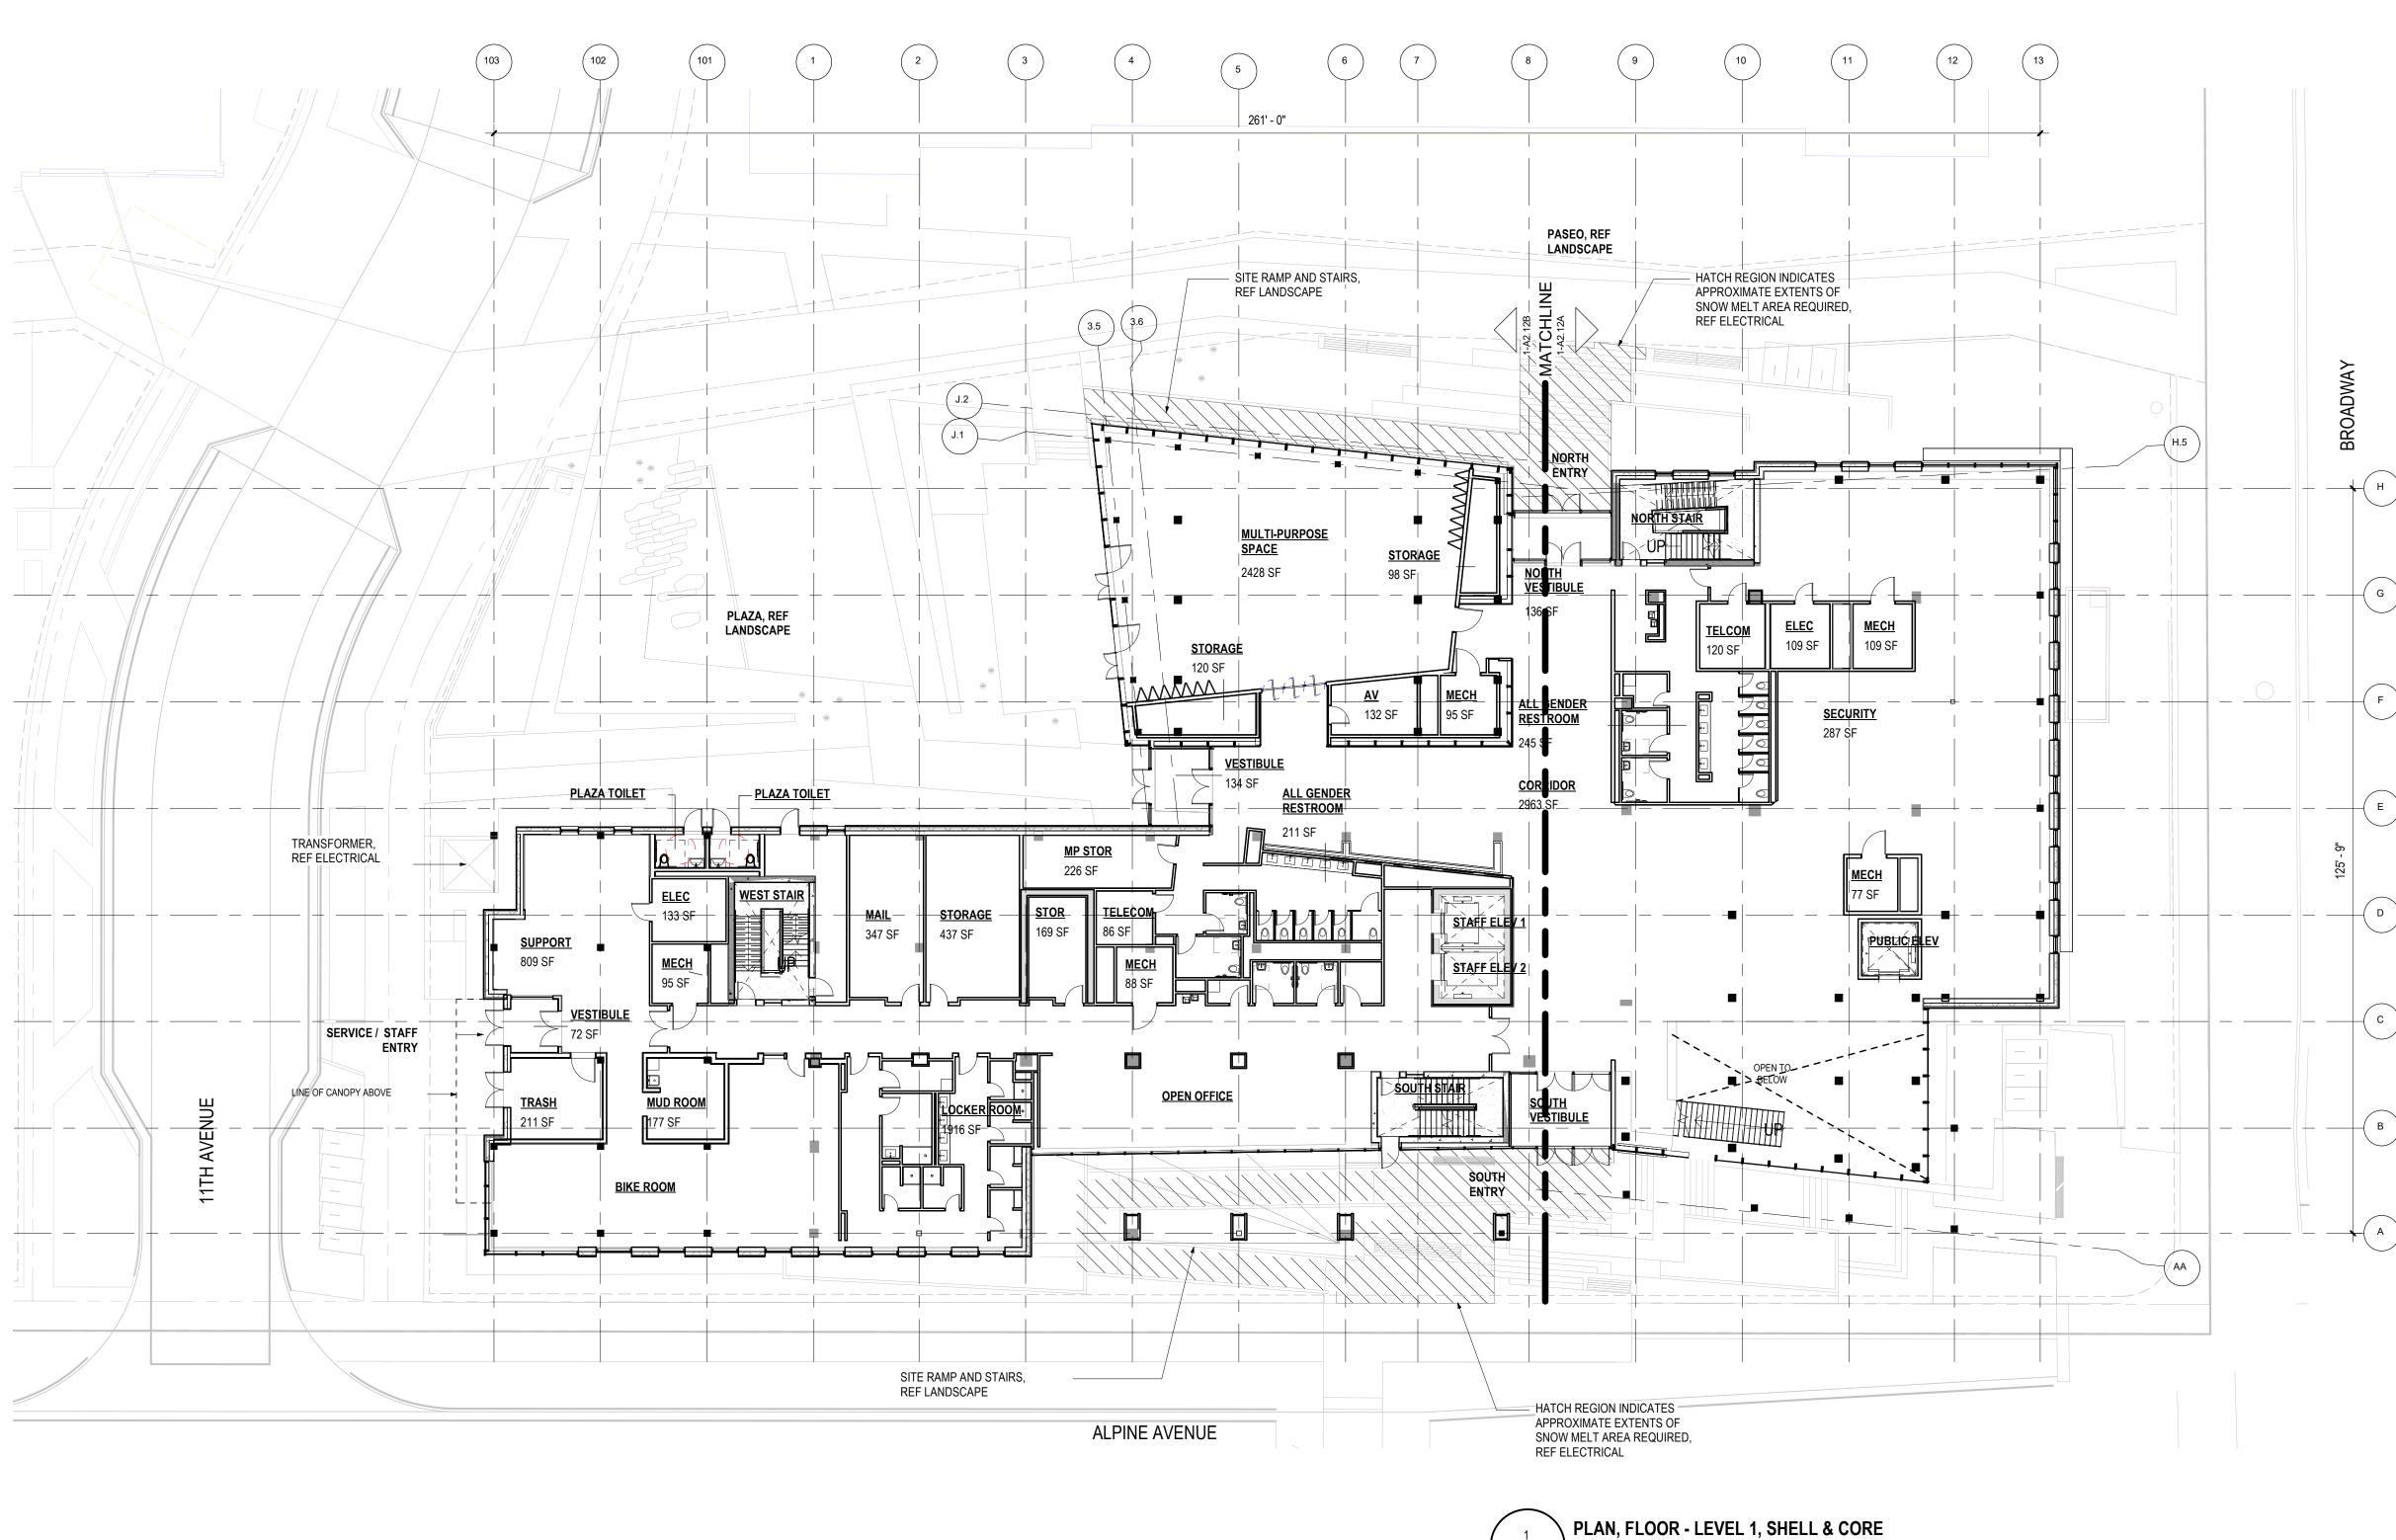


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 1/16" = 1'-0"

# GENERAL NOTES

1. ALL WALLS SUPPORTED AT RAISED FLOOR AND TO STRUCTURE ABOVE UNLESS NOTED OTHERWISE. 2. REFER TO WALL SECTIONS FOR ADDITIONAL INFORMATION AT EXTERIOR WALLS AND SOFFIT ASSEMBLIES. 3. REFER TO LIFE SAFETY SHEET 1-LS0.01 FOR LOCATION AND EXTENT OF ALL FIRE RATED ASSEMBLIES. 4. SEE MECHANICAL, ELECTRICAL, AND PLUMBING DRAWINGS FOR ADDITIONAL OPENINGS IN WALLS. 5. ALL DOORS ARE 4" FROM FACE OF SCHEDULED PARTITION TO INSIDE FACE OF FRAME UNLESS NOTED OTHERWISE. 6. SEE SHEET 1-G0.03 FOR LEGENDS AND ABBREVIATIONS. 7. ALL WALLS TYPE UNO.





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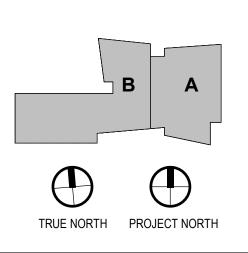
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Sheet Title PLAN, FLOOR - LEVEL 1, SHELL & CORE






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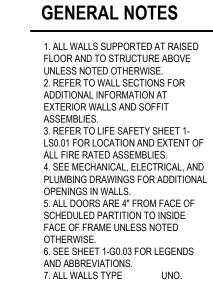
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PLAN, FLOOR- LEVEL 1 RAISED - EAST ENLARGED





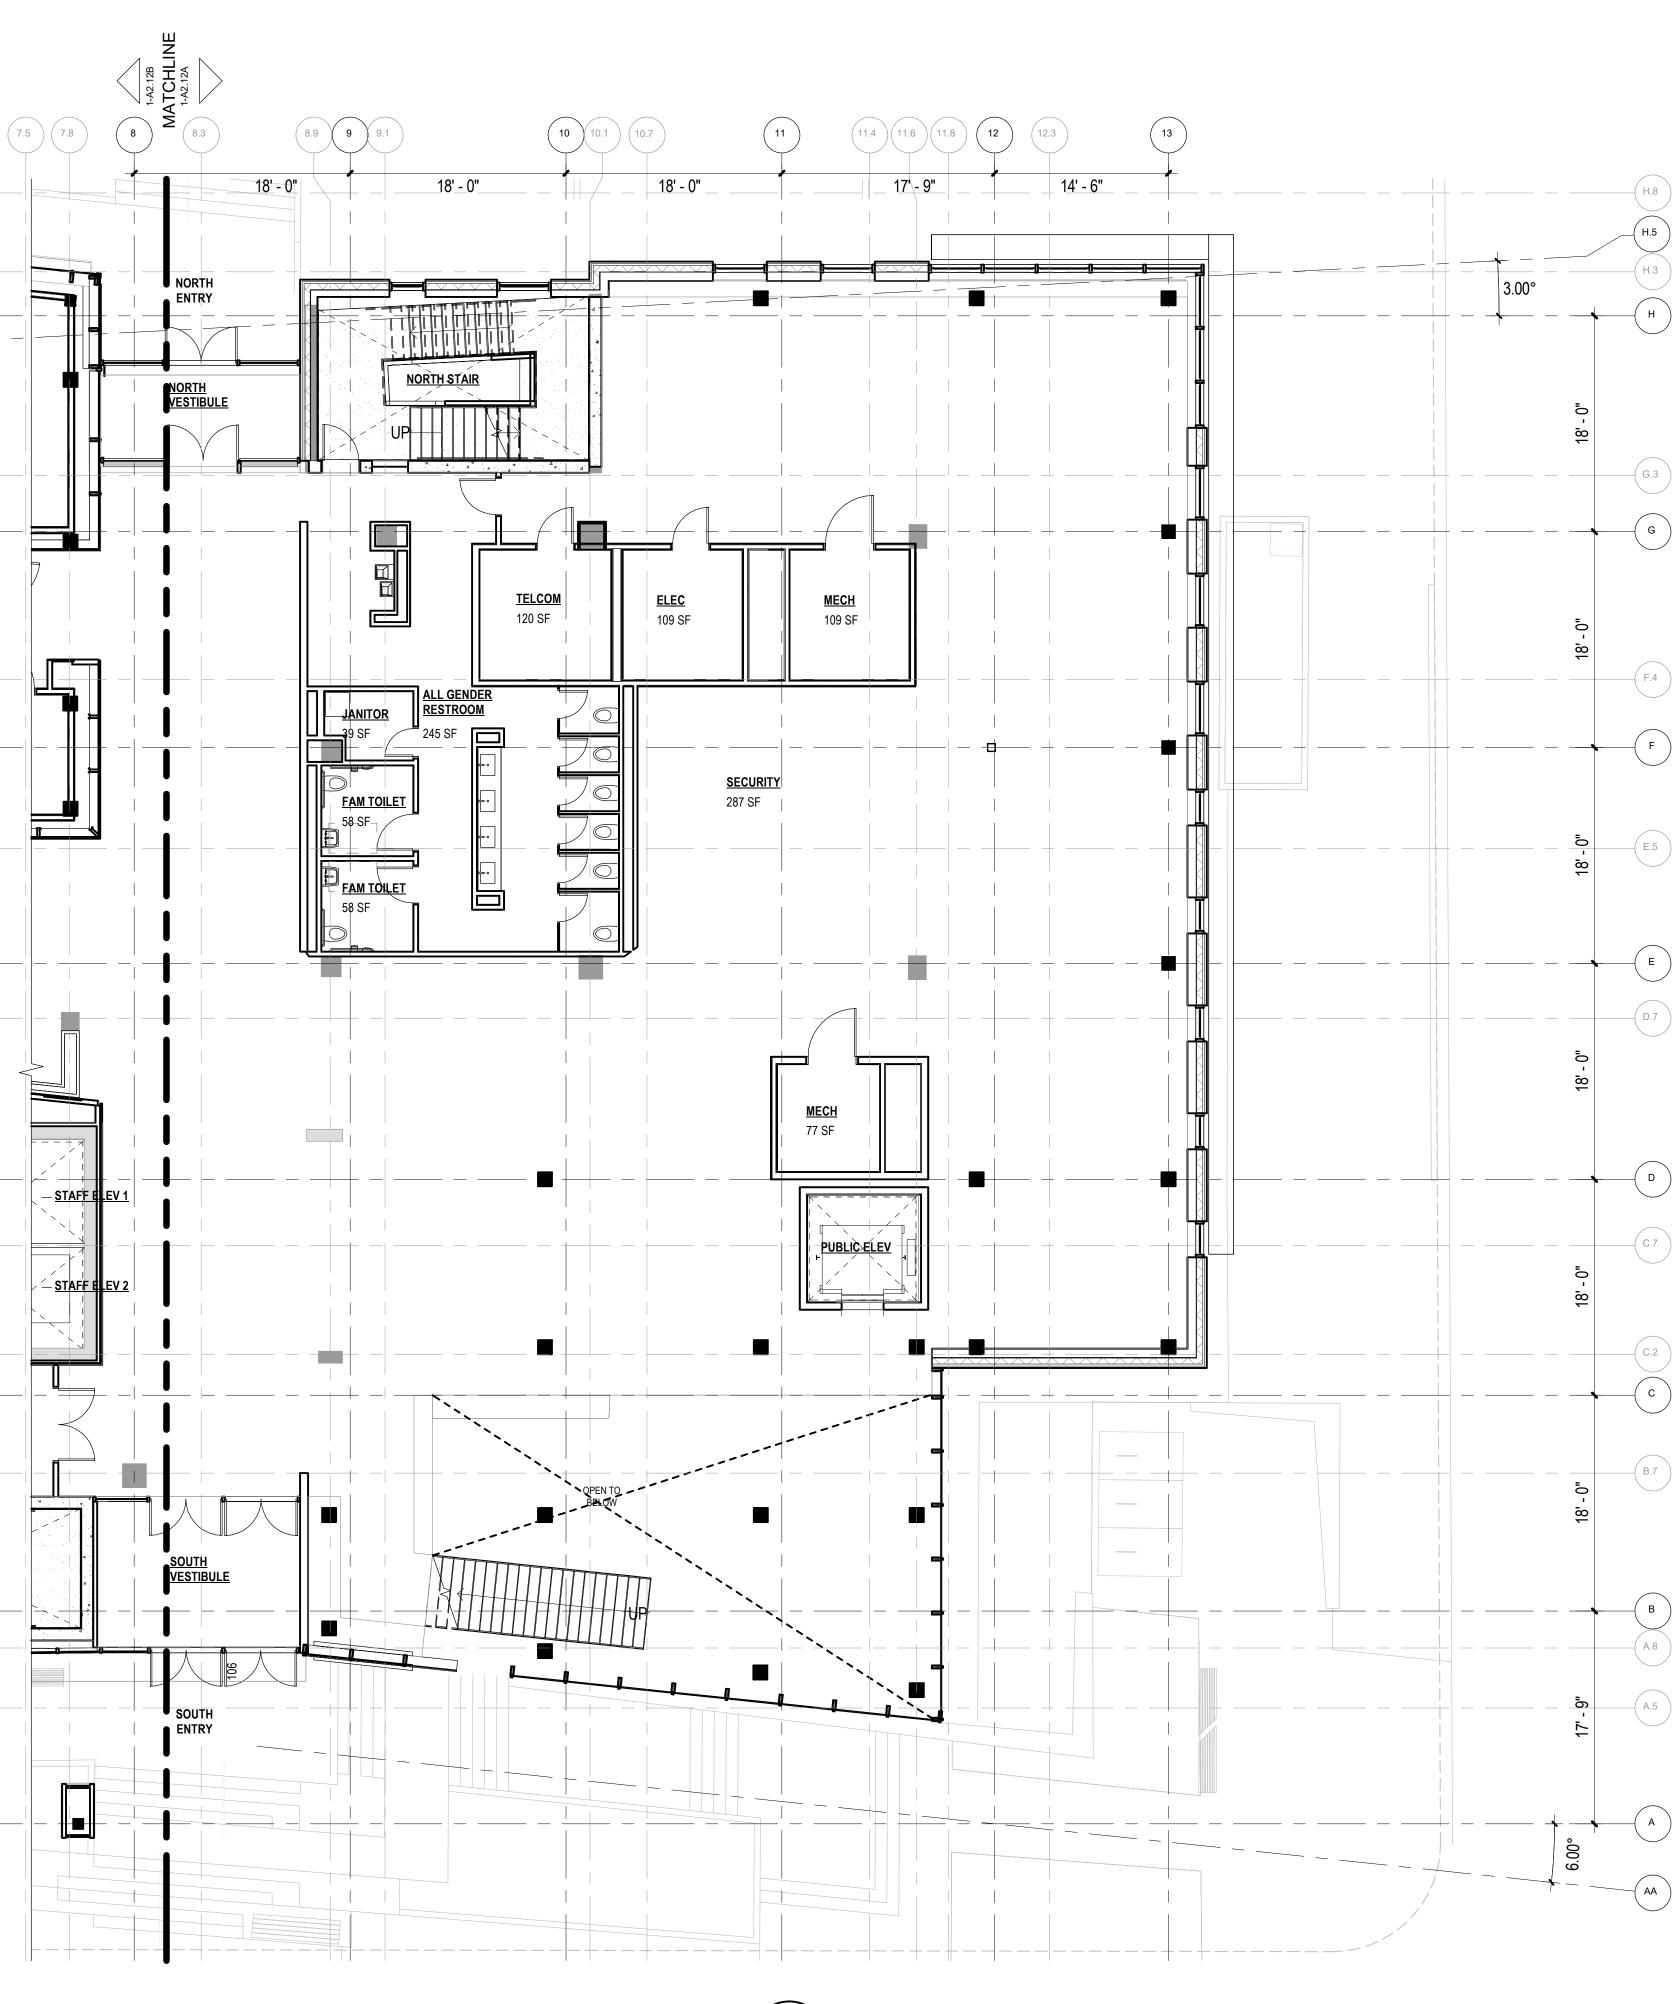

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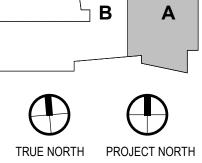
Sheet Title PLAN, FLOOR - LEVEL 1, EAST ENLARGED



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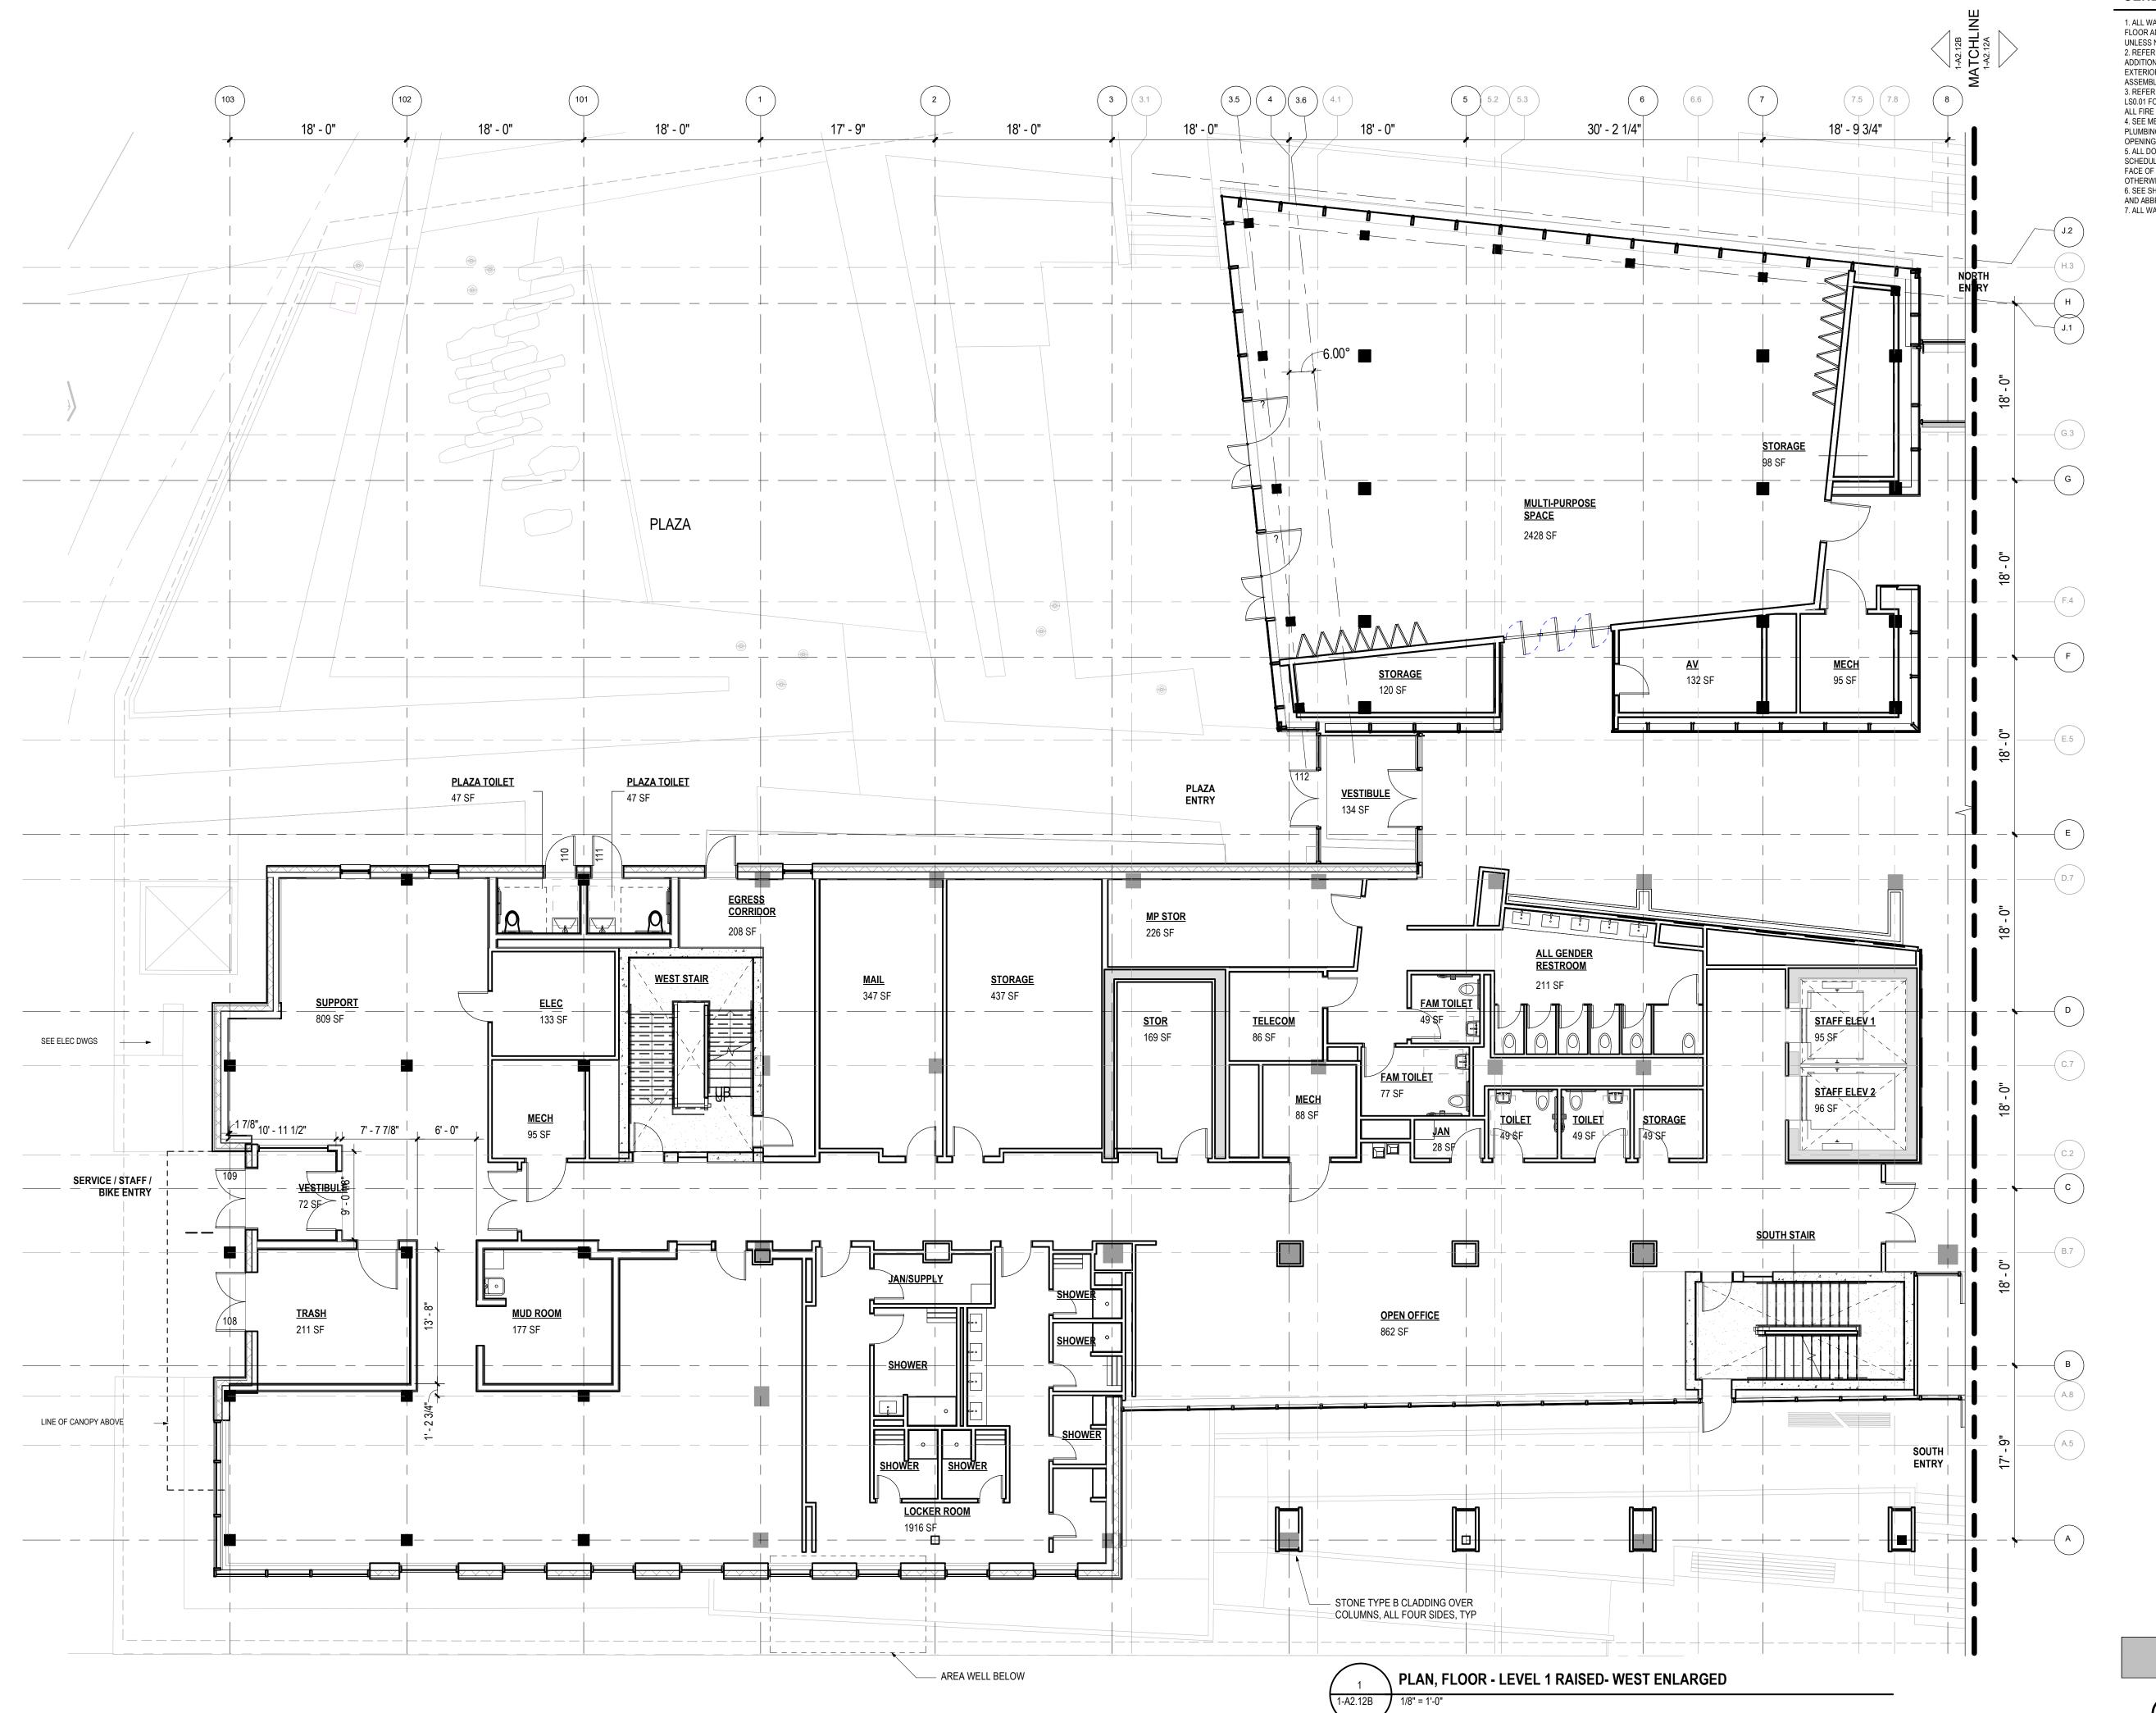
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### GENERAL NOTES

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MEP BRANCH PATTERN 3344 WALNUT STREET DENVER, CO 80205 T 303 382 1920

LIGHTING AE DESIGN 1900 WAZEE STREET, #205 DENVER, CO 80202 T 303 296 3034

AV/TECHNOLOGY/SECURITY SALAS O'BRIEN

4900 NAUTILUS CT. N. SUITE 200 BOULDER, CO 80301 T 303 865 5500

Full Design Team Roster on Sheet 1-G0.01

Client and Project Information



Boulder Western City Campus - Volume 1-Pavilion Office Building

1155 Alpine Ave Boulder, CO 80302

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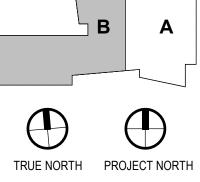
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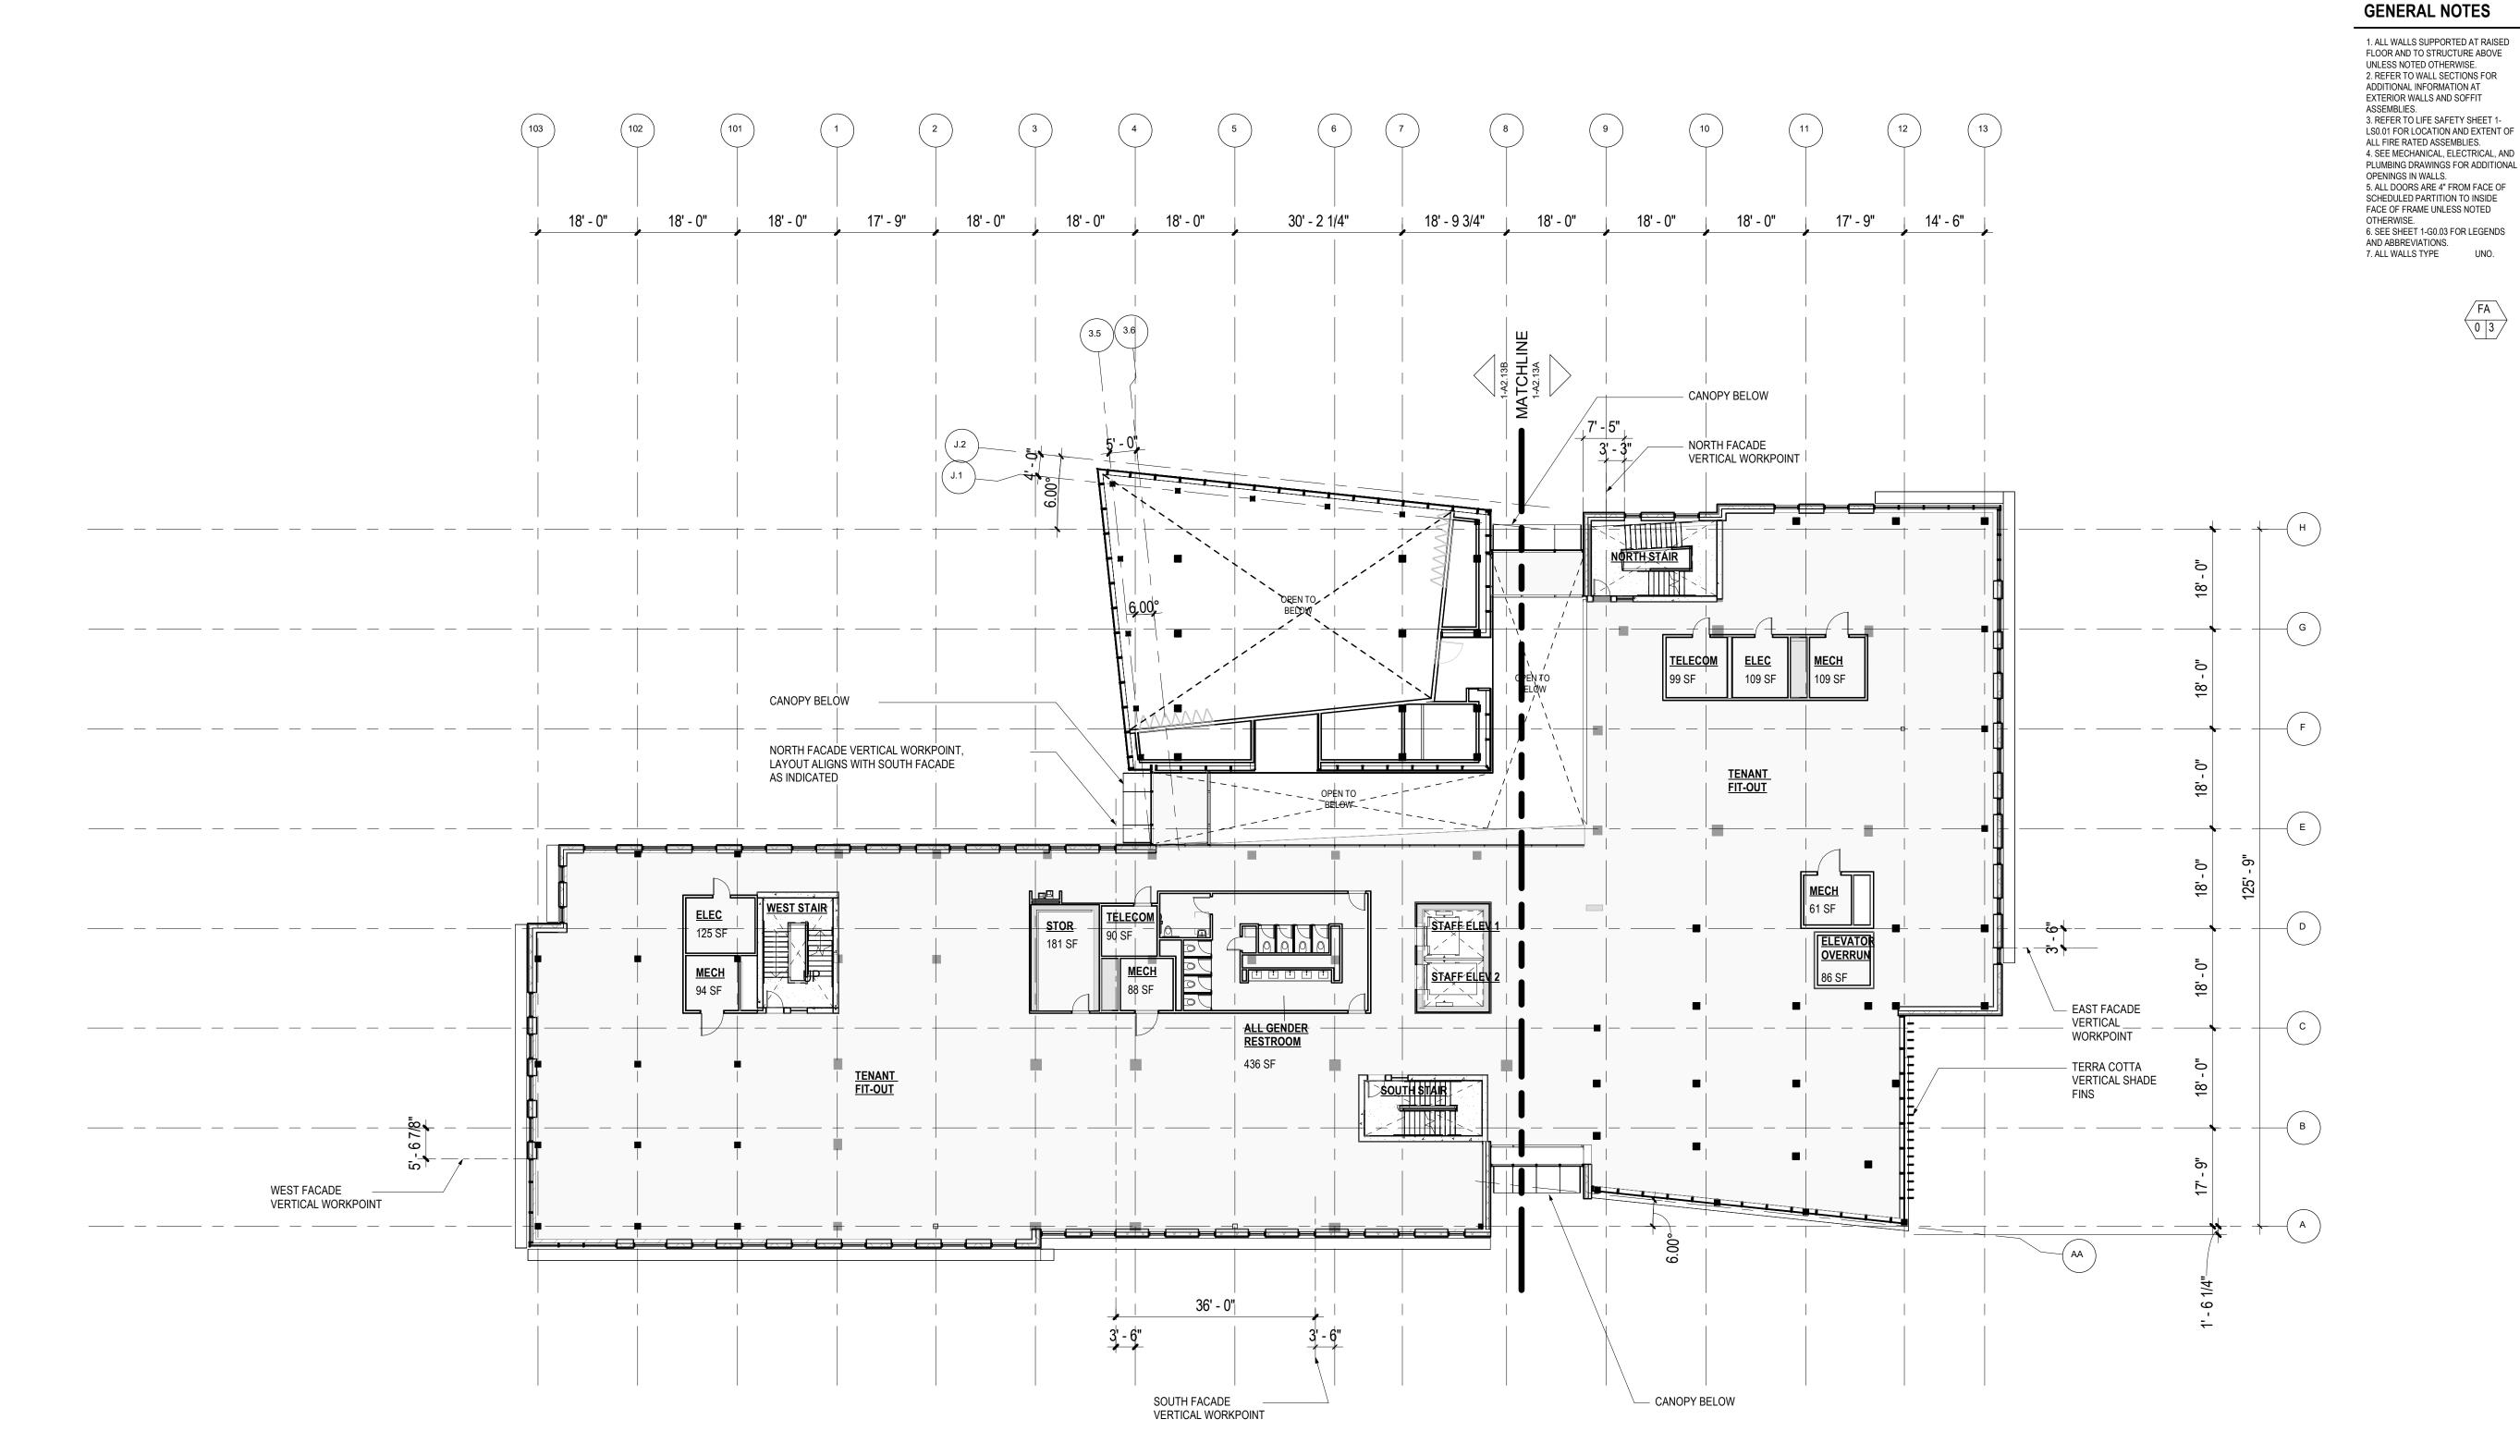


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**PLAN, FLOOR - LEVEL 2 RAISED, SHELL & CORE** 1-A2.13 1/16" = 1'-0"

### PLUMBING DRAWINGS FOR ADDITIONAL OPENINGS IN WALLS.

5. ALL DOORS ARE 4" FROM FACE OF SCHEDULED PARTITION TO INSIDE FACE OF FRAME UNLESS NOTED 6. SEE SHEET 1-G0.03 FOR LEGENDS AND ABBREVIATIONS. 7. ALL WALLS TYPE UNO.





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ENTITLEMENTS STUDIO ARCHITECTURE 2995 55TH STREET, #17983 BOULDER, CO 80301 T 720 491 1167 LANDSCAPE

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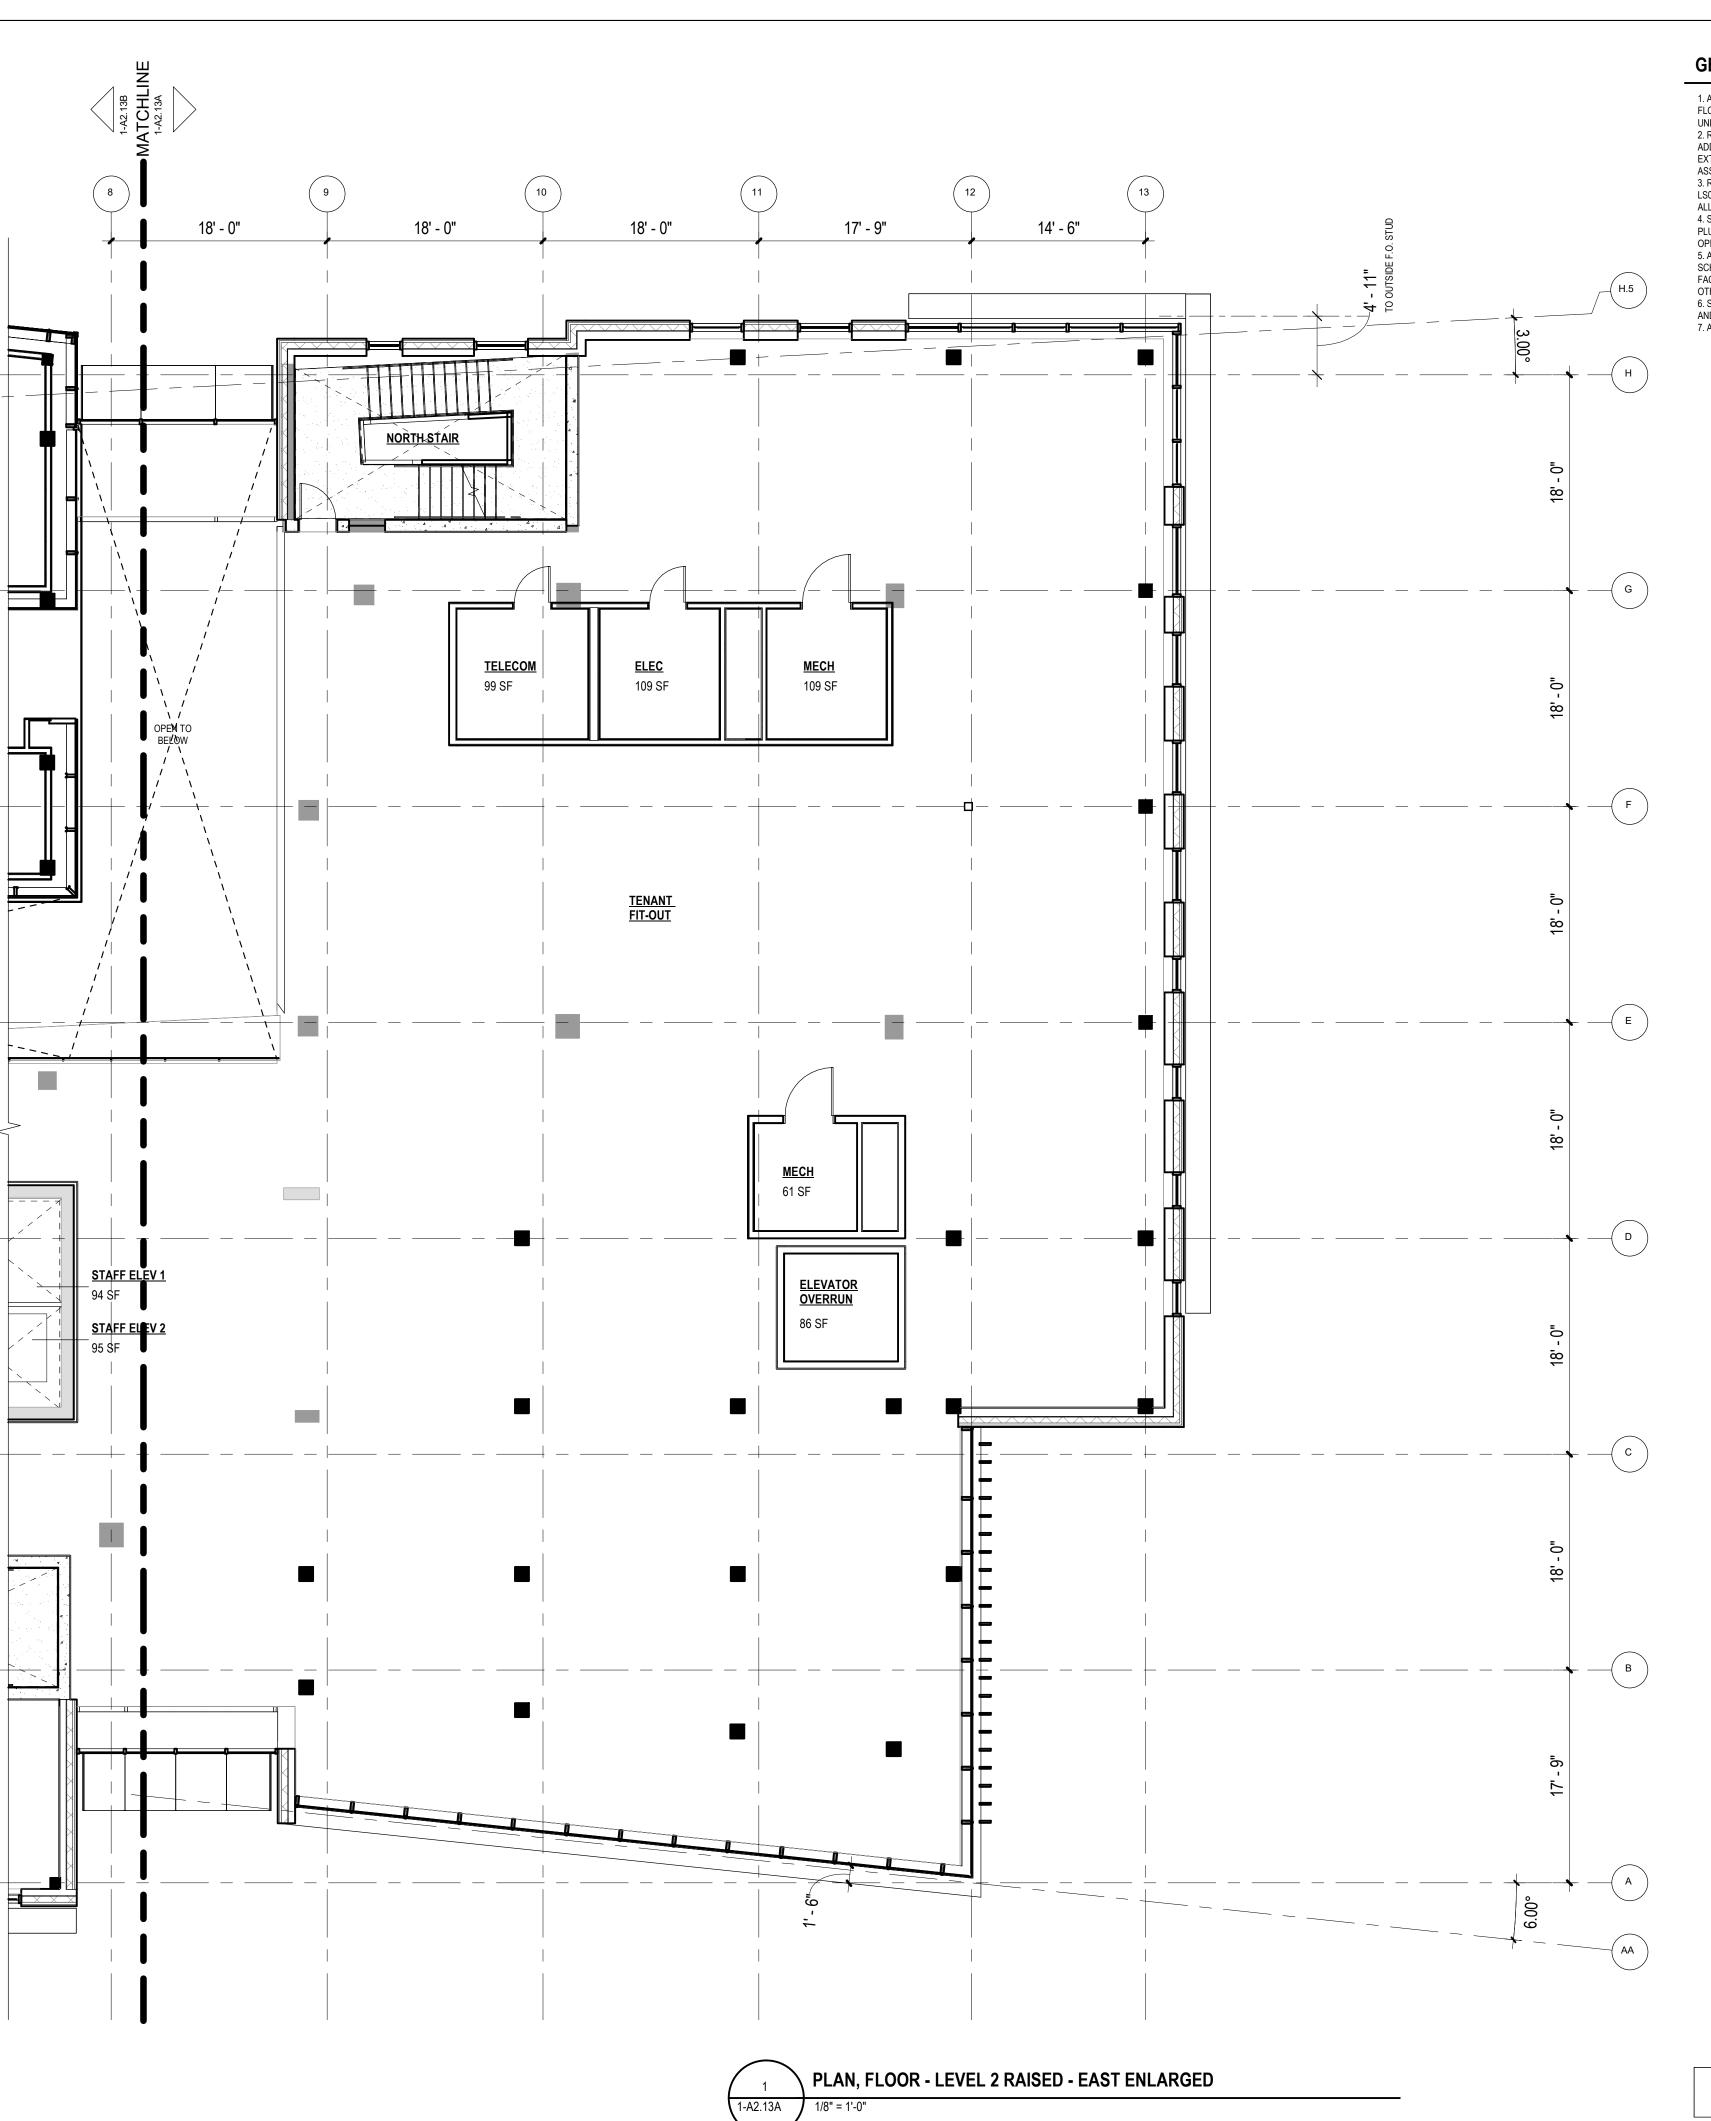
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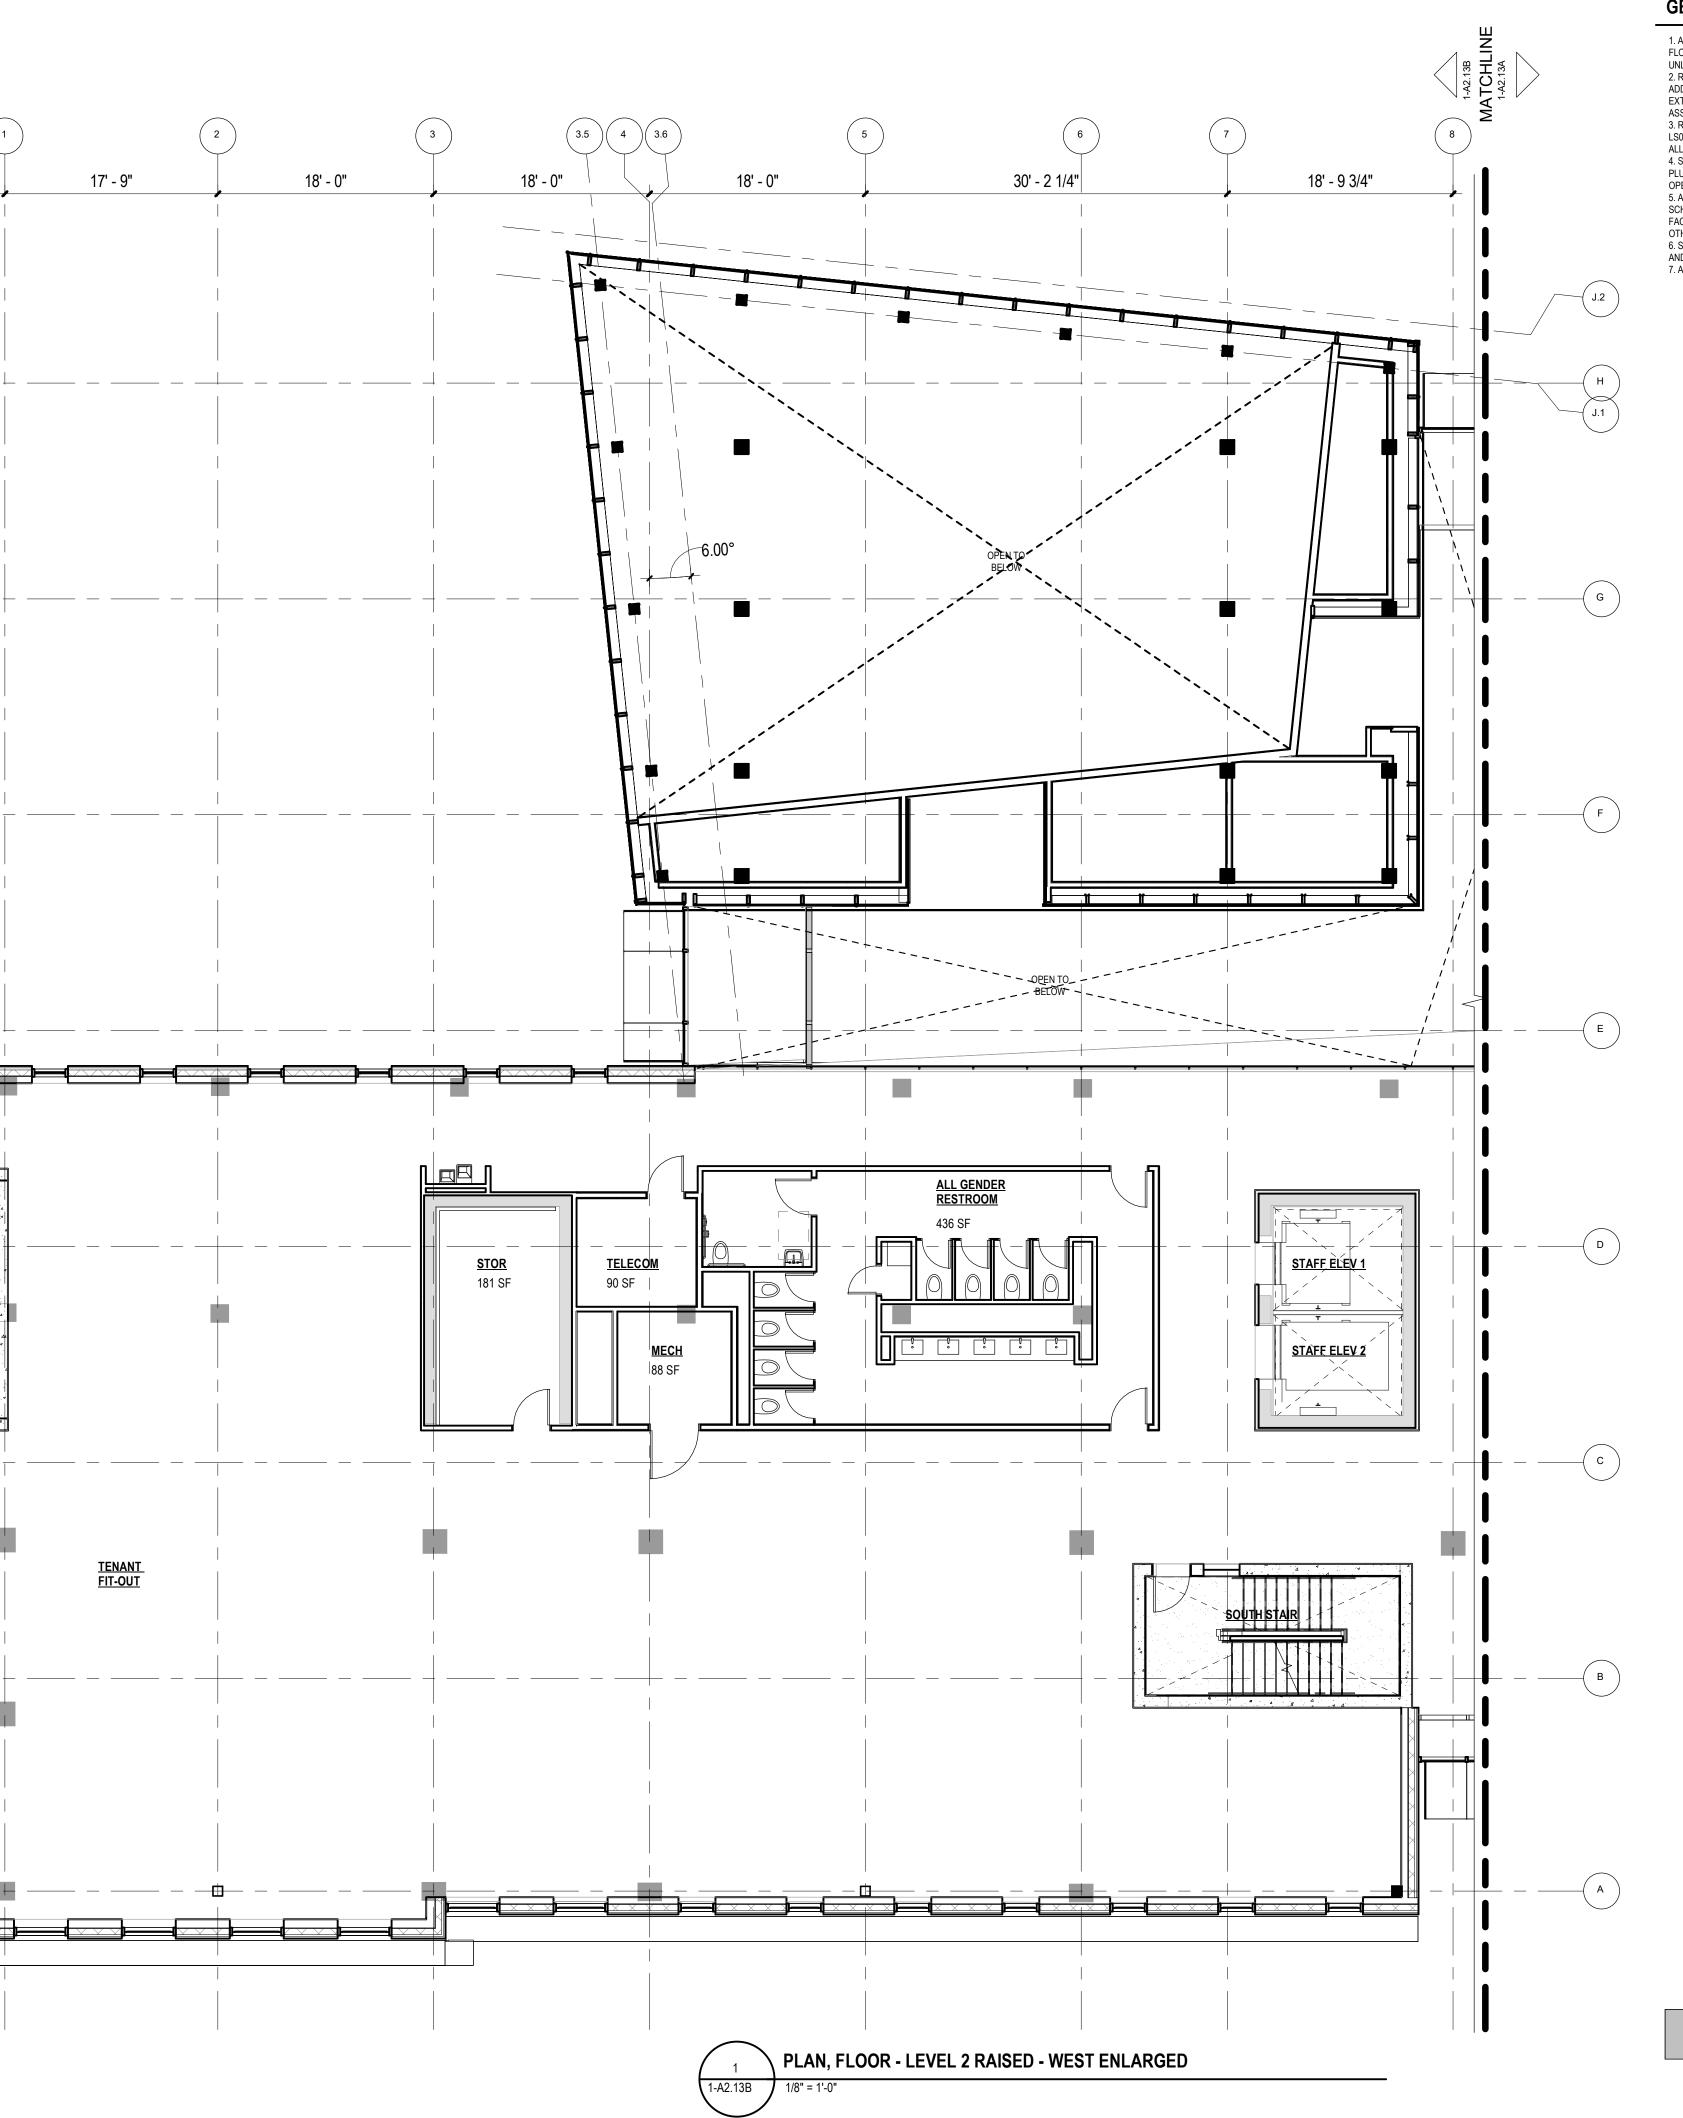
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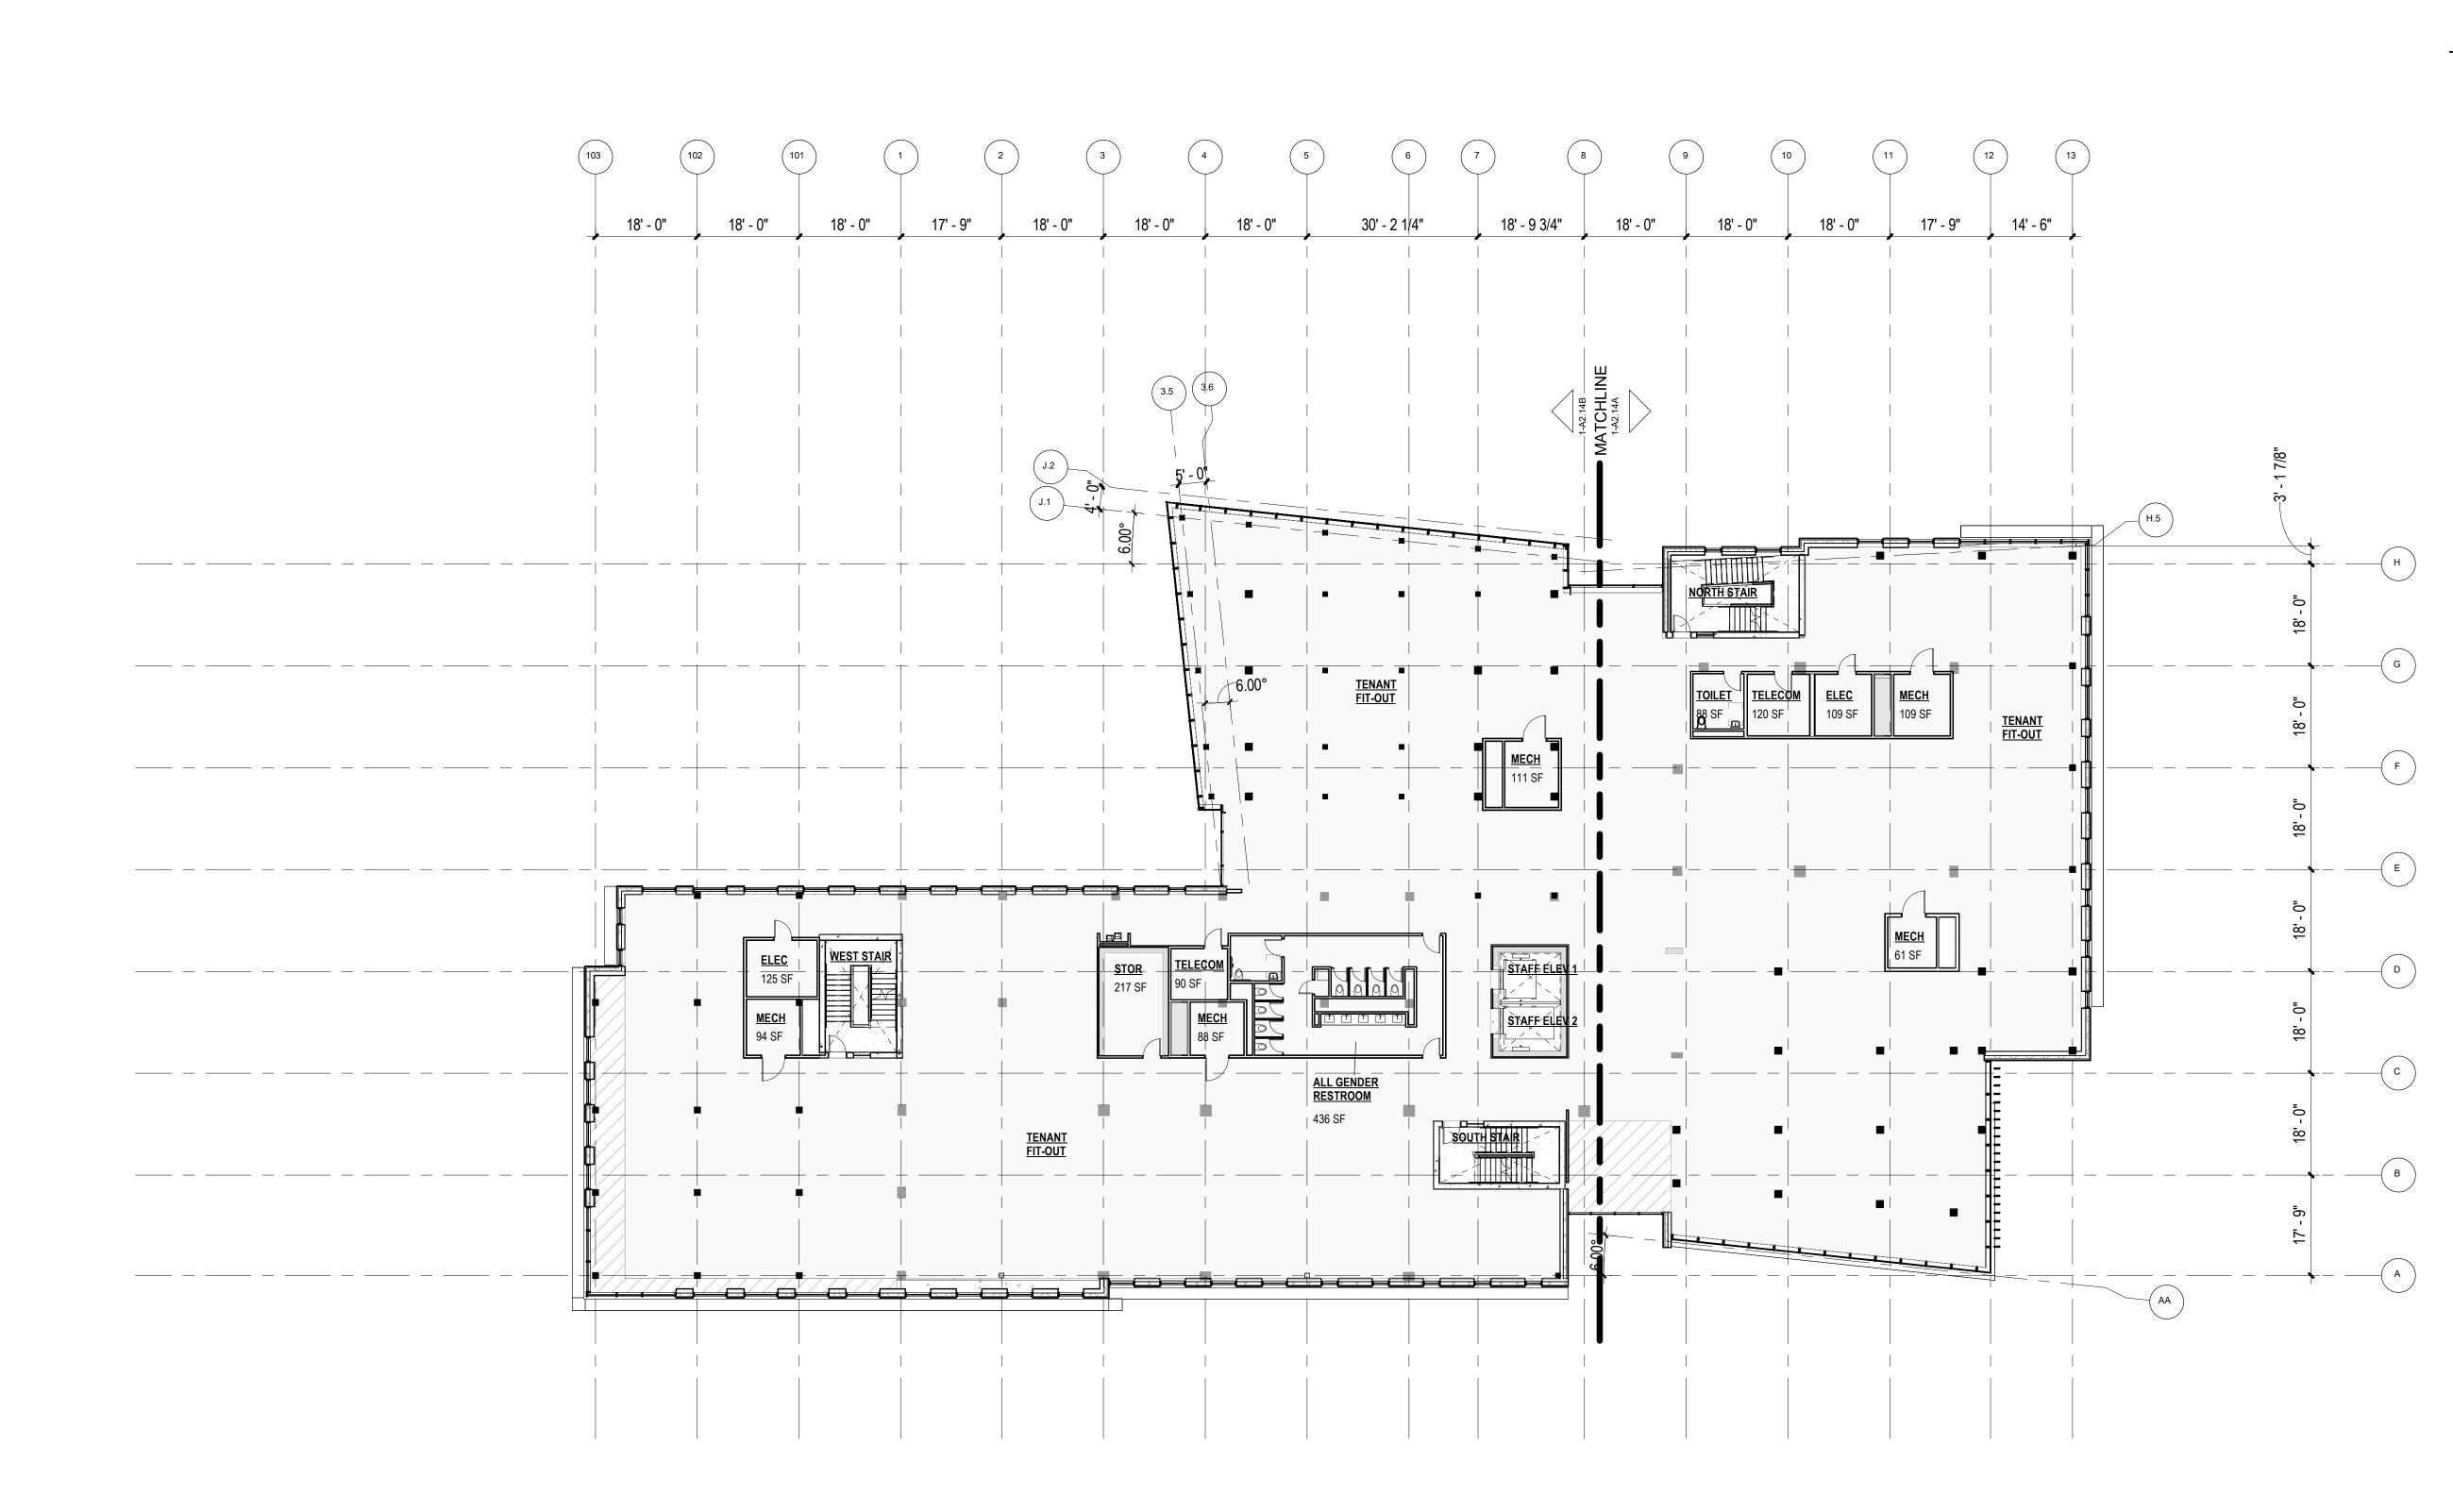
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 PLAN, FLOOR - LEVEL 3 RAISED, SHELL & CORE

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 1/16" = 1'-0"

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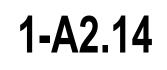
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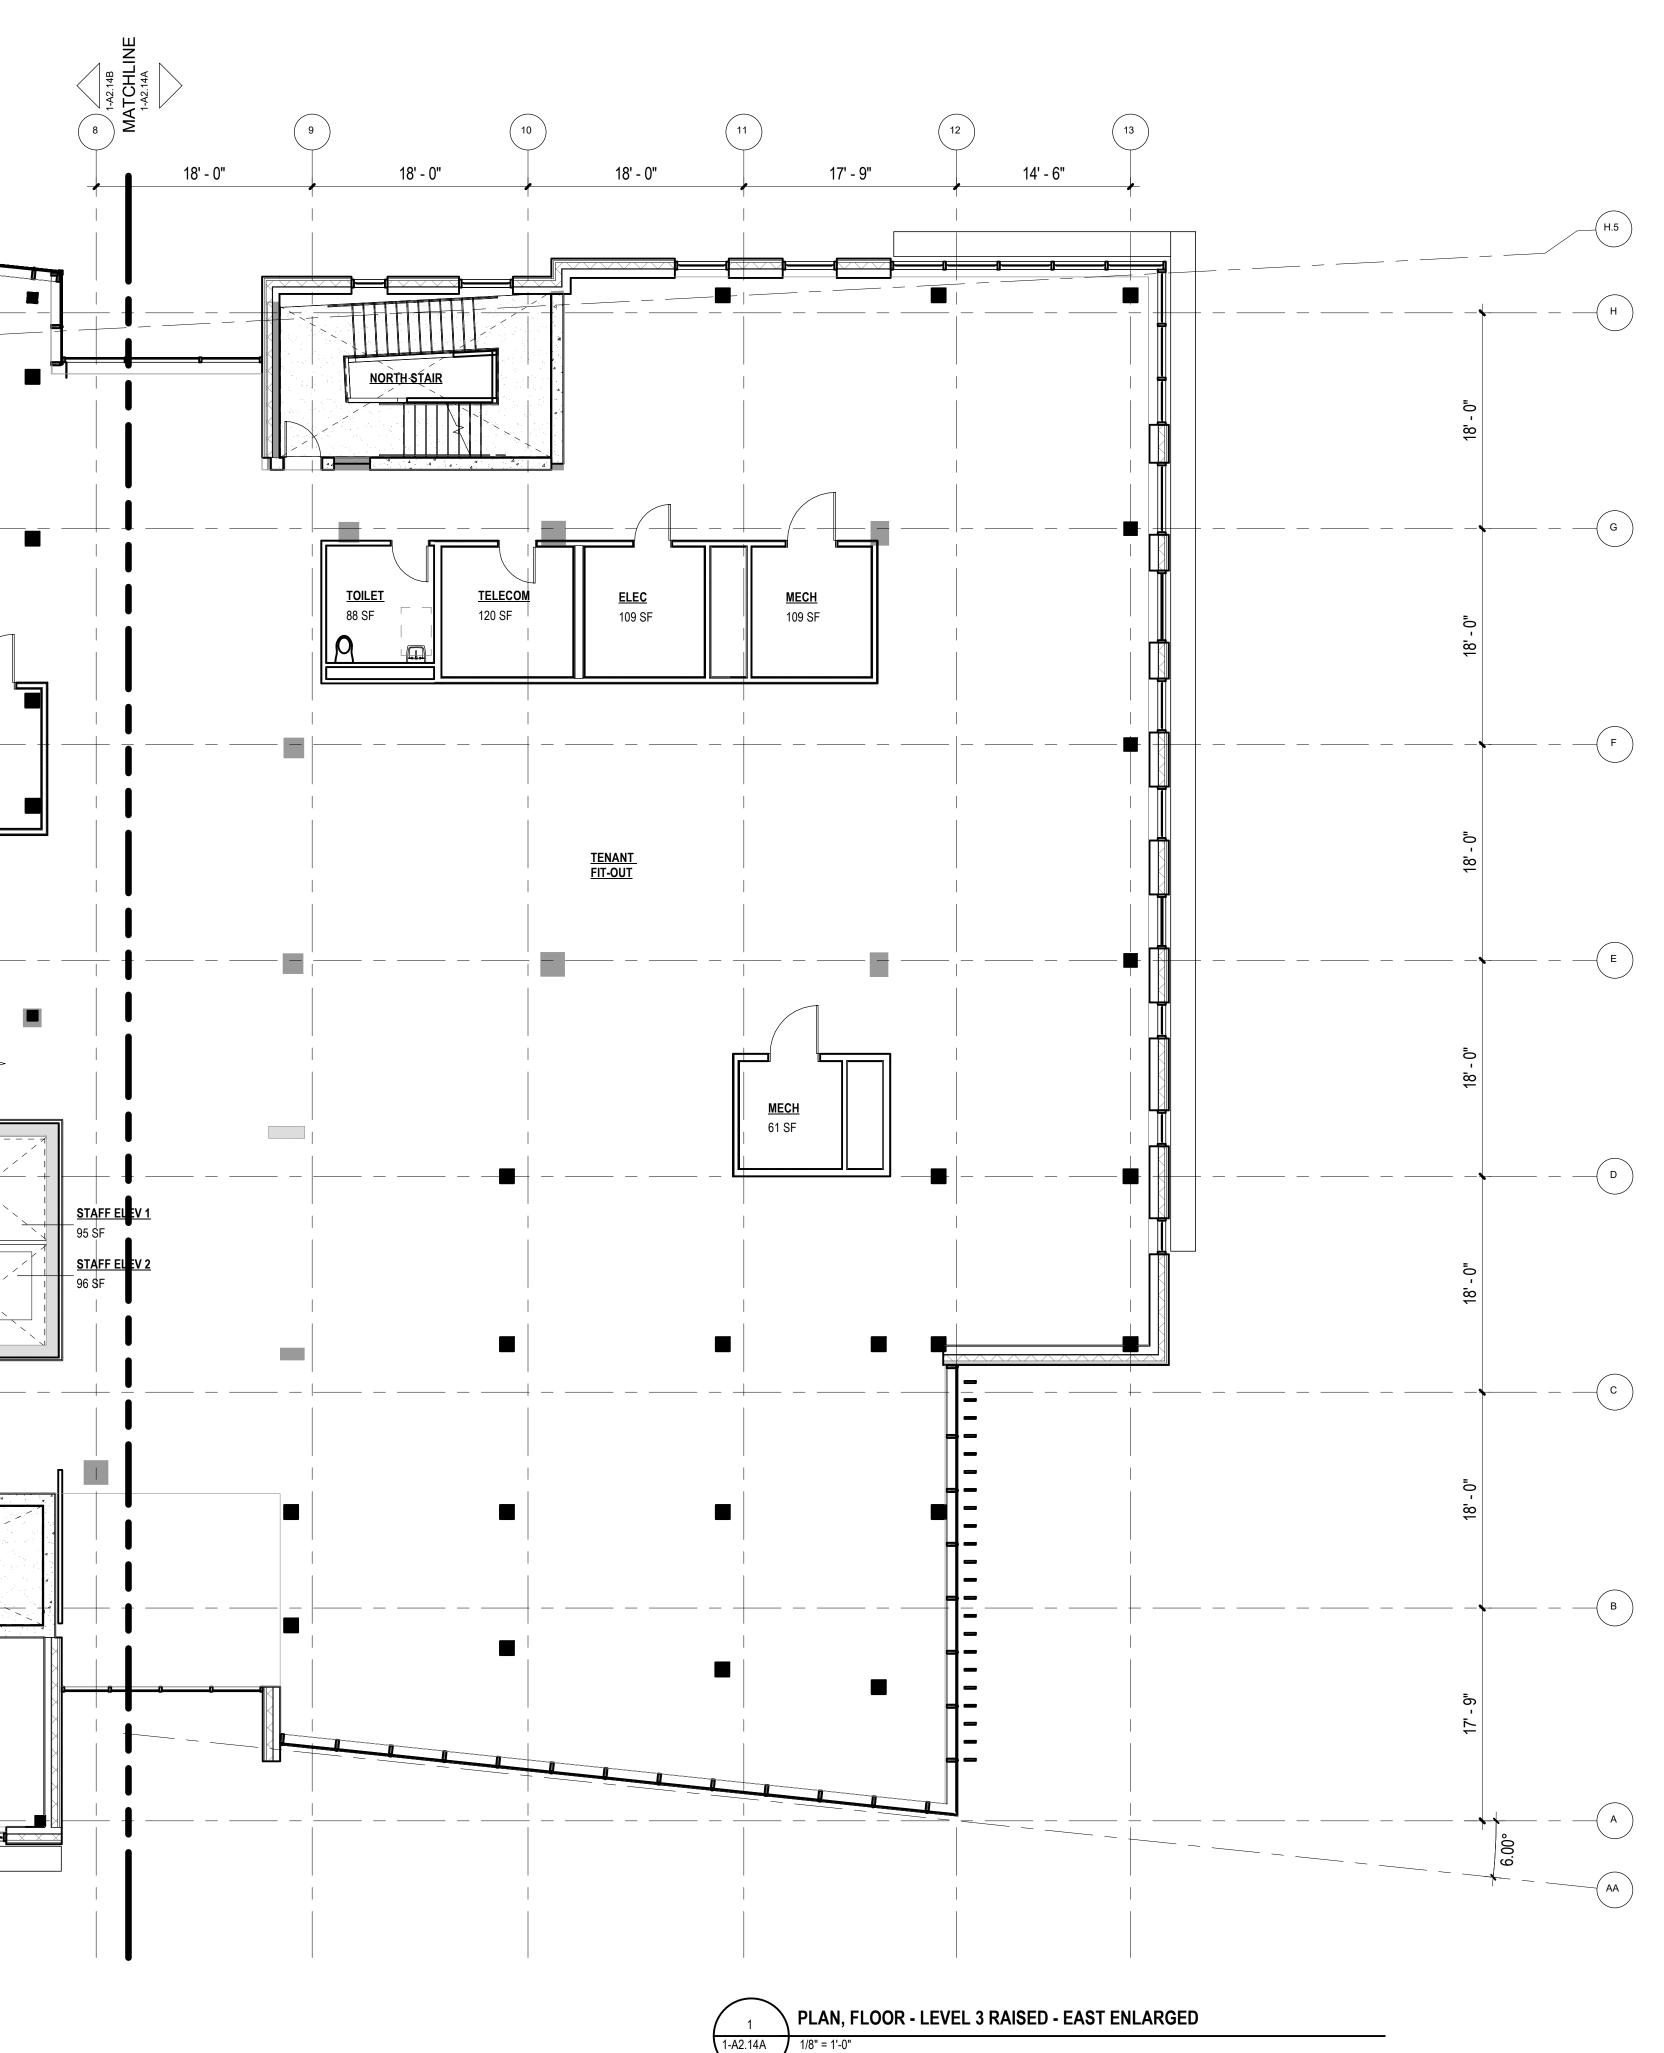
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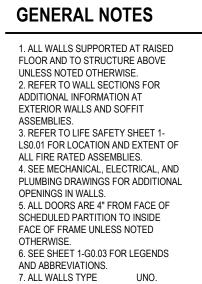
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Full Design Team Roster on Sheet 1-G0.01 Client and Project Information



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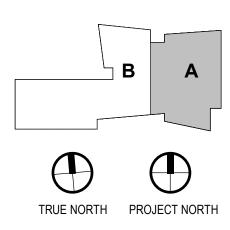
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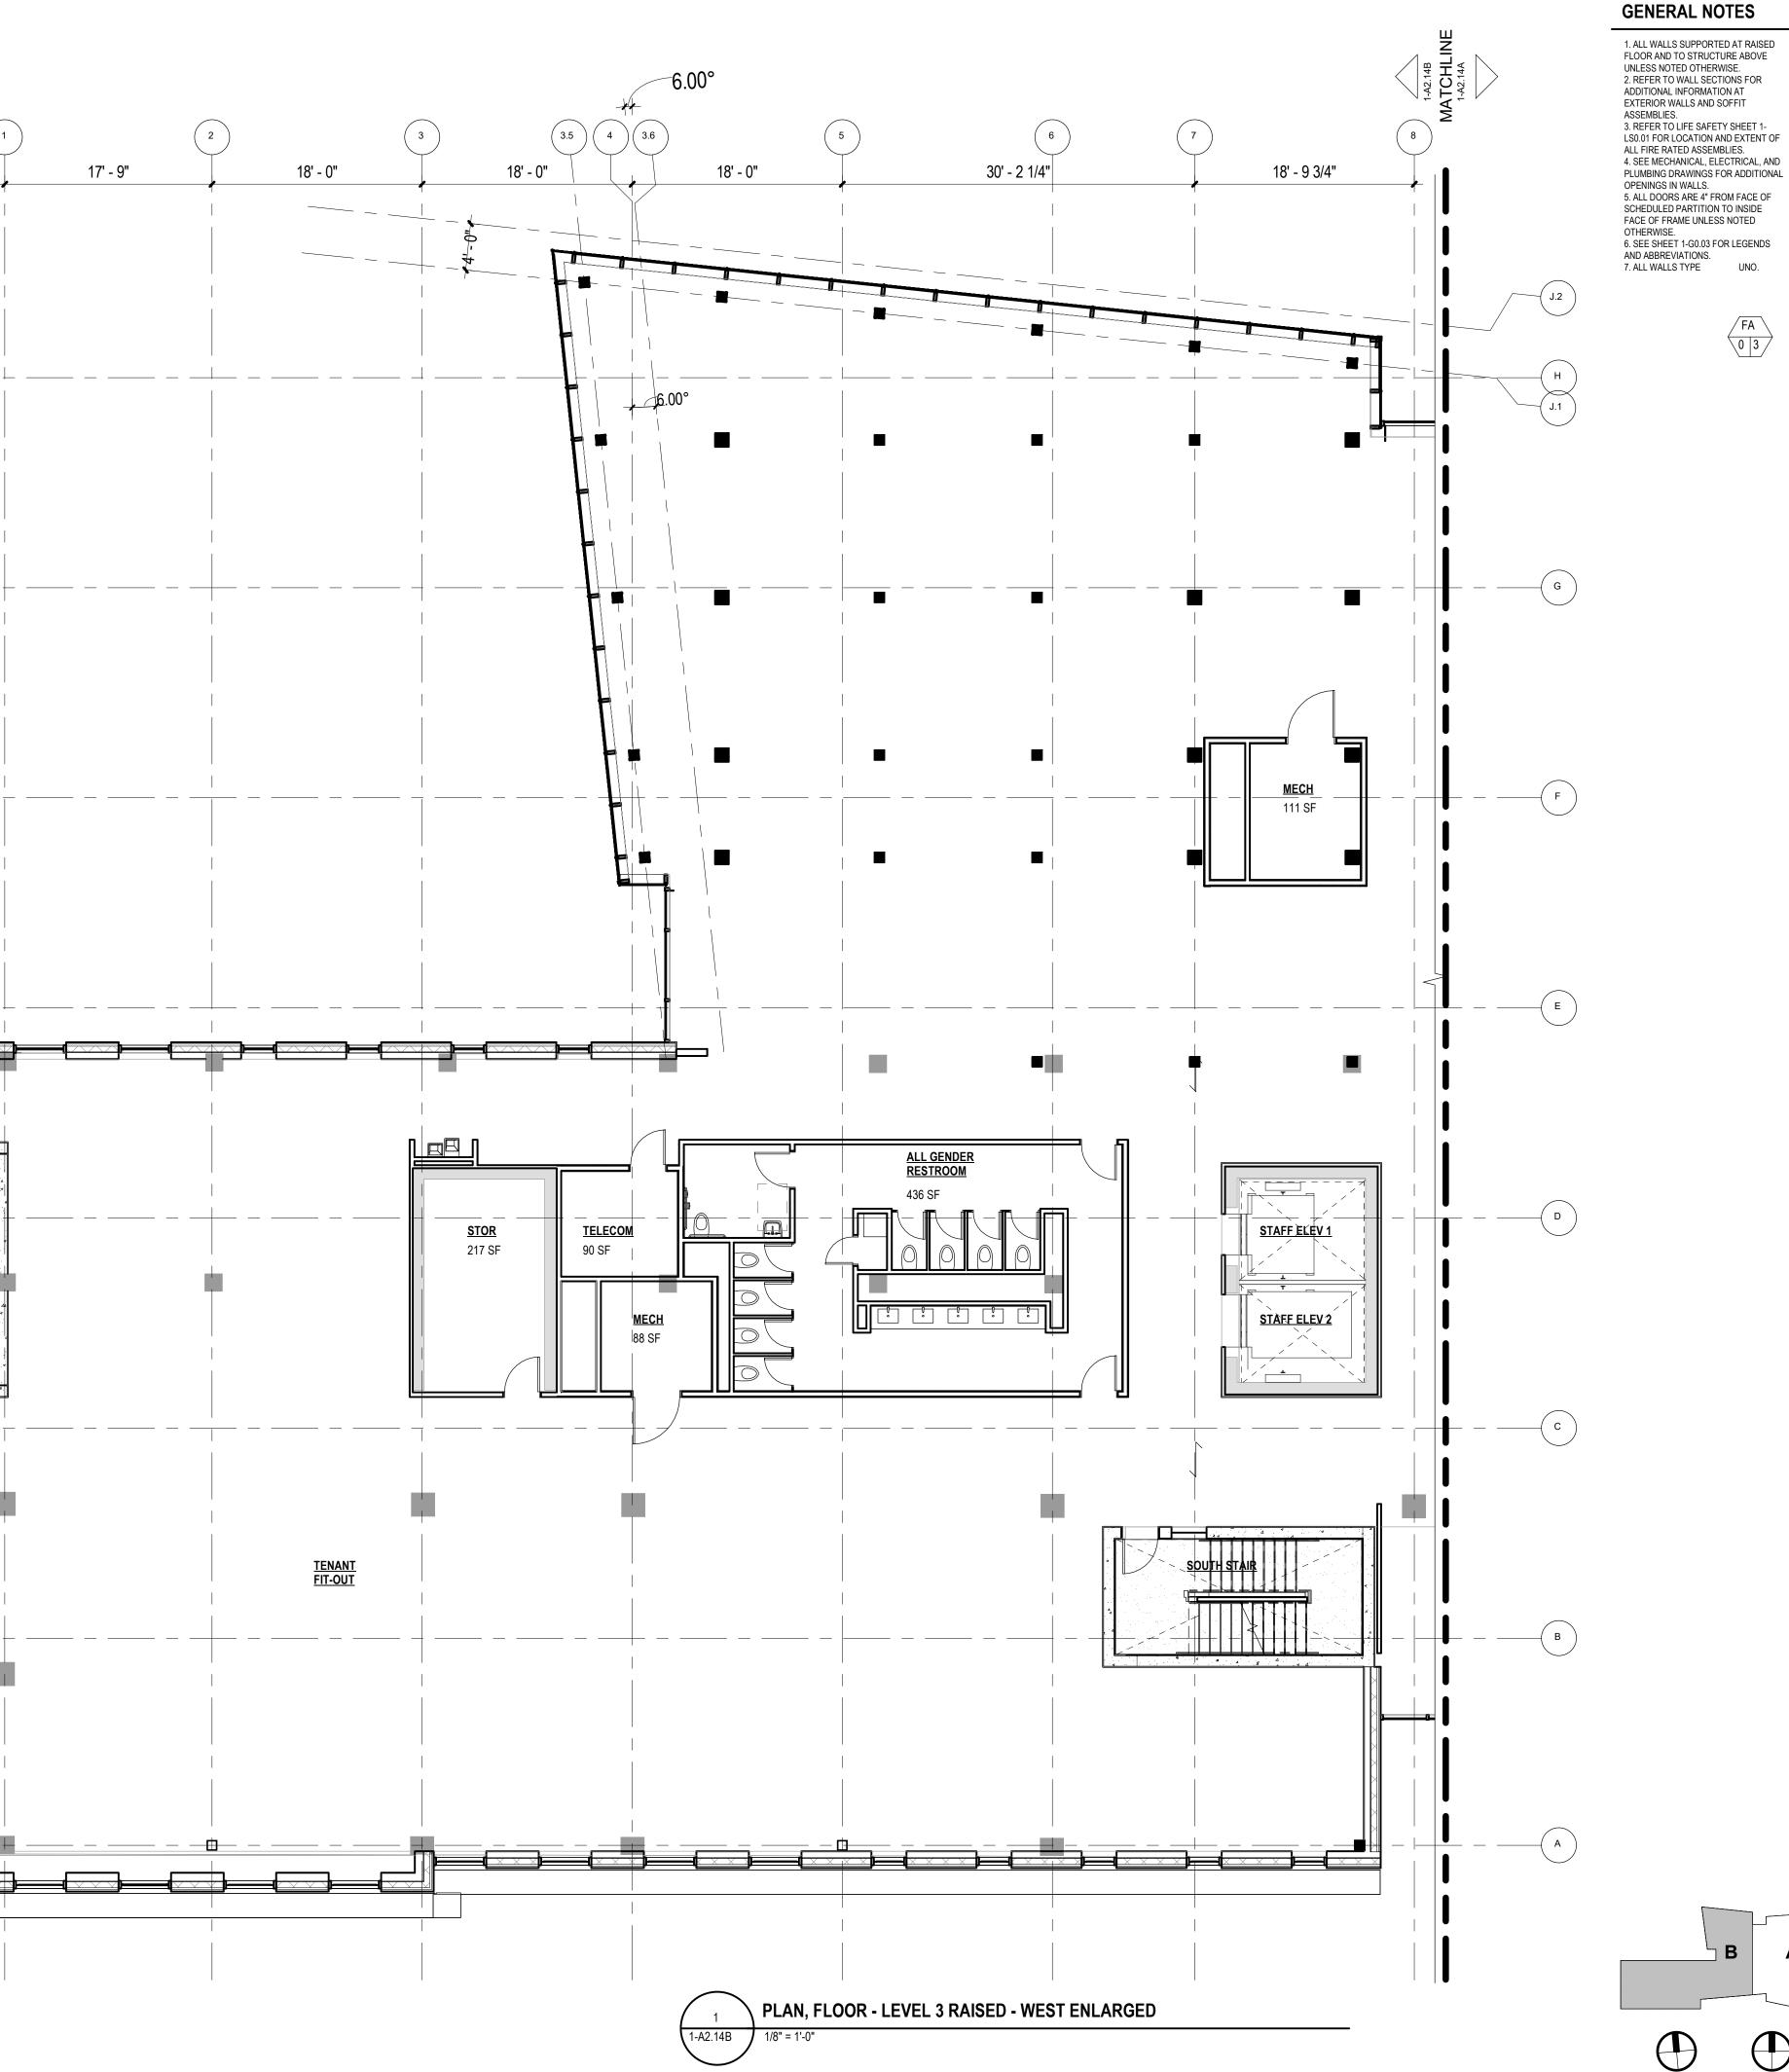
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### ZIMMER GUNSUL FRASCA ARCHITECTS LLP

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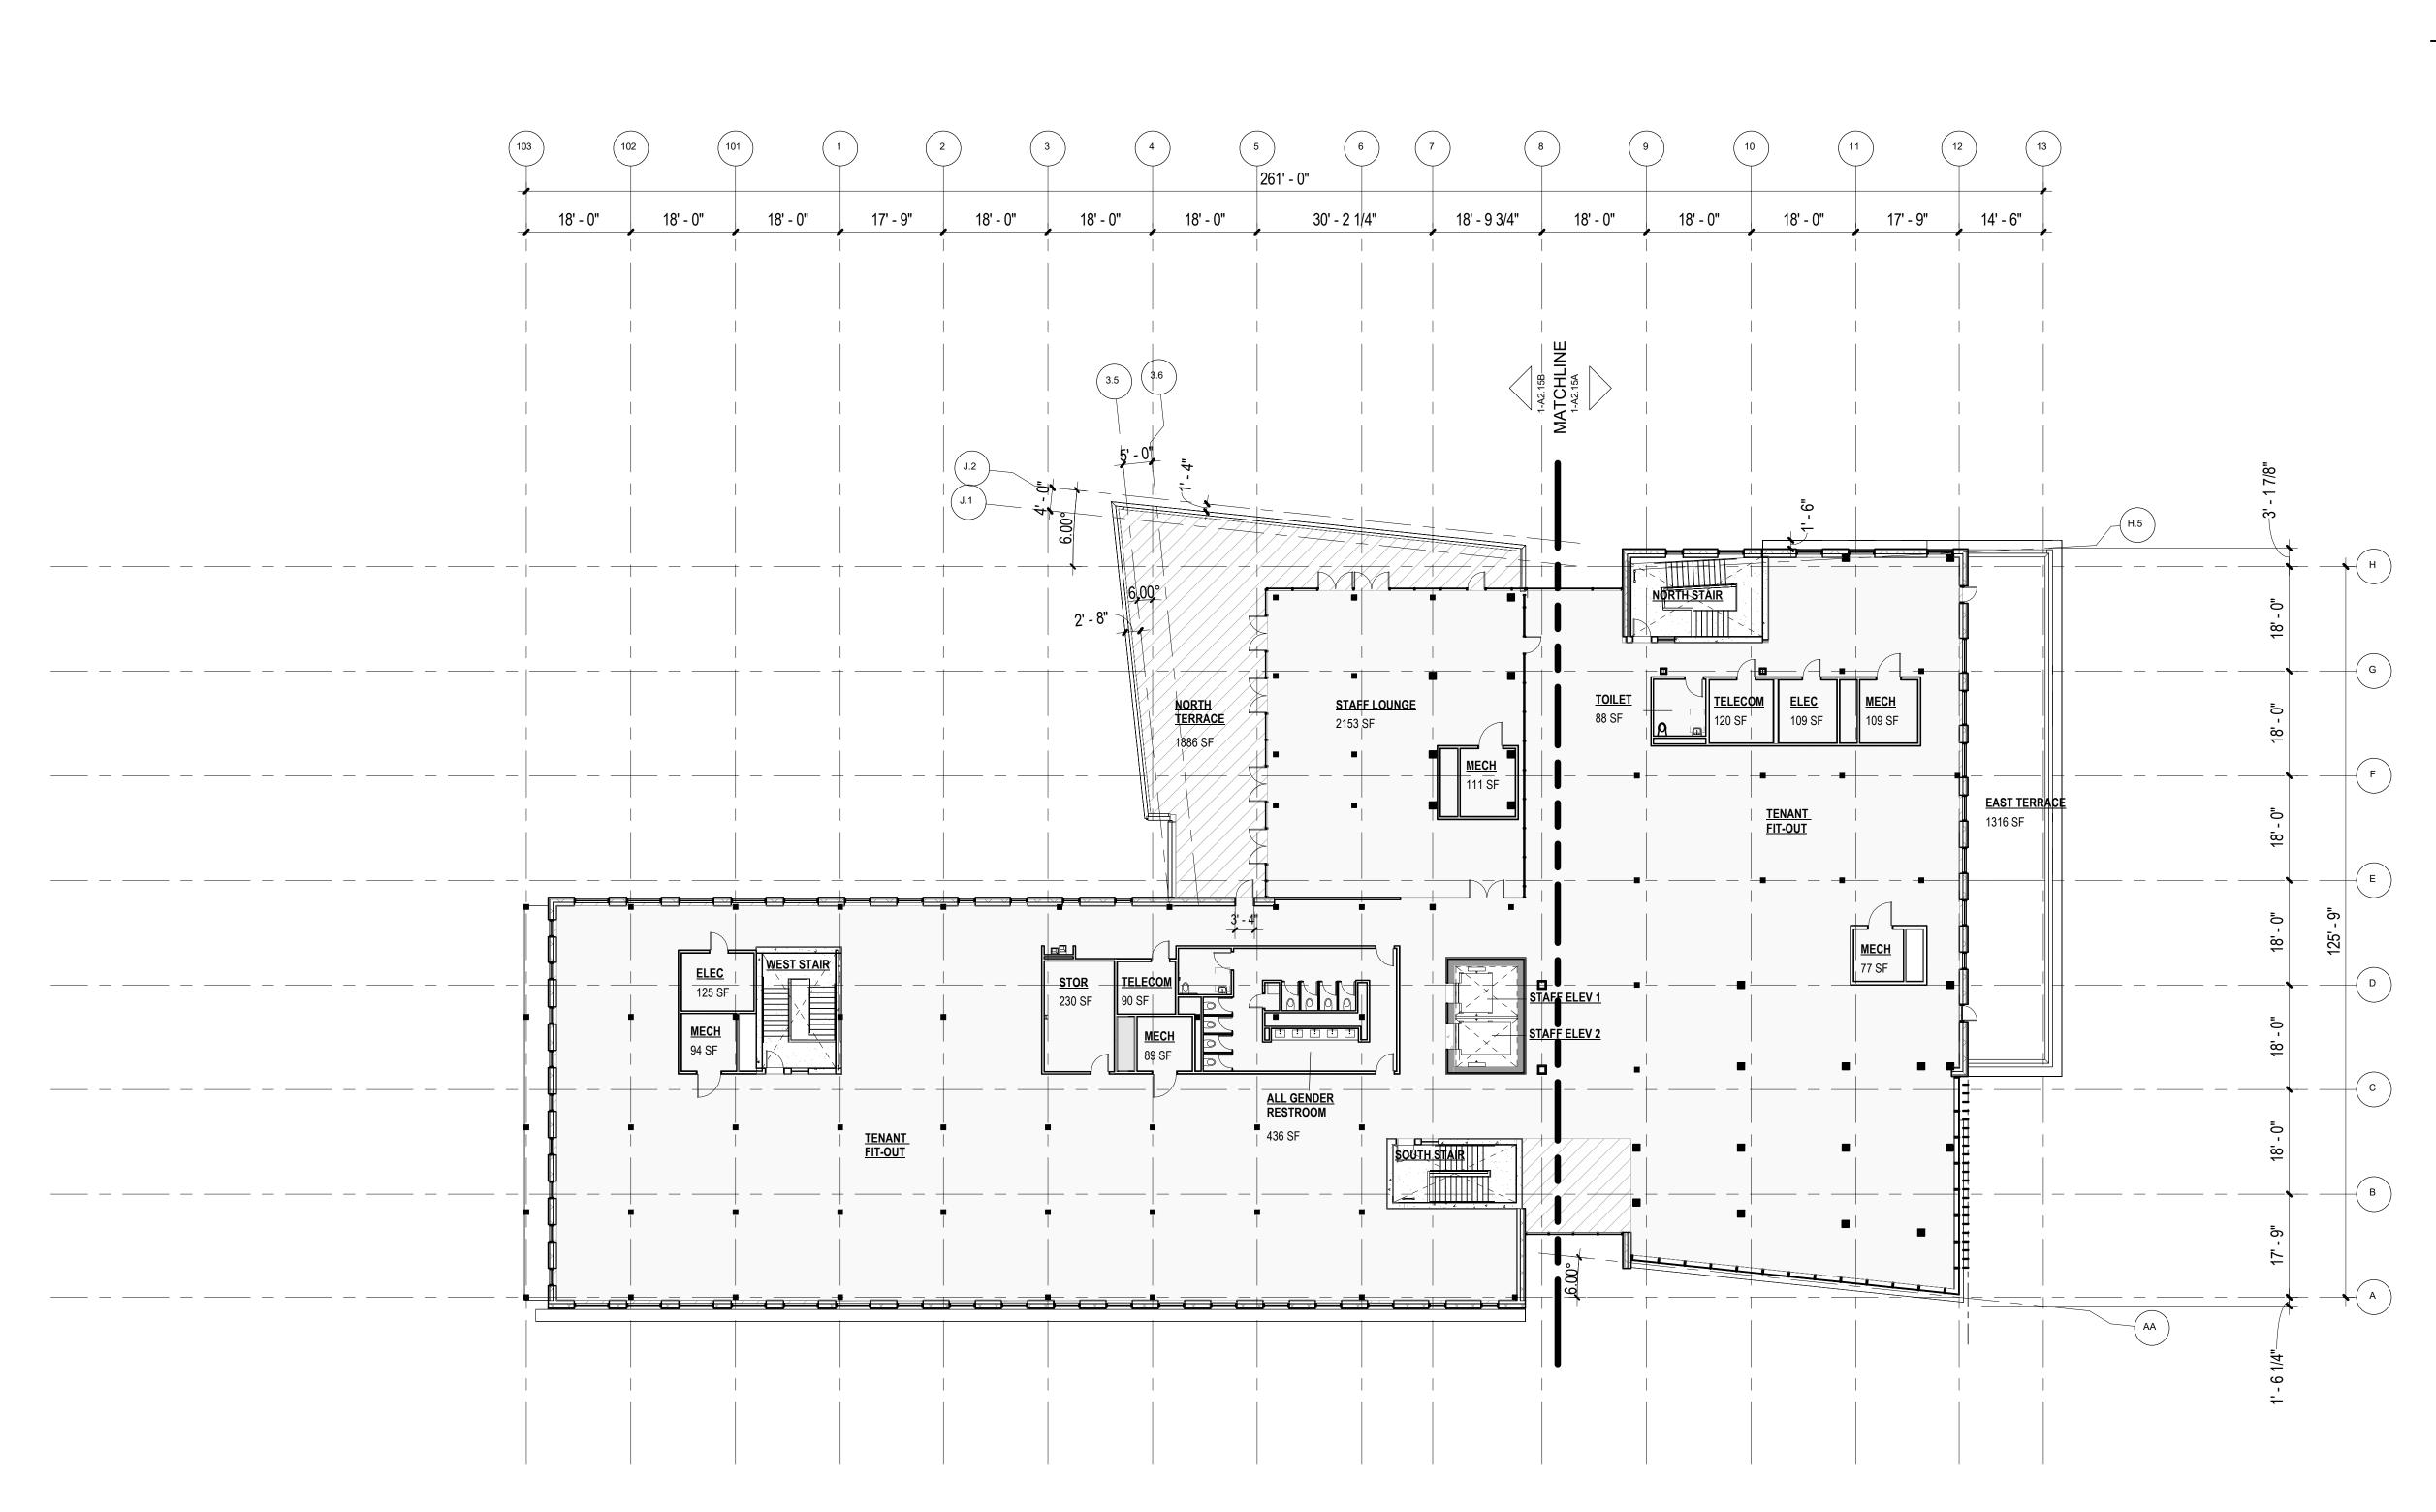
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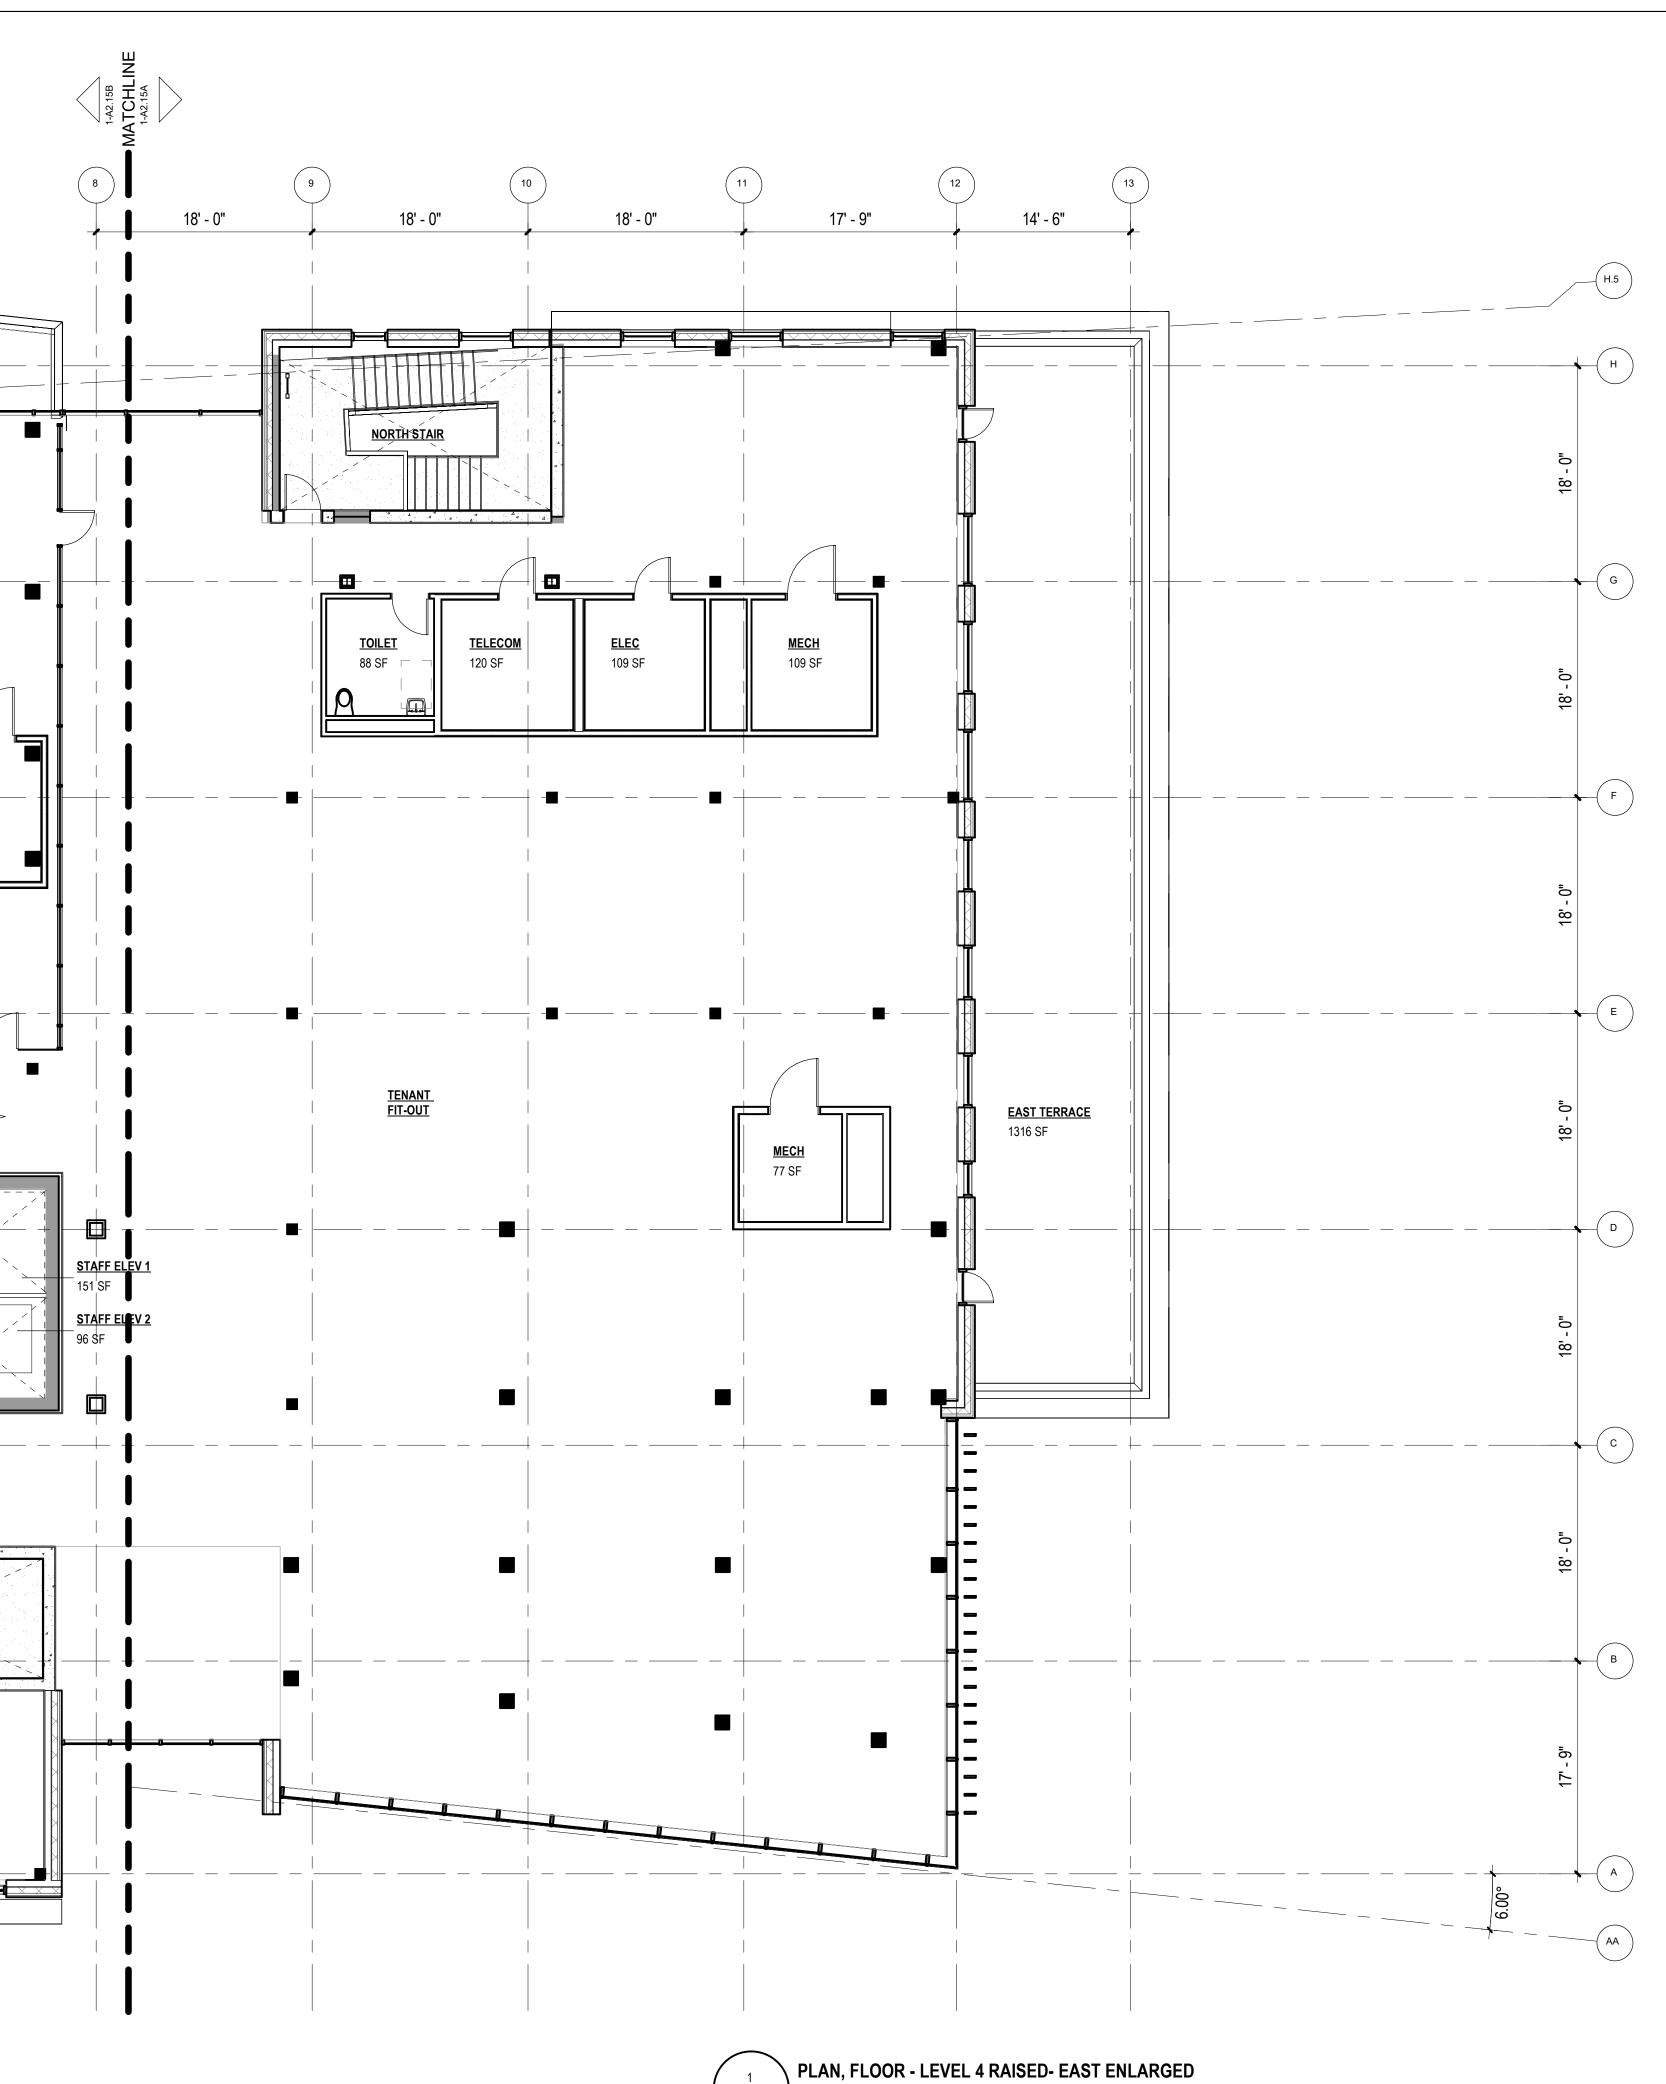


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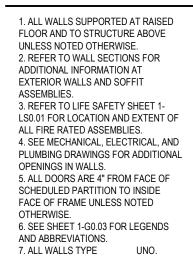


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### GENERAL NOTES







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Boulder Western City Campus - Volume 1-Pavilion Office Building

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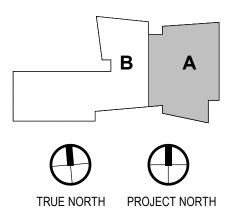
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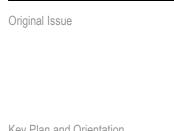
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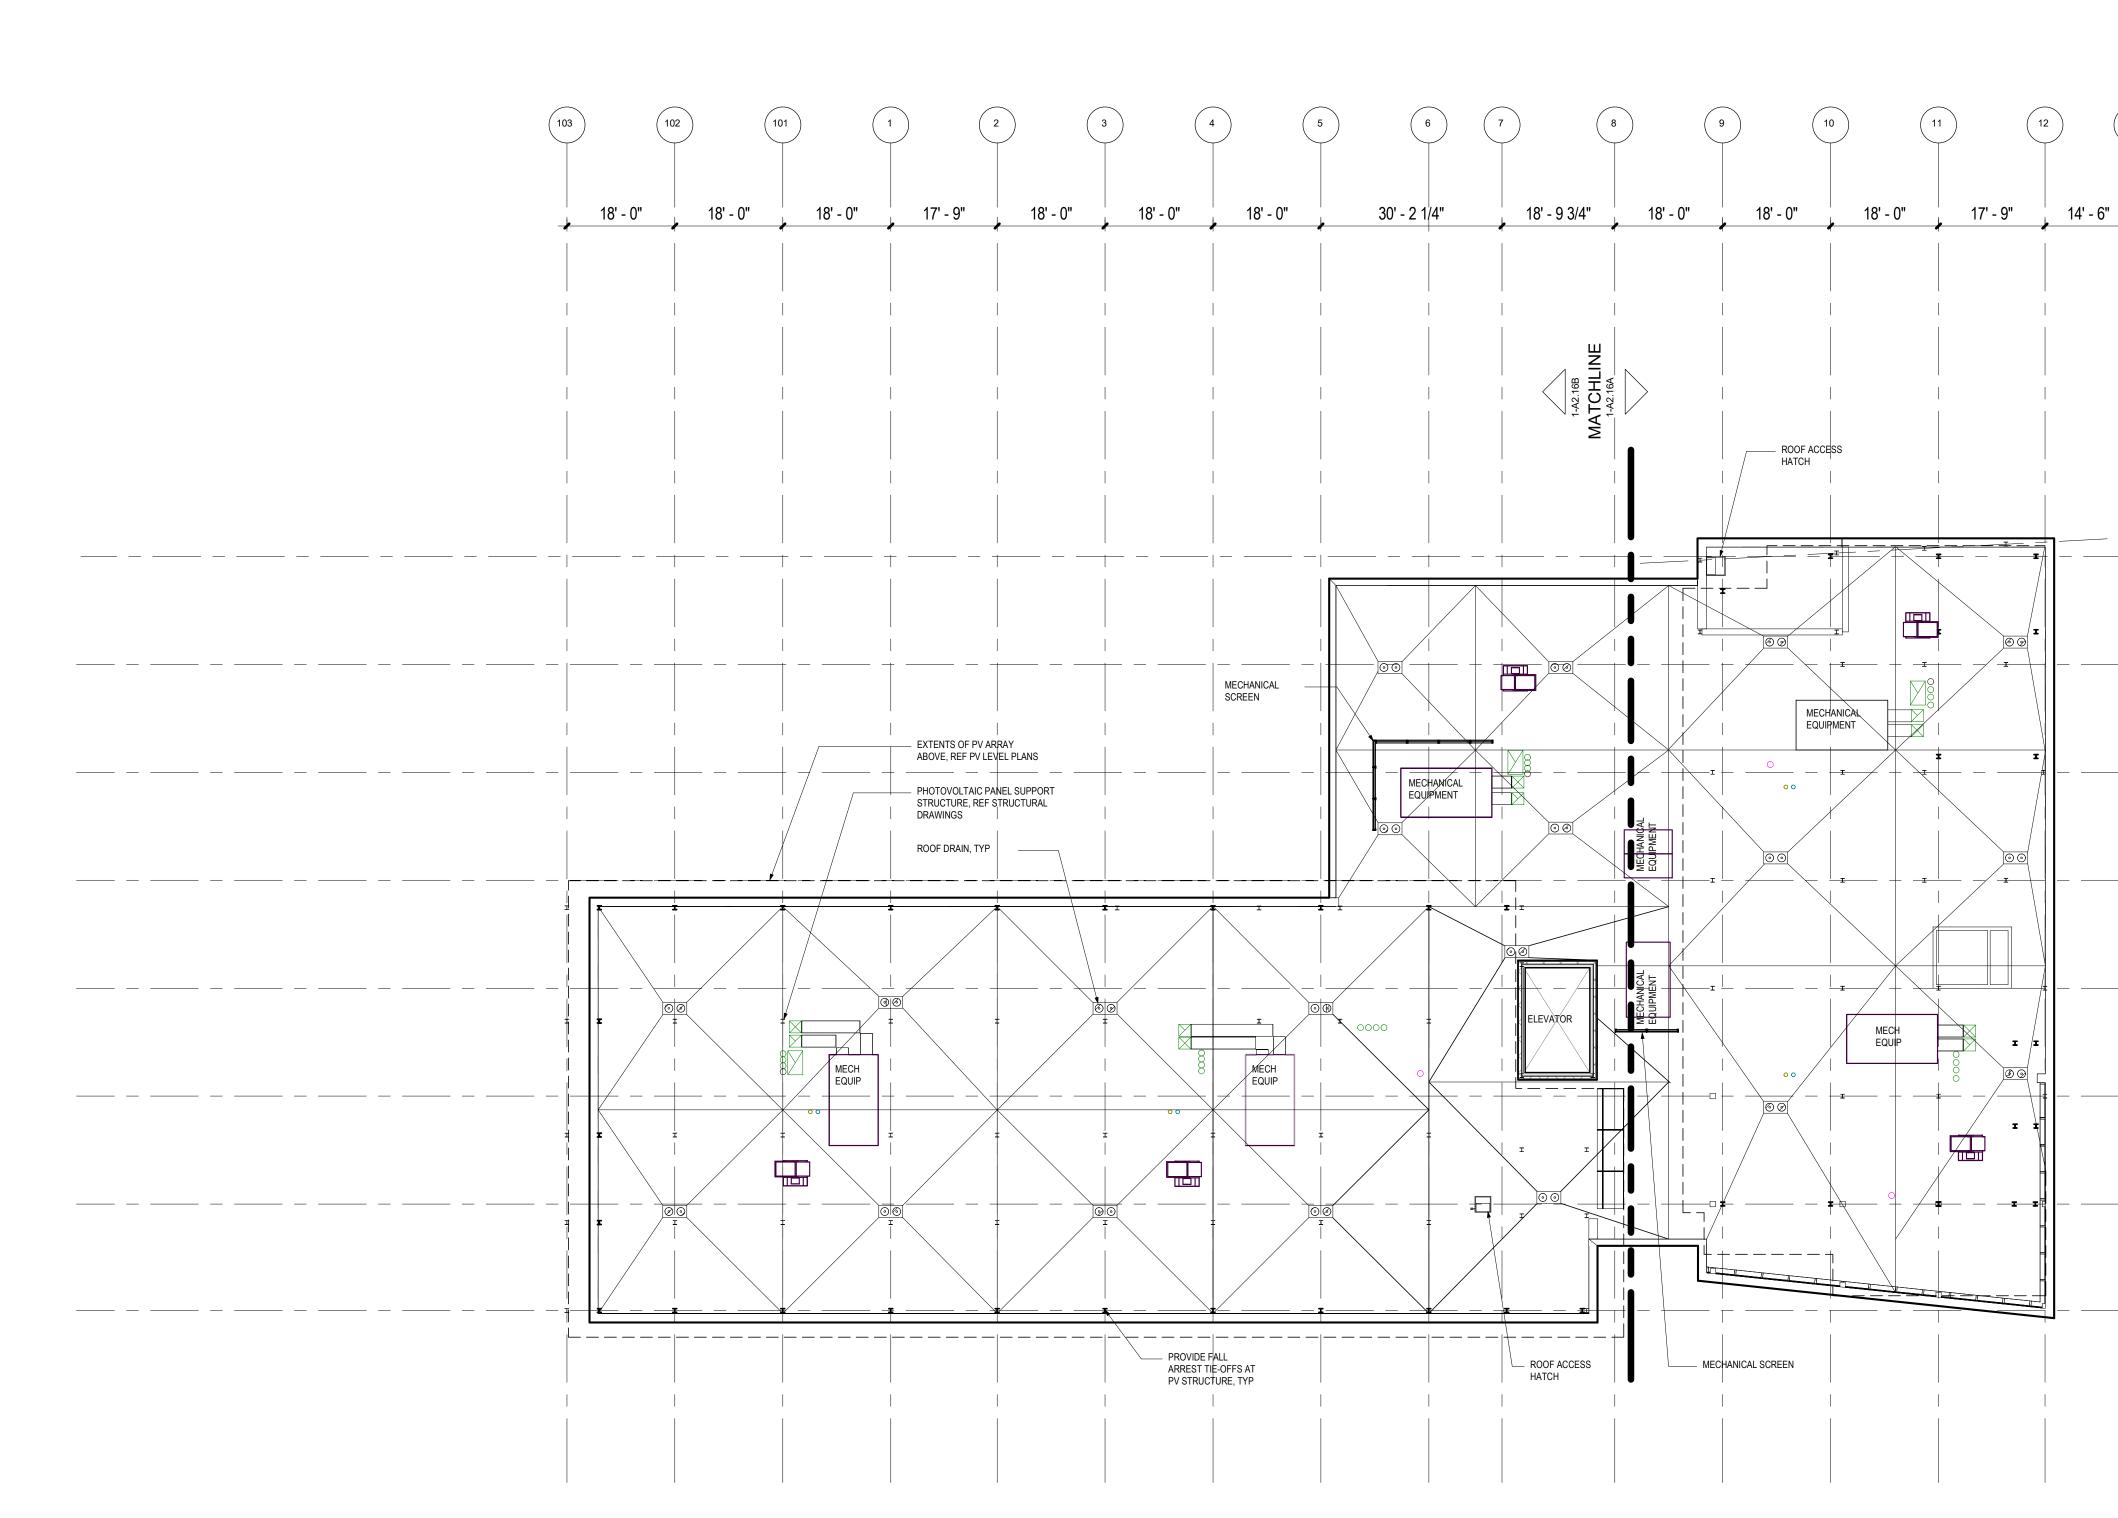
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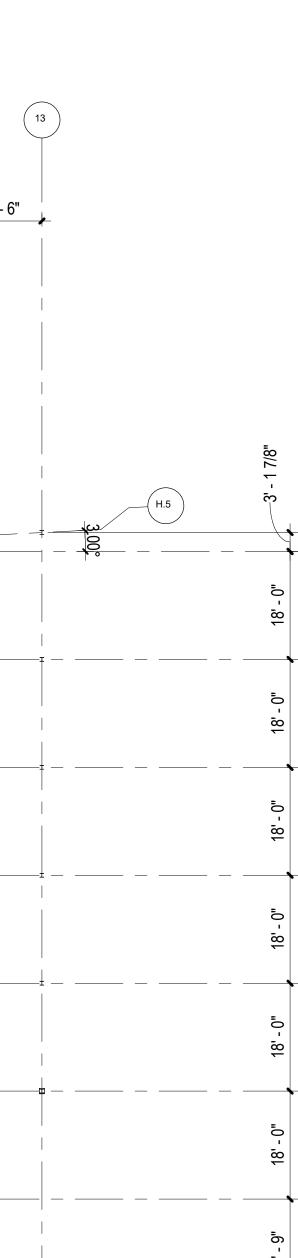
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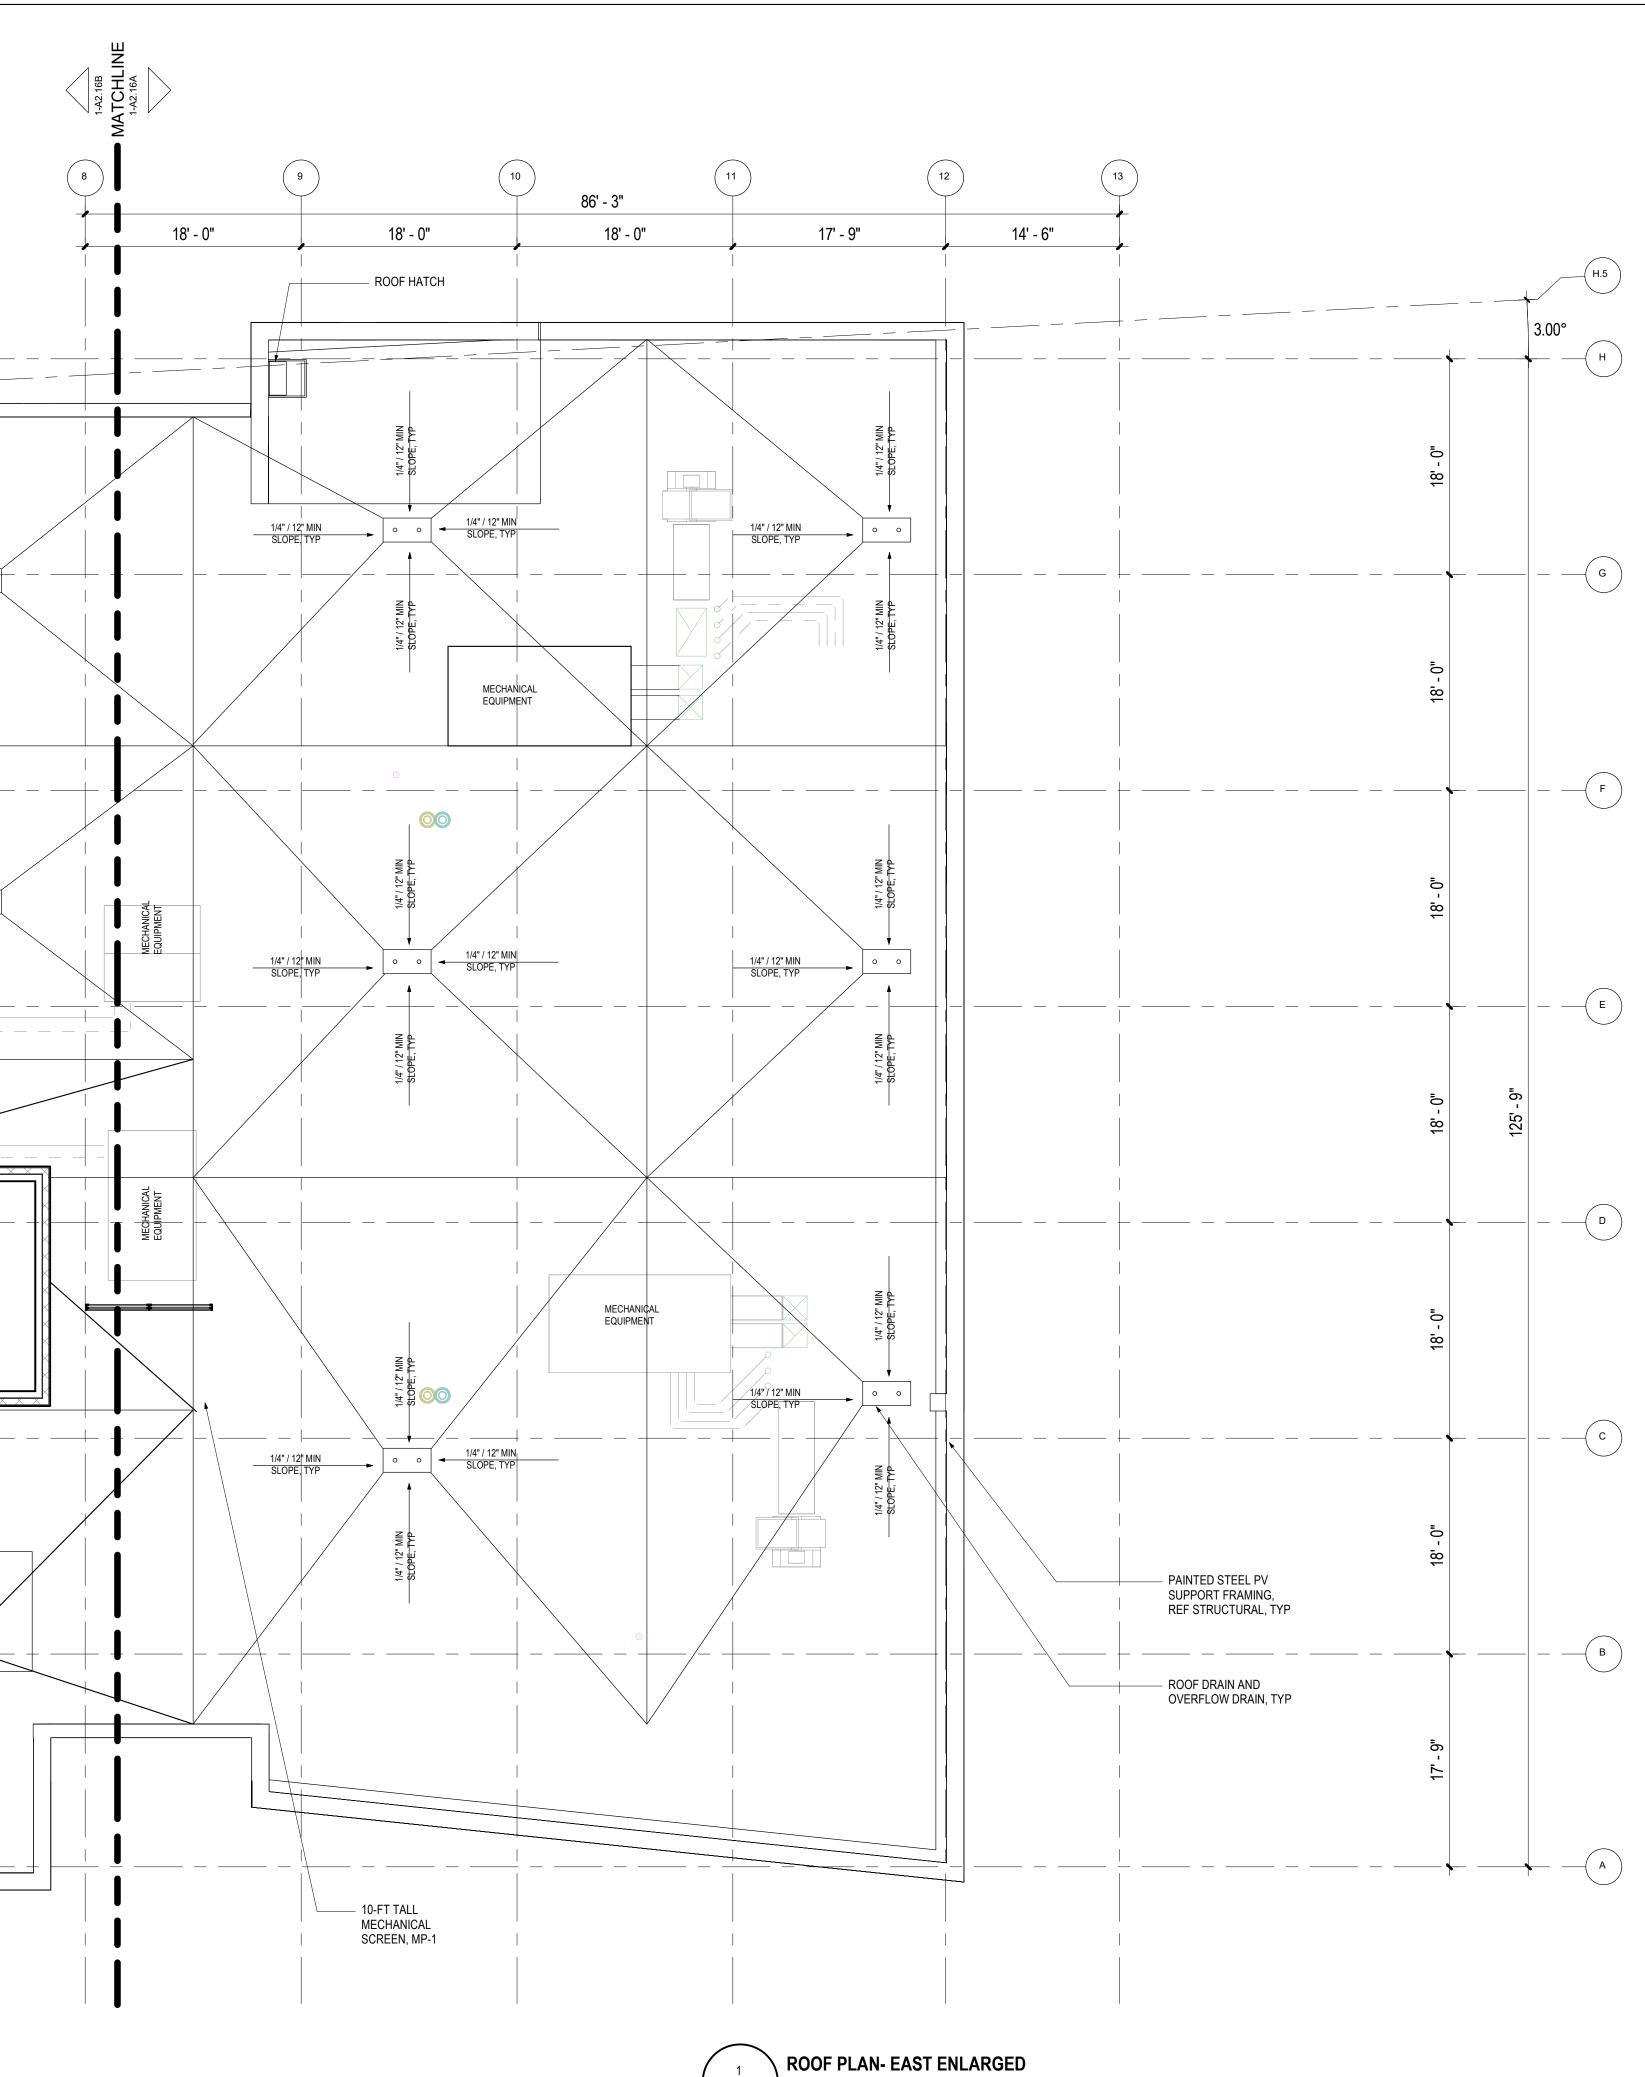
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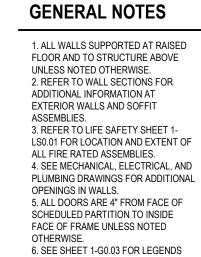


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STRUCTURAL ANTHEM STRUCTURAL ENGINEERS FLATIRON OFFICE PARK 2213 CENTRAL AVENUE BOULDER, CO 80301 T 303 848 8497

MEP BRANCH PATTERN 3344 WALNUT STREET DENVER, CO 80205 T 303 382 1920

LIGHTING AE DESIGN 1900 WAZEE STREET, #205 DENVER, CO 80202 T 303 296 3034

AV/TECHNOLOGY/SECURITY SALAS O'BRIEN 4900 NAUTILUS CT. N. SUITE 200

BOULDER, CO 80301 T 303 865 5500

Full Design Team Roster on Sheet 1-G0.01





Boulder Western City Campus - Volume 1-Pavilion Office Building

1155 Alpine Ave Boulder, CO 80302

Original Issue

	Key	Plan	and	Orientation
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Revisions

Sheet Status NOT FOR CONSTRUCTION

Sheet Title PLAN, FLOOR - ROOF, EAST ENLARGED



Current Issue

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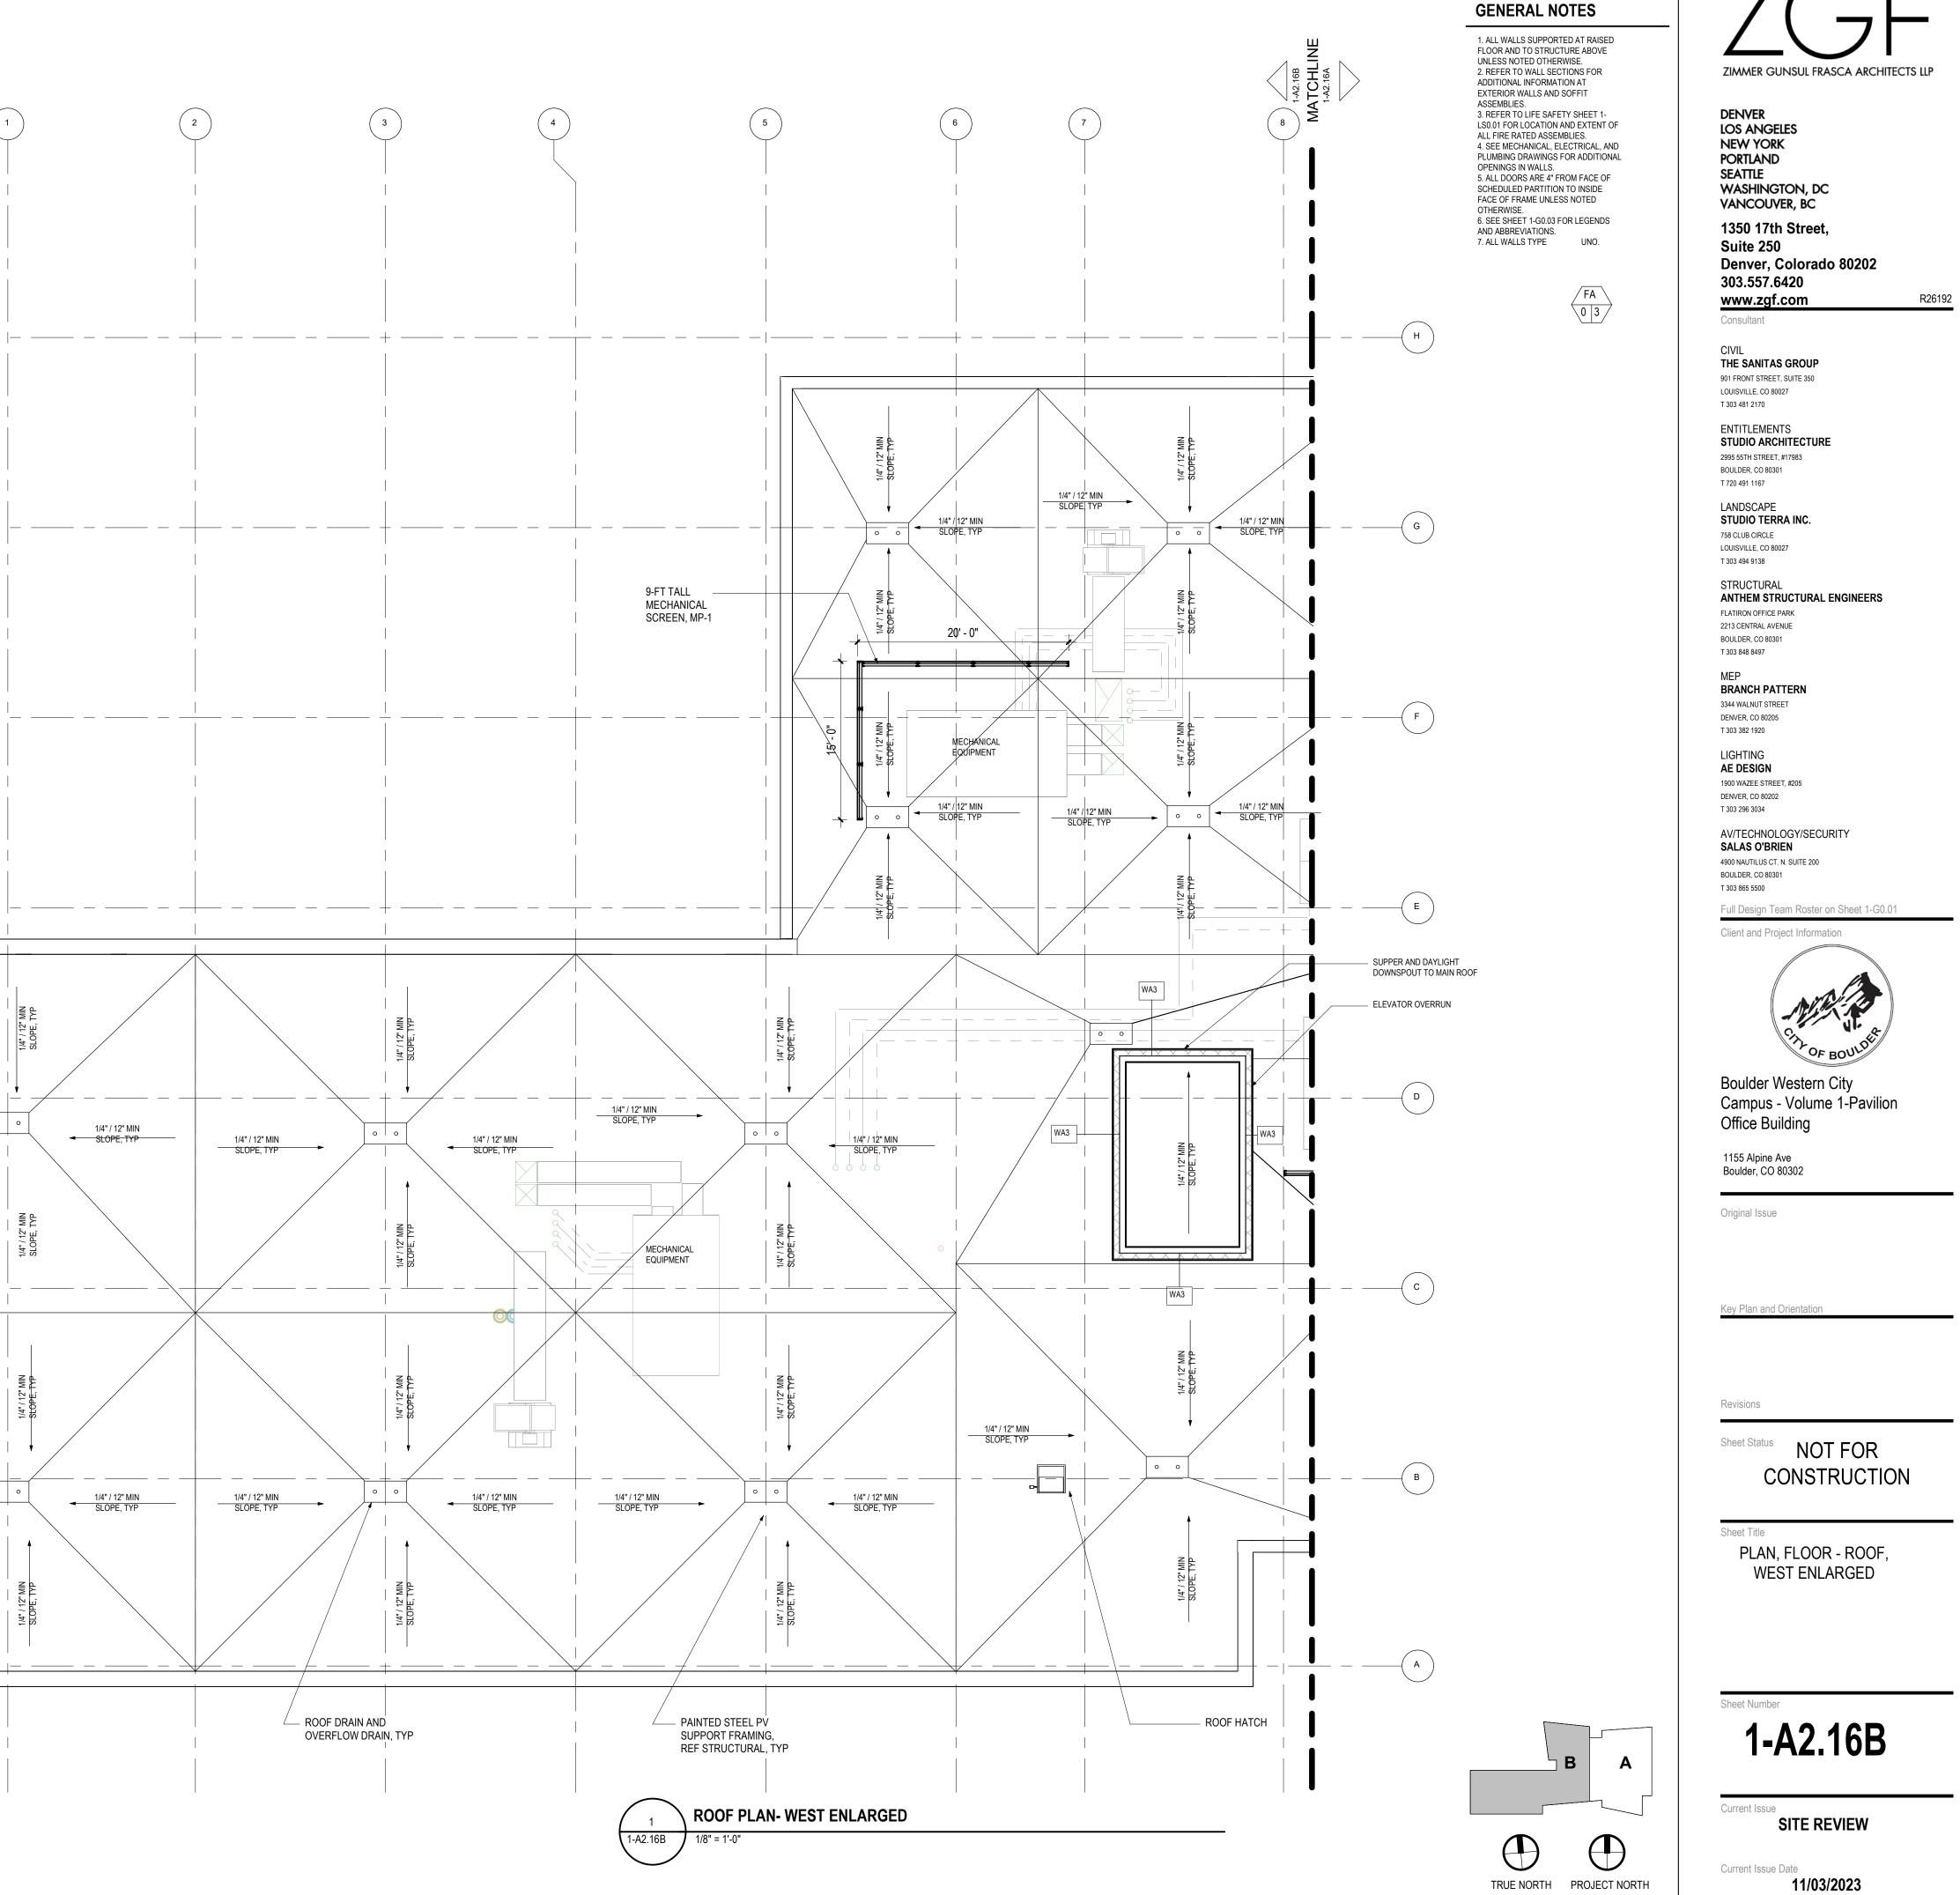
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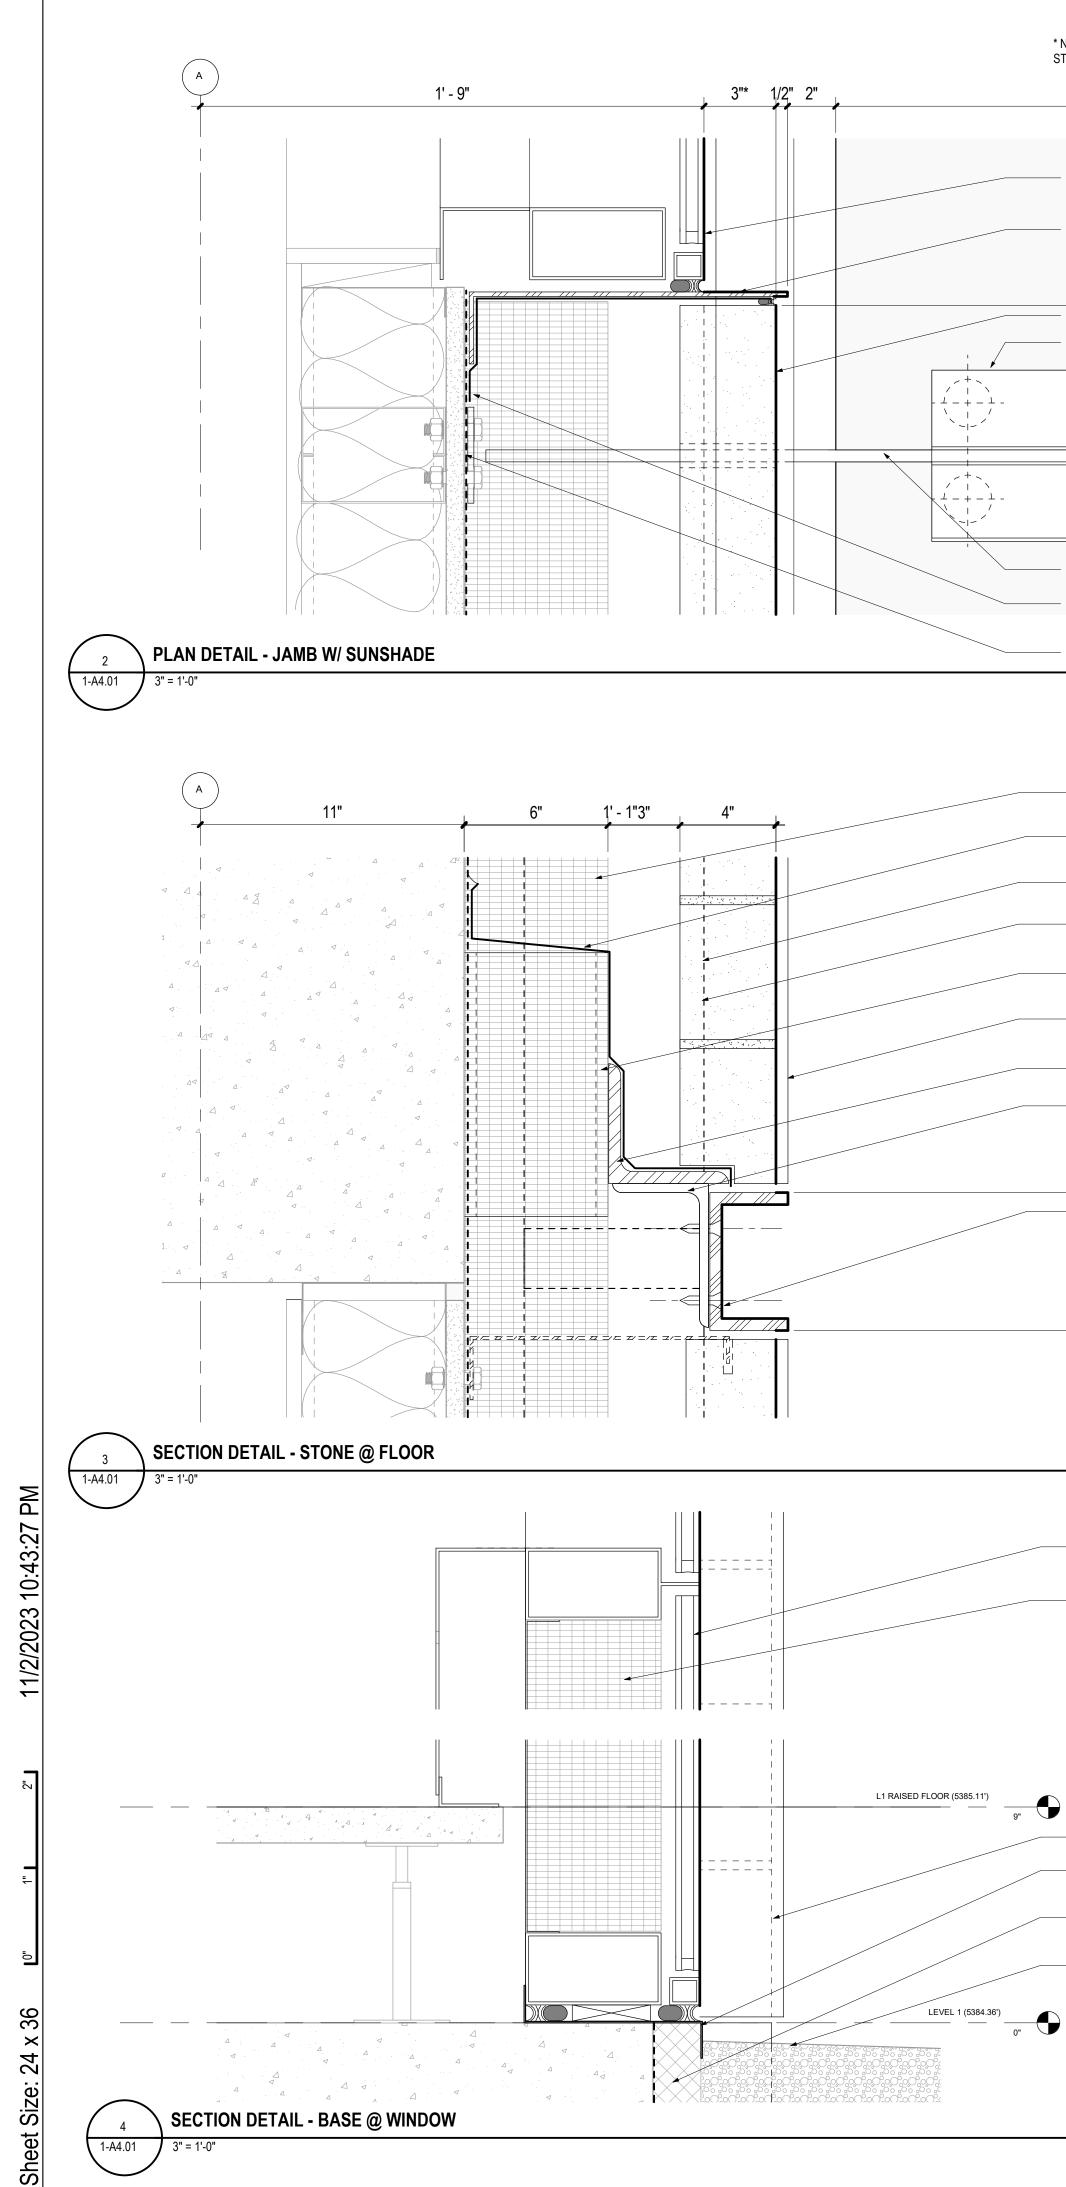
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✓ SLOPE, TYP 1/4" / 12" MIN SLOPE, TYP 36 24 ဟ Sheet





**N** REFERENCE AB  $\square$ FOR

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### \* NOTE: 2" MIN WINDOW RECESS FROM FACE OF STONE PER FORM BASED CODE M-1-25(A)(2)

1' - 9" 3"					l an diele
	-	ار 1' - 1 3/4" ا 11"	2 3/4"	7 1/4"	3"* 1/2"
- WINDOW SYSTEM	-			*	
— 3/16" PAINTED ALUM CONT.					
- STONE TYPE B - TYPE C SIM					
- GLASS BUTTON SUPPORT					
o.					
– 1/2" S.STL. SUPPORT BRACKET					
- FLEXIBLE FLASHING	1		4		
— WRB	 Д		4		
	⊿. ⊲		Δ		
	: 				
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SEMI RIGID CONT. EXTERIOR INSULATION					
—— S.STL. FLASHING					
3.3TL. FLASHING			2		
LINE OF WINDOW SYSTEM BEYOND	✓ Δ		<		
STONE B - SIM @ STONE C	۰. م				
—— GALV HSS AS REQUIRED			· · · Z		
—— PAINTED ALUM. ANGLE BEYOND	<ul> <li>✓</li> </ul>				
					J 4 I
—— GALV. RELEIVING ANGLE 5 X 5 X 1/2"	Δ				
GALV. ANGLE CLIP 6 X 4 X 3/8"	_ ⊲.				1/2" 3 1/4"
			√ 		
EXTRUDED ALUM. REVEAL TRIM - PAINTED**					
**NOTE: EXPRESSED LINTEL PER FORM#125BASED CODE SECTION M-1-25(A)(5)22	بن .				
•		1			
		Ĺ			
SPANDRAL GLASS					
SEMI RIGID INSULATION &					
SEALED BACK PAN					

LINE OF STONE BEYOND .050 S.STL. BACK PAN / FLASHING


— 2" RIGID INSULATION

MAINTENANCE STRIP

SECTION DETAIL - WINDOW SYSTEM @ FLOOR & SUN SHADE 1

1-A4.01 3" = 1'-0"

### \* NOTE: 2" MIN WINDOW RECESS FROM FACE OF STONE PER FORM BASED CODE M-1-25(A)(2)

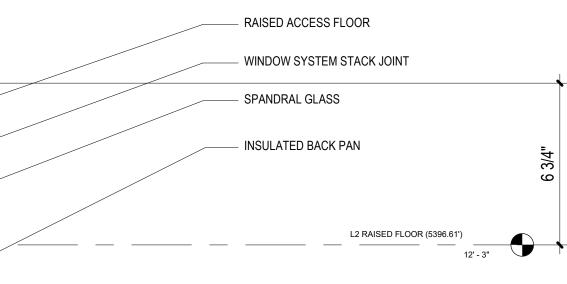

EXTRUDED ALUM. TRIM - PAINTED\*\*

\*\*NOTE: EXPRESSED LINTEL PER FORM BASED CODE SECTION M-1-25(A)(5)

- ZERO SIGHT LINE AWNING WINDOW

– SUN SHADE BRACKET BEYOND

LAMINATED GLASS SUNSHADE W/ GLASS BUTTON SUPPORT

- - - -. \_ \_ .

\_ \_ \_ \_ .



DENVER LOS ANGELES NEW YORK PORTLAND SEATTLE WASHINGTON, DC VANCOUVER, BC 1350 17th Street, Suite 250 Denver, Colorado 80202 303.557.6420 www.zgf.com

R26192

CIVIL THE SANITAS GROUP 901 FRONT STREET, SUITE 350 LOUISVILLE, CO 80027

Consultant

T 303 481 2170

ENTITLEMENTS STUDIO ARCHITECTURE 2995 55TH STREET, #17983 BOULDER, CO 80301 T 720 491 1167 LANDSCAPE

STUDIO TERRA INC. 758 CLUB CIRCLE LOUISVILLE, CO 80027 T 303 494 9138

STRUCTURAL ANTHEM STRUCTURAL ENGINEERS FLATIRON OFFICE PARK 2213 CENTRAL AVENUE BOULDER, CO 80301 T 303 848 8497

MEP BRANCH PATTERN 3344 WALNUT STREET DENVER, CO 80205 T 303 382 1920

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AV/TECHNOLOGY/SECURITY SALAS O'BRIEN 4900 NAUTILUS CT. N. SUITE 200

BOULDER, CO 80301 T 303 865 5500

Full Design Team Roster on Sheet 1-G0.01

Client and Project Information



Boulder Western City Campus - Volume 1-Pavilion Office Building

1155 Alpine Ave Boulder, CO 80302

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Revisions

Sheet Number

### Sheet Status NOT FOR CONSTRUCTION

Sheet Title **BUILDING DETAILS** 

1-A4.01

Current Issue SITE REVIEW





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CIVIL THE SANITAS GROUP 901 FRONT STREET, SUITE 350 LOUISVILLE, CO 80027 T 303 481 2170

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Client and Project Information



Boulder Western City Campus - Volume 1-Pavilion Office Building

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Sheet Title

BUILDING DETAILS


1-A4.02


Current Issue SITE REVIEW


Sheet Number





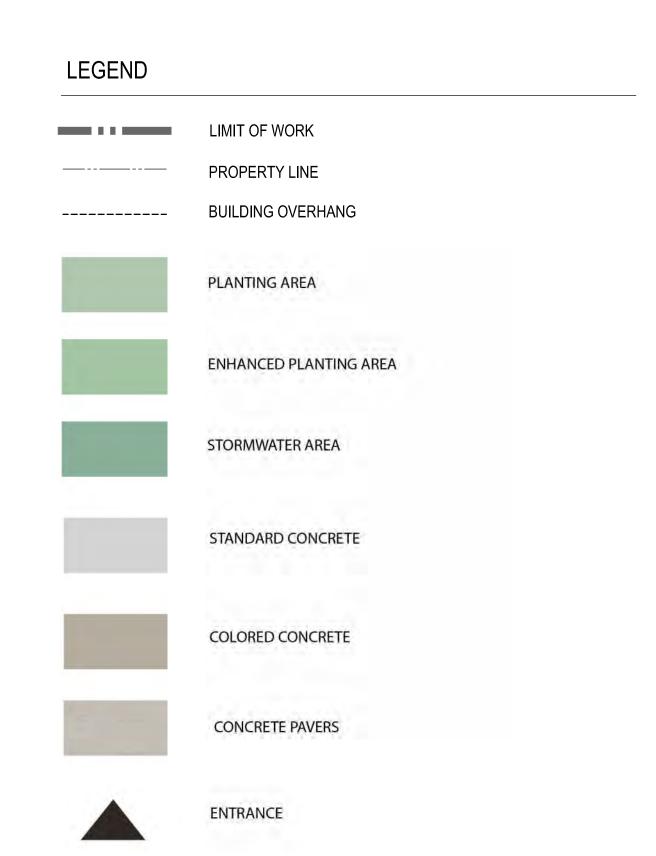

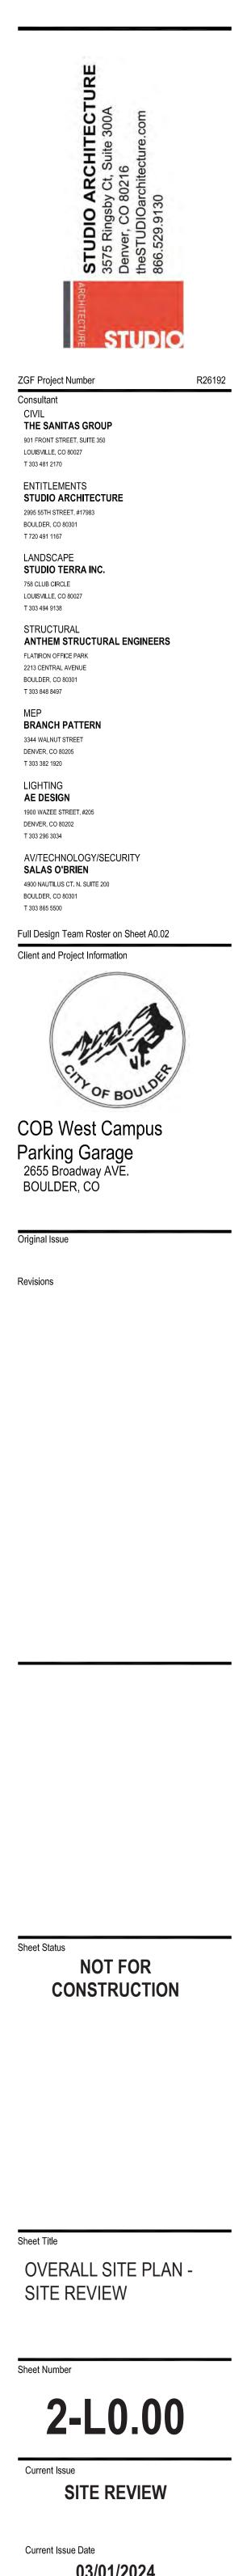

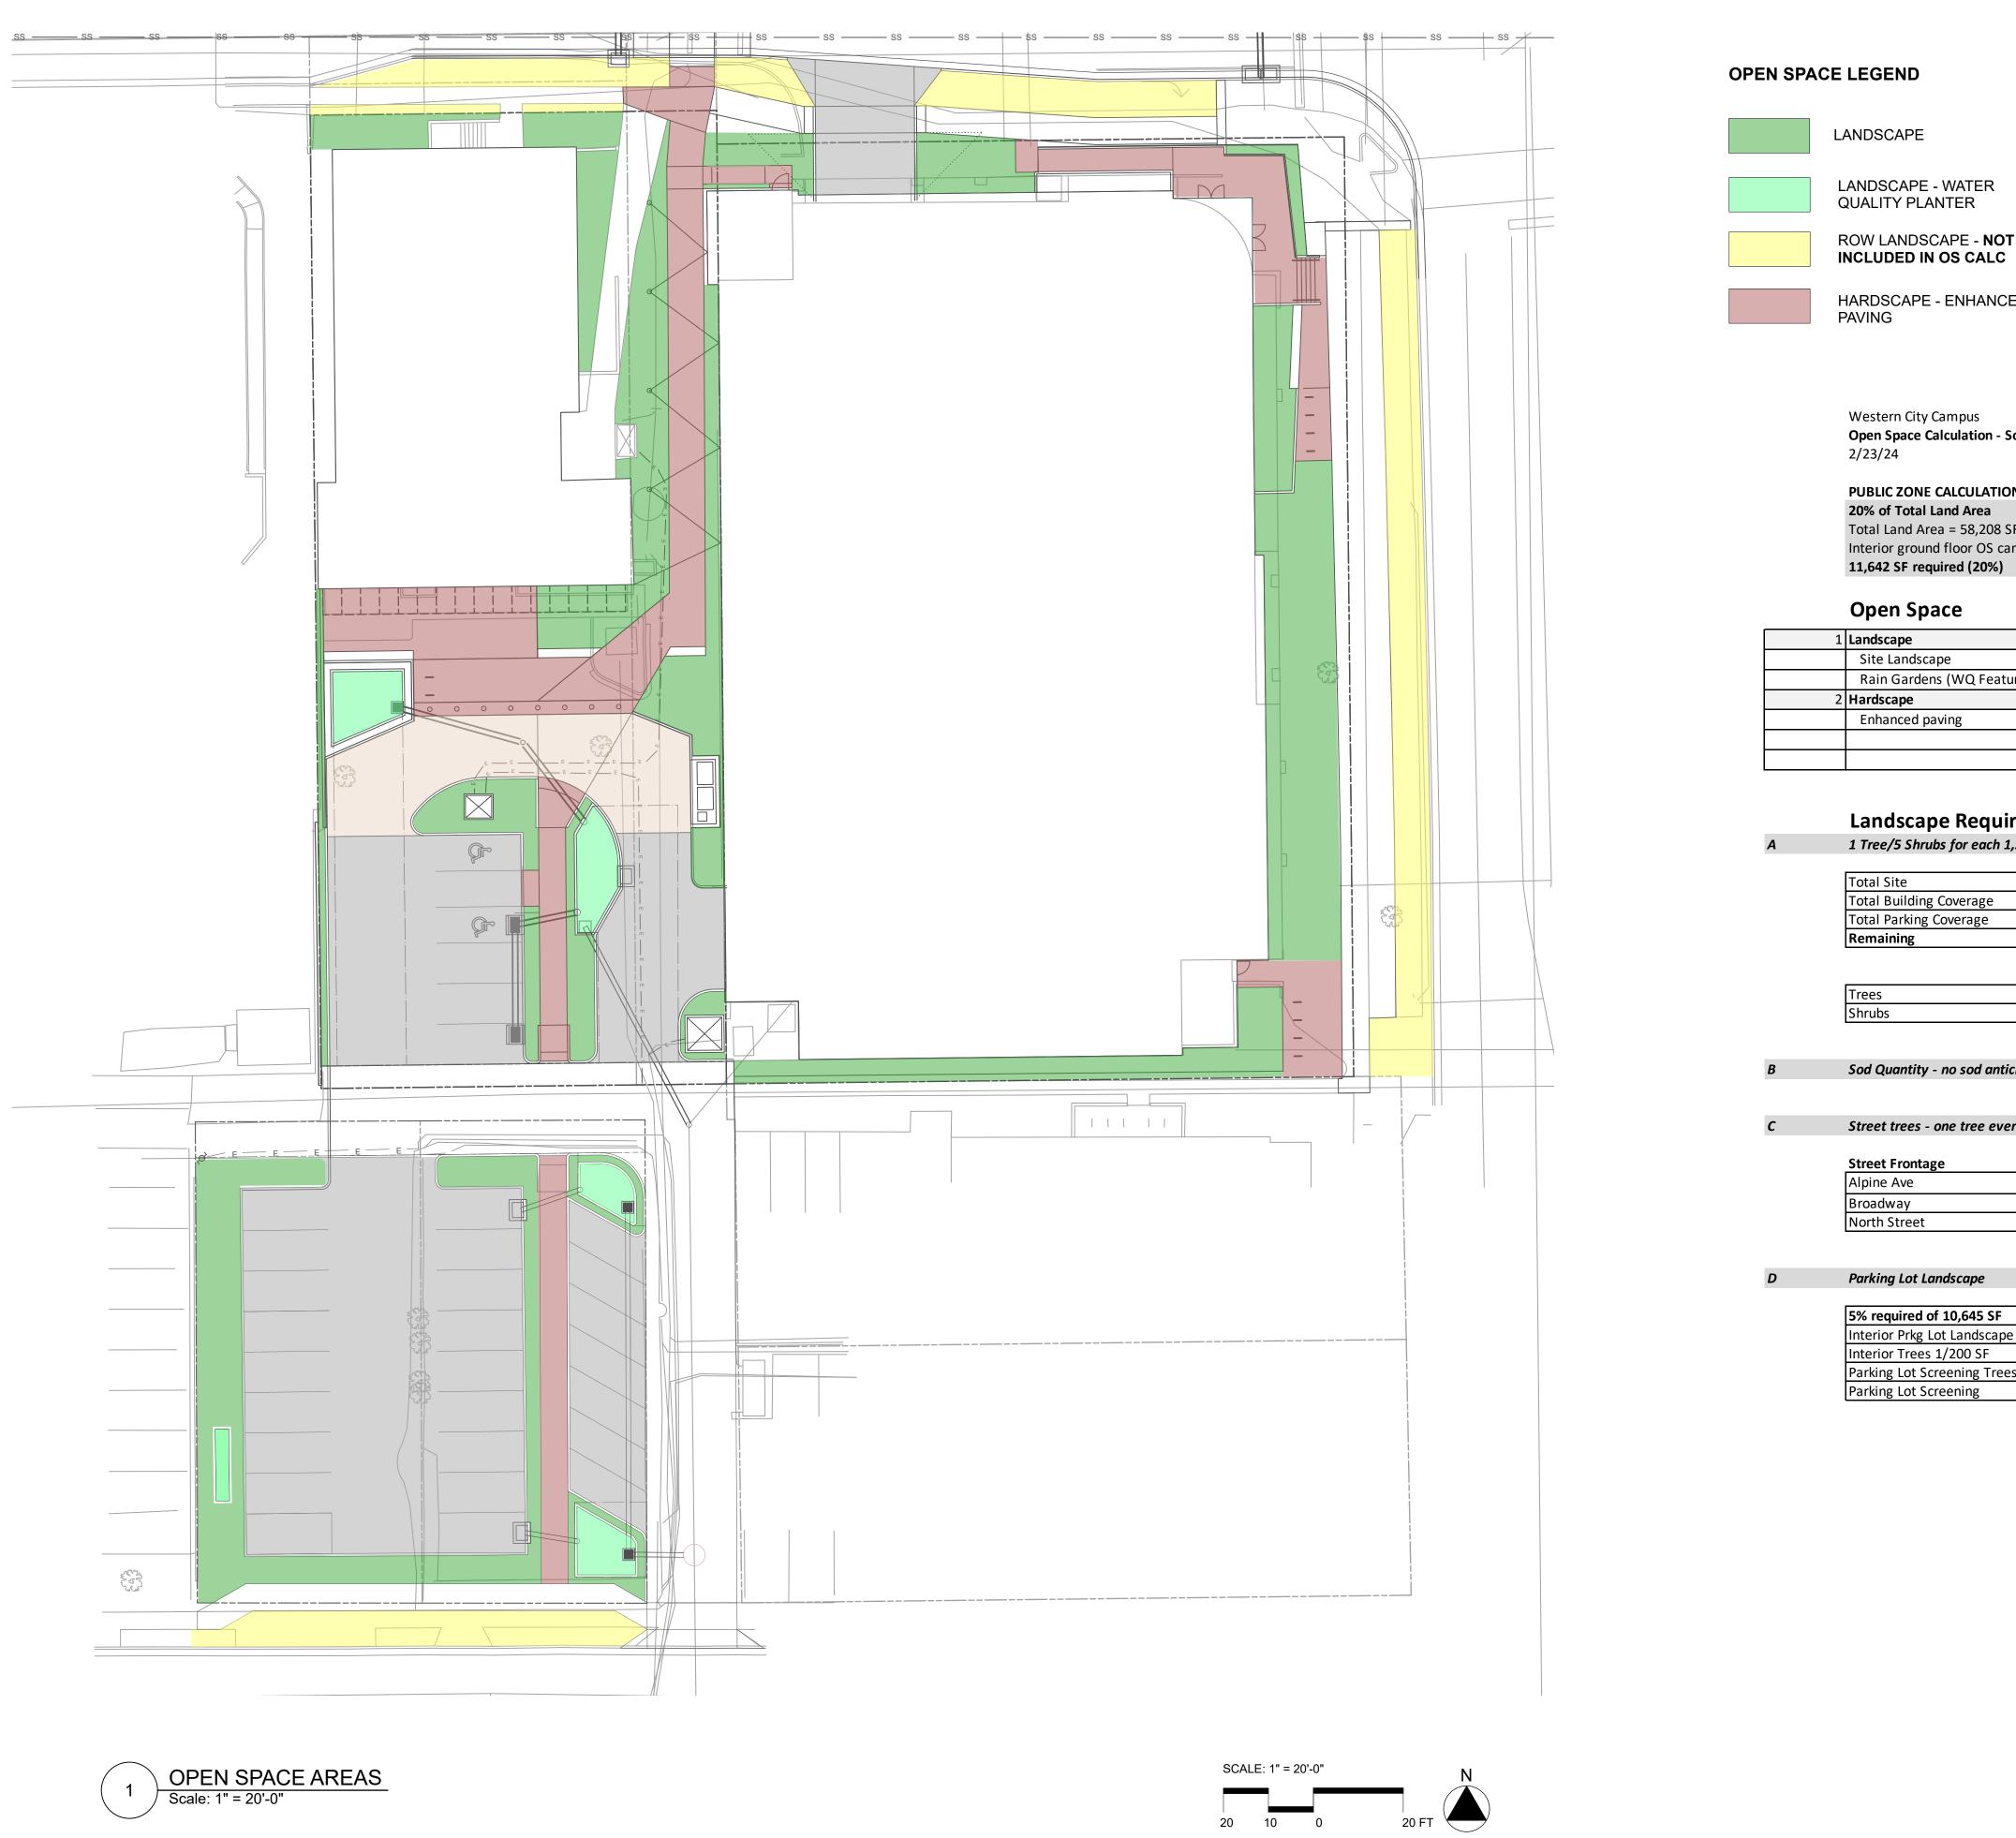

LANDSCAPE

LANDSCAPE - WATER QUALITY PLANTER

ROW LANDSCAPE - NOT

HARDSCAPE - ENHANCED PAVING

Western City Campus **Open Space Calculation - South of Alpine** 

PUBLIC ZONE CALCULATION

20% of Total Land Area Total Land Area = 58,208 SF

Interior ground floor OS can count up to 50% of required 14,759 SF provided (25+C2711272%) 11,642 SF required (20%)

Open Space

pen Space	Actual	Can Count		
dscape				
ite Landscape	8,985	8,985	SF	
ain Gardens (WQ Features)	438	438	SF	
rdscape				
nhanced paving	5,336	5,336	SF	
	14,759	14,759	SF	

### Landscape Requirements

1 Tree/5 Shrubs for each 1,500 S	F not covered by bu	ilding or park	ing
Total Site	58,208	SE	l
Total Building Coverage	28,285	SF	
Total Parking Coverage	11,272	SF	
Remaining	18,651	SF	
	Required	Provided	
Trees	12	16	33% more than required
Shrubs	62	100+	8,375 SF of Shrub beds provide

Sod Quantity - no sod anticipated on this project.

### Street trees - one tree every 40 LF

eet Frontage			Required	Provided
pine Ave	214	LF	5	5
badway	188	LF	5	6
rth Street	99	LF	2	3

Required532SF Provided 1,122 SF 5% required of 10,645 SF Interior Prkg Lot Landscape Interior Trees 1/200 SF 3 EA 4 EA 3 EA Parking Lot Screening Trees Parking Lot Screening 4 EA Vines to be planted along existing chain link fence 42" screen 42" screen

> STUDIOTERRA 758 Club Circle Louisville, Colorado 80027 303.494.9138 www.studioterra.net



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THE SANITAS GROUP 901 FRONT STREET, SUITE 350 LOUISVILLE, CO 80027

T 303 481 2710 ENTITLEMENTS STUDIO ARCHITECTURE 2995 55TH STREET, #17983 BOULDER, CO 80301

T 720 491 1167

T 303 494 9138

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STRUCTURAL ANTHEM STRUCTURAL ENGINEERS FLATIRON OFFICE PARK 2213 CENTRAL AVENUE


BOULDER, CO 80301 T 303 848 8497 MEP **BRANCH PATTERN** 3344 WALNUT STREET

DENVER, CO 80205 T 303 382 1920

LIGHTING **AE DESIGN** 1900 WAZEE STREET, #205 DENVER, CO 80202 T 303 296 3034

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Full Design Team Roster on Sheet A0.02 Client and Project Information

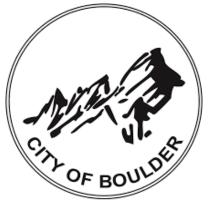

COB West Campus Parking Garage 2655 BROADWAY Boulder, CO 80302

Original Issue

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Sheet Title

Sheet Number

Current Issue Date

2-L0.10

Current Issue

03/01/2023

SITE REVIEW LANDSCAPE COMPLIANCE

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Sheet Status







ZGF Project Number Consultant

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STRUCTURAL ANTHEM STRUCTURAL ENGINEERS FLATIRON OFFICE PARK 2213 CENTRAL AVENUE BOULDER, CO 80301

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COB West Campus Parking Garage 2655 Broadway AVE. BOULDER, CO

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3D VIEWS - BRENTON DROP OFF ZONE

Sheet Number

Current Issue

Sheet Title



SITE REVIEW

Current Issue Date 03/01/2024 CITY OF BOULDER

**DESIGN AND CONSTRUCTION STANDARDS** 3.05 Tree Protection for Construction Sites

(A) Tree Protection Required (1) An applicant for construction approval shall protect trees and plants in the public right-of-way and on any project or construction site where public improvements are proposed

(2) An applicant for construction approval shall submit a landscaping plan incorporating proposed tree protection measures for any existing trees located in the public right-of-way and on site at any project or construction site where public improvements are proposed in compliance with these Standards. (3) The landscaping plan shall identify any potential detrimental effects to existing trees that

might result from proposed construction activities within 20 feet of the dripline of any existing trees located on site or in the adjacent public right-of-way. The plan shall include the species, size, and location of all existing trees that are 1-inch or larger caliper size. If no existing trees are present that require protection, this shall be noted on the plan. Existing trees approved to be removed or relocated shall be clearly identified on the landscaping plan. (4) The applicant for construction approval shall notify the City within 24-hours of any suspected damage to trees resulting from construction activities. If damage occurs during construction, the applicant shall have the damaged tree restored immediately by a qualified arborist. (B) Tree Protection Procedures

(1) Protective Maintenance: An applicant for construction approval shall provide maintenance and care for existing trees required to be protected on site and in the public right-of-way adjacent to any project or construction site during construction activities and the public improvement warranty period to ensure that existing trees survive and are not damaged. (2) Soil Compaction Prevention

(a) To prevent soil compaction, designated routes for equipment and foot traffic by work crews shall be determined prior to commencing construction activities and indicated in the landscaping tree protection plan.

(b) These planned routes shall be marked at the site before construction commences with durable fencing material that is at least 4 feet high. Flagging tape or any other material that may be torn down, moved, or evaded is not acceptable. (c) The contractor shall inform all construction crew members on the site of access routes and will ensure that only these routes are used.

(d) To prevent tree root smothering, no soil stockpiles, supplies, equipment, or any other material shall be placed or stored within a tree dripline or within 15 feet of the tree trunk for column-shaped trees, whichever distance is greater(e) Soil around a tree dripline may be required to be aerated during and after construction activities. This is necessary even when compaction results from heavy foot traffic. A professional arborist shall do the vertical aeration or soil fracturing.

Oil fracturing techniques comparable to using a "growgun" with Isolite material are acceptable. Conventional turf aeration is not acceptable. (f) When foot traffic or equipment use is unavoidable within the dripline, the area within the dripline shall be mulched with wood chips to a depth of 6 inches before construction activity begins. A 6-inch mulch depth shall be maintained for the duration of the project, then removed when construction activities are completed.

(3) Root Protection (a) Tree roots shall not be cut unless cutting is unavoidable. (b) When root cutting is unavoidable, a clean, sharp cut shall be made to avoid shredding or smashing. Root cuts should be made back to a lateral root.

(c) Whenever possible, tree roots should be cut between late fall and bud opening, when root energy supplies are high and conditions are least favorable for disease causing (d) The City shall be notified of any cutting of the following roots:

) Two roots having a diameter of more than 3 inches, or Four roots having diameters between 2 and 3 inches

(e) Trenches shall be hand-dug within the dripline in areas where roots 2 inches and larger in diameter are present, and when low branches which may be damaged by equipment are present.

(f) Whenever possible, roots 2 inches or larger in diameter shall be tunneled or bored under and shall be covered to prevent dehydration. Exposed roots shall be covered immediately with soil or burlap and kept moist. (g) Power tools shall not be used to prune roots, with the exception of arboriculturally

approved root-cutting equipment used under the supervision of the City. Only the following approved tools shall be acceptable: scissors-type hand pruners and loppers, except anvil-types, and arborist-type pruning saws. (h) When more than one root 2 inches or larger in diameter on any public tree is cut, supplemental watering shall be provided if the tree lacks an operational sprinkler system. The applicant or abutting landowner shall provide the watering.

(i) Sidewalk and paving surfaces shall be sufficiently contoured to avoid cutting surface tree roots. Whenever possible, tree roots should be bridged or floated over with walks.

(j) To allow maximum aeration and water penetration to roots, walk materials other than concrete may be selected (e.g., brick, flagstone, honeycomb block, chips, gravel) subject to City approval. Under no circumstances shall impervious material make contact with or completely encircle a tree trunk. (k) Auger tunneling, not trenching, shall be used where possible for utility placement within the dripline of a tree.

(I) If roots are cut between March and August, trees may need supplemental deep root watering once per week for at least 2 months after the roots are cut. When rootsare cut between September 1 and October 15, trees may need supplemental watering once per week until at least October 31. (m) Tree roots shall not be fertilized for a period of 1 year following the cessation of

construction activities. Thereafter, for the next 2 years, a light annual fertilization using a slow release nitrogen source is acceptable. (4) Tree Fencing (a) Fencing material shall encircle any tree whose outer dripline edge is within 20 feet of

any construction activities. (b) Fencing material shall be a bright, contrasting color, durable, and at least 4 feet high. Fence posts shall be comparable to metal T-posts or heavier posts and placed at least 2 feet below ground.

(c) Fencing material shall be placed at the dripline or at least 15 feet from any tree trunk, whichever distance is greater, and maintained in an upright position throughout the duration of construction activities. (d) The applicant for construction approval shall indicate fencing locations on the

landscaping tree protection plan. (e) Heavy objects, such as wood pallets or metal railings, shall not lean against or come


into contact with any tree trunk. (5) Grade Changes: Grade changes, such as removing topsoil or adding fill material, shall not occur within the dripline of any existing tree. If necessary as part of project or site development, retaining walls and tree wells to maintain the existing grade within the dripline of any tree may be acceptable when constructed prior to site grading changes near the tree. A landscaping plan containing an illustrated design scheme of the tree protection improvement shall be approved by the City prior to initiating any grade changes near existing

(6) Transplanting: Any proposed or required transplanting shall conform with the requirements in Section 3.04(D), "Tree Relocation (Transplanting)."

(7) Chemical/Foreign Material Disposal (a) Disposing of chemicals or foreign material anywhere on site or in the public right-of-way is prohibited. This shall include, but is not limited to: paint, stain, solvents, concrete or any construction material onsite, and rinse water from any

cans or tools containing chemicals. (b) Soil samples may be taken to determine the presence of chemicals or foreign

materials for any planter containing proposed or existing plant material. (8) Pruning: Pruning shall not occur during construction activities or the public improvement warranty period, except to remove dead or damaged branches or to prevent branch damage that could occur during construction, without the prior approval of the City. Pruning of healthy branches shall be delayed for a period of 2 years after construction activities are completed

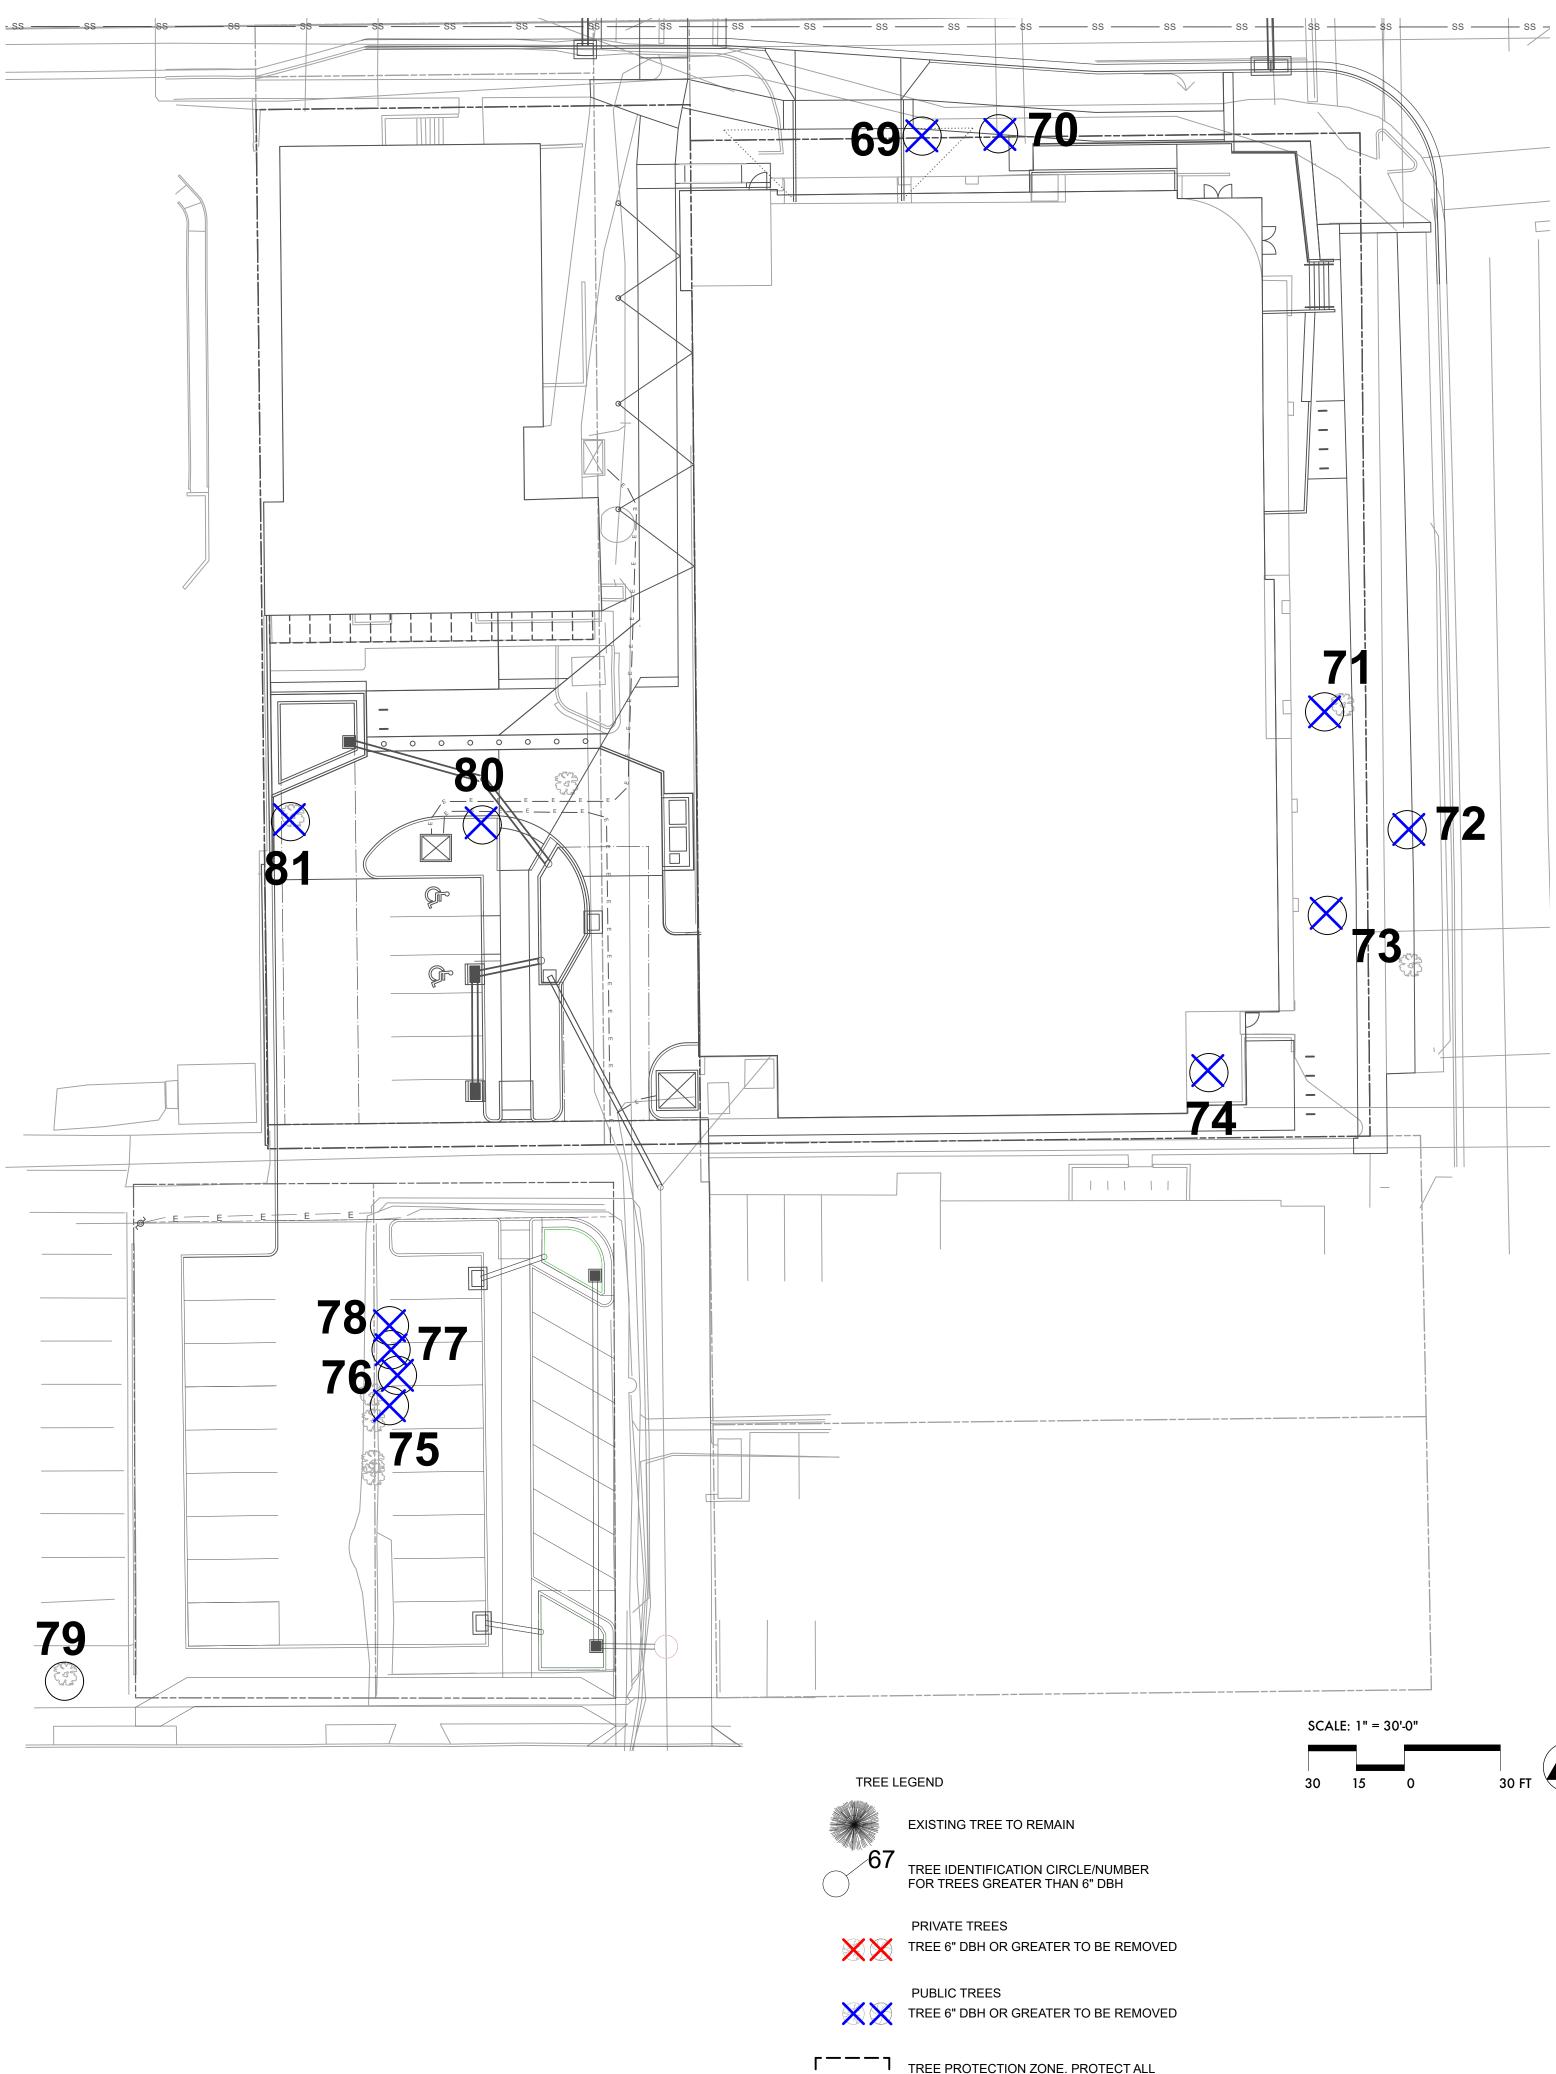

All tree protection standards of Ch. 3 and 10 of the Design and Construction Standards shall be met with particular attention given to grading impacts, limitations of stockpiling, soil compaction prevention and vehicular routes. Tree protection fencing shall be installed prior to any site disturbance and remain in place for the duration of the project. Only hand digging may occur within the dripline of any tree to be preserved. Provide sufficient irrigation throughout construction to maintain the long term health of the tree(s).

\_\_\_\_ ROOTS IN THIS ZONE



**35** Austrian pine

ID# Common Name Scientific Name

Pinus nigra

West City Campus Site **Tree Inventory** 

Remove


DBH Condition Comments

Good


(in) <u>Rating</u>

13.0

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PRICING NOTE: CITY FORESTOR WILL ASSESS MITIGATION FEE FOR ALL HEALTHY PUBLIC TREES TO BE REMOVED. NEW TREES PLANTED CAN OFFSET THIS FEE.

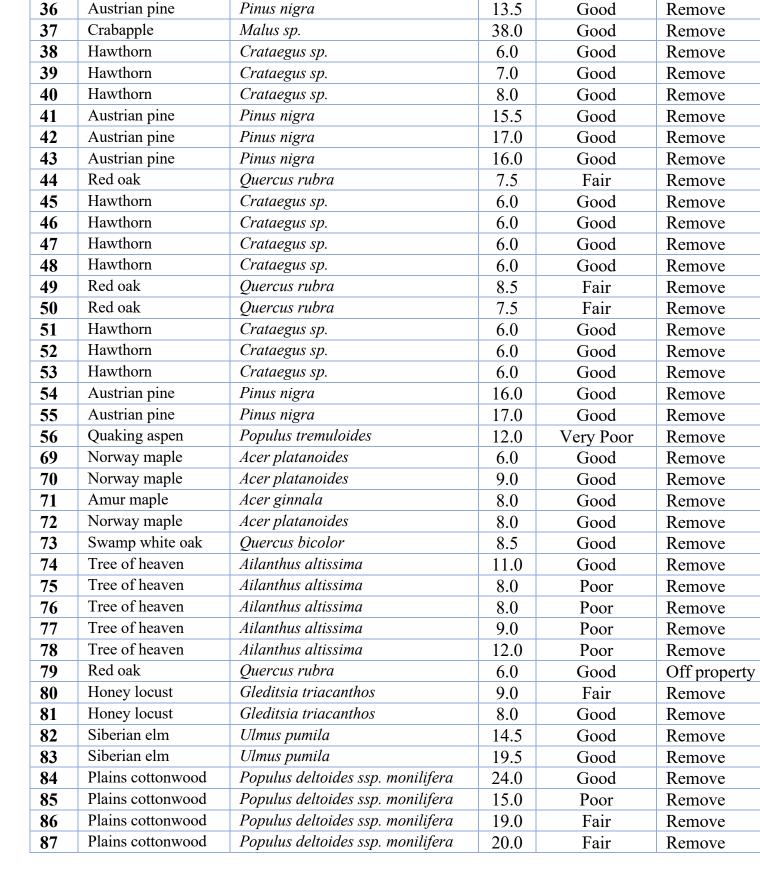



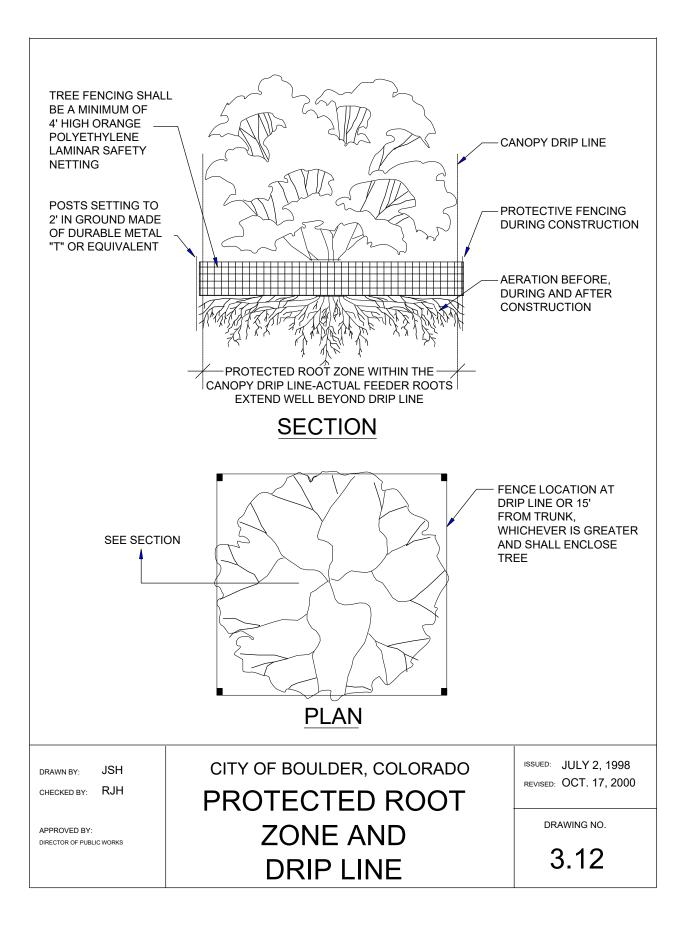

Consultant

### CIVIL

THE SANITAS GROUP 901 FRONT STREET, SUITE 350 LOUISVILLE, CO 80027 T 303 481 2710

### **ENTITLEMENTS STUDIO ARCHITECTURE** 2995 55TH STREET, #17983 BOULDER, CO 80301 T 720 491 1167

LANDSCAPE **STUDIO TERRA INC.** 758 CLUB CIRCLE LOUISVILLE, CO 80027

T 303 494 9138 STRUCTURAL ANTHEM STRUCTURAL ENGINEERS

FLATIRON OFFICE PARK 2213 CENTRAL AVENUE BOULDER, CO 80301 T 303 848 8497

**BRANCH PATTERN** 3344 WALNUT STREET DENVER, CO 80205 T 303 382 1920

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COB West Campus Parking Garage 2655 BROADWAY Boulder, CO 80302

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Sheet Title

TREE REMOVAL PLAN

Sheet Number



Current Issue SITE REVIEW

Current Issue Date

### PLANT SCHEDULE

	IALS					_				
KEY		QUANTITY		COMMON NAME	HEIGHT		WATER USE	EXPOSURE	FLOWER COLOR	SEASON
MTC	1 GAL	TBD	ACHILLEA MILLEFOLIUM 'TERRA COTTA'	TERRA COTTA YARROW	18-24"	18-24"	LOW	SUN	PEACH	SUMMER
RU	1 GAL		AGASTACHE RUPESTRIS	SUNSET HYSSOP	2-3'	2-3'	LOW	SUN	ORANGE PINK	SUMMER TO FALL
MMG	1 GAL	TBD	ALYSSUM MONTANUM 'MOUNTAIN GOLD'	MOUNTAIN BASKET OF GOLD	6-12"	12-18"	LOW	SUN	MUSTARD YELLOW	MID-SPRING
COE			AQUILEGIA COERULEA	ROCKY MOUNTAIN COLUMBINE	18-24"	12-18"	MEDIUM		BLUE WITH WHITE CENTER	LATE SPRING TO EARLY SUMM
XCC			ARCTOSTAPHYLOS X COLORADOENSIS CHIEFTAN	CHIEFTAN MANZANITA	3-4'	5-6;	LOW	SUN TO FILTERED SHADE	SOFT PINK	LATE WINTER TO EARLY SPRIN
PL	1 GAL		CERATOSTIGMA PLUMBAGINOIDES	PLUMBAGO	8-12"	18-24"	LOW	ADAPTABLE	BLUE	MID TO LATE SUMMER
ΣVZ	1 GAL		COREOPSIS VERTICILLATA 'ZAGREB'	ZAGREB COREOPSIS	12-18"	12-18"	LOW	SUN	GOLD	MID-SUMMER TO FALL
FC	1 GAL		EUONUMUS FORTUNEI 'COLORATUS'	PURPLELEAF WINTERCREEPER	12-18"	3-6'	LOW	ADAPTABLE	INSIGNIFICANT	EARLY SUMMER
SVI	1 GAL		GERANIUM VISCOSISSIMUM	STICKY GERANIUM	1-3'	18-24"	LOW	ADAPTABLE	ROSE-PURPLE	LATE SPRING TO SUMMER
ЛFM	1 GAL	TBD	MONARDA FISTULOSA MENTHIFOLIA	NATIVE LAVENDER BEE-BALM	2-3'	18-24"	LOW	SUN	LAVENDER	MID-SUMMER
PMC			PENSTEMON X MEXICALI 'CAROLYN'S HOPE'	CAROLYN'S HOPE PINK PENSTEMON	12-15"	8-12"	LOW	SUN	PINK	SPRING TO SUMMER
PATR			PEROVSKIA ATRIPLICIFOLIA	RUSSIAN SAGE	3-4'	3-4'	VERY LOW	SUN	BLUE	MID TO LATE SUMMER
GG	1 GAL	TBD	ZINNIA GRANDLIFLORA 'GOLD ON BLUE'	GOLD ON BLUE ROCKY MOUNTAIN ZINNIA	6-8"	8-12"	VERY LOW	SUN	GOLDEN YELLOW	MID TO LATE SUMMER
DRNAM	ENTAL GI	RASSES								
(EY	SIZE	QUANTITY	BOTANICAL NAME	COMMON NAME	HEIGHT	SPREAD	WATER USE	EXPOSURE	FLOWER COLOR	SEASON
'C	1 GAL	TBD	ACHNATHERUM CALAMAGROSTIS	UNDAUNTED APLINE PLUME GRASS	2-3'	2-3'	LOW	SUN	TAN	MID-SUMMER
GW	1 GAL	TBD	ANDROPOGON GERARDII WINDWALKER	WINDWALKER BIG BLUESTEM GRASS	4-6'	2-3'	LOW	SUN	PURPLE	SUMMER
В	1 GAL	TBD	CALAMAGROSTIS BRACHYTRICHA	KOREAN FEATHER REED GRASS	3-4'	2-3'	LOW	SUN TO FILTERED SHADE	PINKISH-TAN	LATE SUMMER
/IR	1 GAL	TBD	MUHLENBERGIA REVERCHONII UNDAUNTED	UNDAUNTED RUBY MUHLY GRASS	15-30"	18-24"	LOW	SUN	RUBY-PINK	FALL
SS	1 GAL	TBD	SCHIZACHYRIUM SCOPARIUM 'STANDING OVATIO	N STANDING OVATION LITTLE BLUESTEM GRA	\S 3-4'	12-18"	LOW	SUN	SILVER	LATE SUMMER
NT	1 GAL		SORGHASTRUM NUTANS 'THIN MAN'	THIN MAN INDIAN GRASS	5-7'	2-3'	LOW	SUN	YELLOW	SUMMER
ECIDU (EY	DUS SHR		BOTANICAL NAME	COMMON NAME	HEIGHT	SPREAD	WATER USE	EXPOSURE	COLOR	SEASON
N		-	AMORPHA NANA	DWARF FALSE INDIGO	1-2'	1-2'	VERY LOW	SUN	PURPLE	SUMMER
ML	5 GAL	TBD	ARONIA MELANOCARPA LOW SCAPE MOUND	LOW SCAPE MOUND BLACK CHOKEBERRY	1-2'	18-24"	LOW	ADAPTABLE	WHITE	LATE SPRING
BC	5 GAL		BUDDLEJA 'BLUE CHIP'	DWARF PURPLE-BLUE BUTTERFLY BUSH	24-30"	2-4'	MEDIUM	SUN	PURPLE-BLUE	SUMMER TO FALL
CHM	5 GAL		CHAMAEBATIARIA MILLEFOLIUM	FERNBUSH	2	3-6'	VERY LOW	SUN	WHITE	MID TO LATE SPRING
DBC	5 GAL		DAPHNE X BURKWOODII 'CAROL MACKIE'	CAROL MACKIE DAPHNE	3-5'	3-5'	MEDIUM	FILTERED SHADE TO SHADE		SPRING
FE	5 GAL		EUONYMUS FORTUNEI 'EMERALD GAIETY'	EMERALD GAIETY EUONYMUS	3-5 18-24"	3-4'	MEDIUM	FILTERED SHADE TO SHADE		EARLY SUMMER
	5 GAL		FALLUGIA PARADOXA		16-24 3-6'	3-4 3-6'			WHITE	
P							VERY LOW	SUN		SUMMER
IP IP	5 GAL		HESPERALOE PARVIFLORA	RED FALSE YUCCA	3-4'	3-4'	VERY LOW	SUN	RED TO ORANGE-RED	SUMMER
IPY	5 GAL		HESPERALOE PARVIFLORA 'YELLOW'	YELLOW FALSE YUCCA	3-4'	3-4'	VERY LOW	SUN	YELLOW	SUMMER
VL	5 GAL		LIGUSTRUM VULGARE 'LODENSE'	LODENSE PRIVET	2-3'	3-4'	LOW	SUN TO FILTERED SHADE	WHITE	EARLY SUMMER
S	5 GAL		PHILADELPHUS X 'SNOWBELLE'	SNOWBELLE MOCKORANGE	3-4'	3-4'	LOW	SUN	WHITE	LATE SPRING TO EARLY SUMME
PON	5 GAL		PHYSOCARPUS OPULIFOLIUS 'NANUS'	DWARF NINEBARK	4-5'	4-5'	LOW	SUN TO FILTERED SHADE	WHITE	LATE SPRING
врв	5 GAL		PRUNUS BESSEYI PAWNEE BUTTES	CREEPING WESTER SAND CHEERY	15-30"	4-6'	LOW	SUN	WHITE	SPRING
RAG	5 GAL		RHUS AROMATICA 'GRO-LOW'	DWARF FRAGRANT SUMAC	2-3'	6-8'	LOW	SUN	YELLOW	EARLY SPRING
RA	5 GAL		RIBES ALPINUM	ALPINE CURRANT	3-6'	3-6'	LOW	SUN TO FILTERED SHADE	YELLOWISH-GREEN	MID-SPRING
RW	5 GAL	TBD	ROSA WOODSII	WOODS' ROSE	3-6'	3-6'	LOW	SUN	PINK	EARLY SUMMER
VERGR	EEN SHR	UBS								
ΣEY			BOTANICAL NAME	COMMON NAME	HEIGHT		WATER USE	EXPOSURE	COLOR	SEASON
CG	5 GAL		JUNIPERUS COMMUNIS 'GREEN CARPET'	GREEN CARPET JUNIPER	8-10"	2-3'	LOW	SUN	N/A	N/A
HI	5 GAL	TBD	JUNIPERUS HORIZONTALIS ICEE BLUE	ICEE BLUE JUNIPER	2-4"	6-8'	LOW	SUN	N/A	N/A
SC	5 GAL	TBD	JUNIPERUS SABINA CALGARY CARPET	CALGARY CARPET JUNIPER	12-18"	6-8'	LOW	SUN TO FILTERED SHADE	N/A	N/A
IAC	5 GAL	TBD	MAHONIA AQUIFOLIUM 'COMPACTA'	COMPACT OREGON GRAPE HOLLY	2-3'	2-3'	LOW	SHADE	YELLOW	MID-SPRING
WM	5 GAL	TBD	PINUS MUGO 'WHITE BUD'	WHITE BUD MUGO PINE	2-3'	3-4'	LOW	SUN TO FILTERED SHADE	N/A	N/A
SA	5 GAL	TBD	PINUS SYLVESTRIS 'ALBYN PROSTRATA'	SPREADING SCOTS PINE	2'	8'	LOW	SUN	N/A	N/A
RNAM	ENTAL TR	REES								
EY	-		BOTANICAL NAME		HEIGHT	SPREAD	WATER USE	EXPOSURE	COLOR	SEASON
GTS	2.0" CA	•	GLEDITSIA TRIACANTHOS STREET KEEPER	STREET KEEPER HONEYLOCUST	30-45'	15-20'	LOW	SUN	N/A	N/A
VS	2.0" CA		PRUNUS VIRGINIANA 'SHUBERT'	SHUBERT OR CANADA RED CHOKEBERRY	20-30'	15-25'	LOW	SUN	WHITE	SPRING
PCR	2.0" CA		PYRUS CALLERYANA 'REDSPIRE'	REDSPIRE PEAR	30-35'	20-25'	MEDIUM	SUN	WHITE	SPRING
S	2.0" CA		XANTHOCERAS SORBIFOLIA	YELLOWHORN	8-25'	10-25'	MEDIUM	SUN	WHITE W/ RED OR YELLOW	SPRING
	0.555	9	)							
HADE 1		QUANTITY	BOTANICAL NAME		HEIGHT	SPREAD	WATER USE	EXPOSURE	COLOR	SEASON
	2.5" CA	1	5 CORYLUS COLURNA	TURKISH FILBERT	30-45'	25-30'	LOW	SUN	N/A	N/A
XEY C	OA		GYMNOCLADUS DIOICUS 'ESPRESSO'	SEEDLESS KENTUCKY COFFEETREE	50-60'	40-50'	LOW	SUN	YELLOW-GREEN	SPRING
C	2 5" C^		QUERCUS BICOLOR	SWAMP WHITE OAK	40-60'	40-50 40-60'	LOW	SUN TO FILTERED SHADE	N/A	N/A
C GDE	2.5" CA 2 5" CA	,		BUR OAK	40-00 50-80'	40-80 50-80'	LOW	SUN TO FILTERED SHADE	N/A	N/A
C GDE QB	2.5" CA				30-80 35-50'	30-80 35-50'	LOW	SUN	N/A	N/A N/A
CC GDE QB QM	2.5" CA 2.5" CA	L 2	2 QUERCUS MACROCARPA			22-20		JUN		1 N / M
CC GDE QB QM QMU	2.5" CA 2.5" CA 2.5" CA	.L 2 .L 6	QUERCUS MUEHLENBERGII	CHINKAPIN OAK ACCOLADE ELM			MEDIUM	SUN	N/A	N/A
C GDE QB QM QMU JA	2.5" CA 2.5" CA 2.5" CA 2.5" CA	L 2 L 6 L 2 18	QUERCUS MUEHLENBERGII ULMUS ACCOLADE	CHINKAPIN OAK ACCOLADE ELM	50-70'	30-40'	MEDIUM	SUN	N/A	N/A
C GDE QB QM QMU JA	2.5" CA 2.5" CA 2.5" CA 2.5" CA 2.5" CA	L 2 L 6 L 2 <u>18</u> ES	QUERCUS MUEHLENBERGII ULMUS ACCOLADE	ACCOLADE ELM	50-70'	30-40'			·	
C GDE QB QM QMU JA VERGR	2.5" CA 2.5" CA 2.5" CA 2.5" CA 2.5" CA	L 2 L 6 L 2 <u>18</u> ES QUANTITY	OUERCUS MUEHLENBERGII ULMUS ACCOLADE BOTANICAL NAME	ACCOLADE ELM COMMON NAME	50-70' HEIGHT	30-40'	WATER USE	EXPOSURE	COLOR	SEASON
C GDE QB QM QMU JA VERGR	2.5" CA 2.5" CA 2.5" CA 2.5" CA 2.5" CA	L 2 L 6 L 2 18 ES QUANTITY 2	QUERCUS MUEHLENBERGII ULMUS ACCOLADE	ACCOLADE ELM	50-70'	30-40'			·	

### CITY OF BOULDER LANDSCAPE NOTES:

1. LANDSCAPING SCHEDULE: (A) NOTHING SHALL BE PLANTED BETWEEN OCTOBER 15 AND MARCH 1 WITHOUT PRIOR WRITTEN APPROVAL OF THE CITY. STOCK, OTHER THAN CONTAINER-GROWN STOCK, SHALL NOT BE PLANTED BETWEEN JUNE 1 AND SEPTEMBER 1 WITHOUT PRIOR WRITTEN APPROVAL OF THE CITY. BARE ROOT STOCK SHALL NOT BE PLANTED AFTER APRIL 30 OR IF PLANTS HAVE BEGUN TO LEAF OUT. (B) NOTHING SHALL BE PLANTED DURING FREEZING OR EXCESSIVELY WINDY, HOT, OR WET WEATHER OR WHEN THE GROUND CONDITIONS CANNOT BE PROPERLY WORKED FOR DIGGING, MIXING, RAKING, OR GRADING. (C) NOTHING SHALL BE PLANTED UNTIL THE ADJACENT SITE IMPROVEMENTS, PAVEMENTS, IRRIGATION INSTALLATION AND FINISH GRADING IS COMPLETED. THE CONTRACTOR SHALL TEST THE IRRIGATION SYSTEM IN THE PRESENCE OF THE DIRECTOR. THE IRRIGATION SYSTEM SHALL BE IN APPROVED, OPERATING CONDITION PRIOR TO ANY PLANTING. 2. SITE PREPARATION AND ALL PLANTING SHALL BE COMPLETED, AT A MINIMUM, IN ACCORDANCE WITH THE CITY OF BOULDER DESIGN AND CONSTRUCTION STANDARDS. SITE PREPARATION SHALL INCLUDE TILLING THE SOIL TO A MINIMUM DEPTH OF SIX INCHES BELOW THE FINISHED GRADE, TOGETHER WITH SOIL AMENDMENTS

THAT ARE APPROPRIATE TO ENSURE THE HEALTH AND SUSTAINABILITY OF THE LANDSCAPING TO BE PLANTED. 3. TURF GRASS SHALL BE LIMITED TO A MAXIMUM OF 25 PERCENT OF ALL LANDSCAPE AREAS ON THE SITE. 4. ALL PLANTING BEDS AND A 3-FOOT DIAMETER RING AT THE BASE OF EACH TREE WITHIN SOD OR SEEDED AREAS SHALL BE MULCHED WITH ORGANIC MULCH AT LEAST 4" DEEP.

5. GRAVEL, ROCK MULCH, OR CRUSHER FINES SHALL NOT BE USED UNDER TREES OR ANY PLANTING AREAS. ROCK OR GRAVEL MAY ONLY BE USED AS A SPECIFIC ORNAMENTAL FEATURE IN LIMITED AREAS (SUCH AS AT THE BOTTOM OF A DRAINAGE SWALE OR DRY RIVER BED) OR AS A PEDESTRIAN PATH OR PATIO. 6. WEED BARRIER FABRIC SHALL NOT TO BE USED IN ANY PLANTING AREAS.

7. ALL PLANTS SHALL BE GROUPED BY WATER NEEDS. A MINIMUM OF 75 PERCENT OF ALL LANDSCAPED AREAS (INCLUDING ANY TURF GRASS) MUST USE LOW TO MODERATE WATER DEMAND PLANTS. THE LANDSCAPE SHALL BE DESIGNED SO THAT, AT MATURITY, NOT MORE THAN 10 PERCENT OF THE LANDSCAPED AREA IS EXPOSED MULCH.

8. ALL LANDSCAPE AREAS SHALL BE WATERED BY AN AUTOMATIC IRRIGATION SYSTEM. THE IRRIGATION SYSTEM MUST BE ZONED TO DELIVER DIFFERENT APPROPRIATE AMOUNTS OF WATER TO DIFFERENT PLANT ZONES. THE SITE SHOULD BE IRRIGATED WITH DRIP IRRIGATION, BUBBLER, OR MICRO-SPRAY SYSTEMS. ALL TREES WILL BE ZONED SEPARATELY FROM TURF GRASS. ALL IRRIGATION ZONES SHALL USE A SMART SYSTEM THAT ADJUSTS FOR RAINFALL, SOIL MOISTURE, AND OTHER WEATHER FACTORS.

9. PROTECTIVE MAINTENANCE: AN APPLICANT FOR CONSTRUCTION APPROVAL SHALL PROVIDE MAINTENANCE AND CARE FOR ALL EXISTING TREES REQUIRED TO BE PROTECTED IN THE PUBLIC RIGHT-OF-WAY ADJACENT TO ANY PROJECT OR CONSTRUCTION SITE DURING CONSTRUCTION ACTIVITIES AND THE PUBLIC IMPROVEMENT WARRANTY PERIOD TO ENSURE THAT EXISTING TREES SURVIVE AND ARE NOT DAMAGED. REFER TO CHAPTER 3 OF THE DESIGN AND CONSTRUCTION STANDARDS FOR ALL TREE PROTECTION REQUIREMENTS. (ONLY APPLICABLE TO EXISTING PUBLIC STREET TREES OR EXISTING PRIVATE TREES THAT WILL MEET THE STREET TREE REQUIREMENTS OF SECTION 9-9-13 BRC 1981) 10. ALL NEW TREES SHALL BE LOCATED A MINIMUM OF 10' FROM ANY EXISTING WATER OR SEWER UTILITY

LINES OR FROM LIGHT POLES OR OVERHEAD UTILITY POLES. ALL NEW UTILITY LINES SHALL BE LOCATED A MINIMUM OF 10' FROM ANY EXISTING PUBLIC STREET TREE.

### **OTHER LANDSCAPE NOTES:**

1. ALL PLANT MATERIAL SHALL MEET SPECIFICATIONS OF THE AMERICAN ASSOCIATION OF NURSERYMEN (AAN) FOR NUMBER ONE GRADE. ALL TREES SHALL BE BALLED AND BURLAPPED OR EQUIVALENT. ALL PLANT MATERIALS SHALL HAVE ALL WIRE, TWINE OR OTHER CONTAINMENT MATERIALS, EXCEPT FOR BURLAP, REMOVED FROM TRUNK AND ROOT BALL OF THE PLANT PRIOR TO PLANTING.

2. GRADES SHALL BE SET TO ALLOW FOR PROPER DRAINAGE AWAY FROM STRUCTURES. GRADES SHALL MAINTAIN SMOOTH PROFILES AND BE FREE OF SURFACE DEBRIS, BUMPS, AND DEPRESSIONS. 3. OWNERS SHALL ENSURE THAT THE LANDSCAPE PLAN IS COORDINATED WITH THE PLANS DONE BY OTHER CONSULTANTS SO THAT THE PROPOSED GRADING, STORM DRAINAGE, OR OTHER CONSTRUCTIONS DOES NOT

CONFLICT NOR PRECLUDE INSTALLATION AND MAINTENANCE OF LANDSCAPE ELEMENTS ON THIS PLAN. 4. ALL SHRUB BEDS ADJACENT TO TURF AREAS SHALL BE EDGED WITH ROLLED TOP STEEL EDGER.

5. ALL SHRUB BED AREAS, PERENNIALS AND GROUNDCOVER SHALL BE MULCHED WITH A 4" LAYER OF GORILLA HAIR MULCH. DO NOT USE WEED BARRIER FABRIC IN ANY OF THE LANDSCAPE BEDS.

6. PRIOR TO INSTALLATION OF PLANT MATERIALS, AREAS THAT HAVE BEEN COMPACTED OR DISTURBED BY CONSTRUCTION ACTIVITY SHALL BE THOROUGHLY LOOSENED; ORGANIC SOIL AMENDMENTS SHALL BE INCORPORATED AT THE RATE OF AT LEAST FOUR (4) CUBIC YARDS PER 1000 SQUARE FEET OF LANDSCAPE AREA. 7. PROVIDE 12" OF TOPSOIL IN ALL PLANTING AREAS THAT WERE PREVIOUSLY HARDSCAPE.

8. PLANTS ARE GROUPED BY WATER USE ZONE TO CONSERVE WATER. 9. CONTRACTOR SHALL VERIFY ALL MATERIAL QUANTITIES PRIOR TO INSTALLATION. ACTUAL NUMBER OF PLANT SYMBOLS SHALL HAVE PRIORITY OVER THE QUANTITY DESIGNATED. 10. REFER TO THE CITY OF BOULDER DESIGN AND CONSTRUCTION STREETSCAPING STANDARDS FOR ALL WORK WITHIN PUBLIC AREAS.

11. REFER TO THE CIVIL ENGINEER DRAWINGS FOR GRADING AND UTILITY INFORMATION. 12. REFER TO THE CITY OF BOULDER DESIGN AND CONSTRUCTION STANDARDS FOR TREE PROTECTION REQUIREMENTS.





Consultant

### CIVIL

THE SANITAS GROUP 901 FRONT STREET, SUITE 350 LOUISVILLE, CO 80027 T 303 481 2710

### ENTITLEMENTS **STUDIO ARCHITECTURE** 2995 55TH STREET, #17983 BOULDER, CO 80301

T 720 491 1167 LANDSCAPE

STUDIO TERRA INC. 758 CLUB CIRCLE LOUISVILLE, CO 80027 T 303 494 9138


STRUCTURAL ANTHEM STRUCTURAL ENGINEERS FLATIRON OFFICE PARK 2213 CENTRAL AVENUE BOULDER, CO 80301

T 303 848 8497 MEP **BRANCH PATTERN** 3344 WALNUT STREET DENVER, CO 80205 T 303 382 1920

LIGHTING **AE DESIGN** 1900 WAZEE STREET, #205 DENVER, CO 80202 T 303 296 3034

AV/TECHNOLOGY/SECURITY SALAS O'BRIEN 4900 NAUTILUS CT. N. SUITE 200 BOULDER, CO 80301 T 303 865 5500

Full Design Team Roster on Sheet A0.02 Client and Project Information

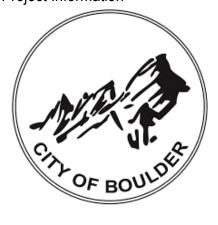

COB West Campus Parking Garage 2655 BROADWAY Boulder, CO 80302

Original Issue

Key Plan and Orientation

Revisions

Sheet Status

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Sheet Title


PLANT SCHEDULE

Sheet Number



Current Issue

Current Issue Date

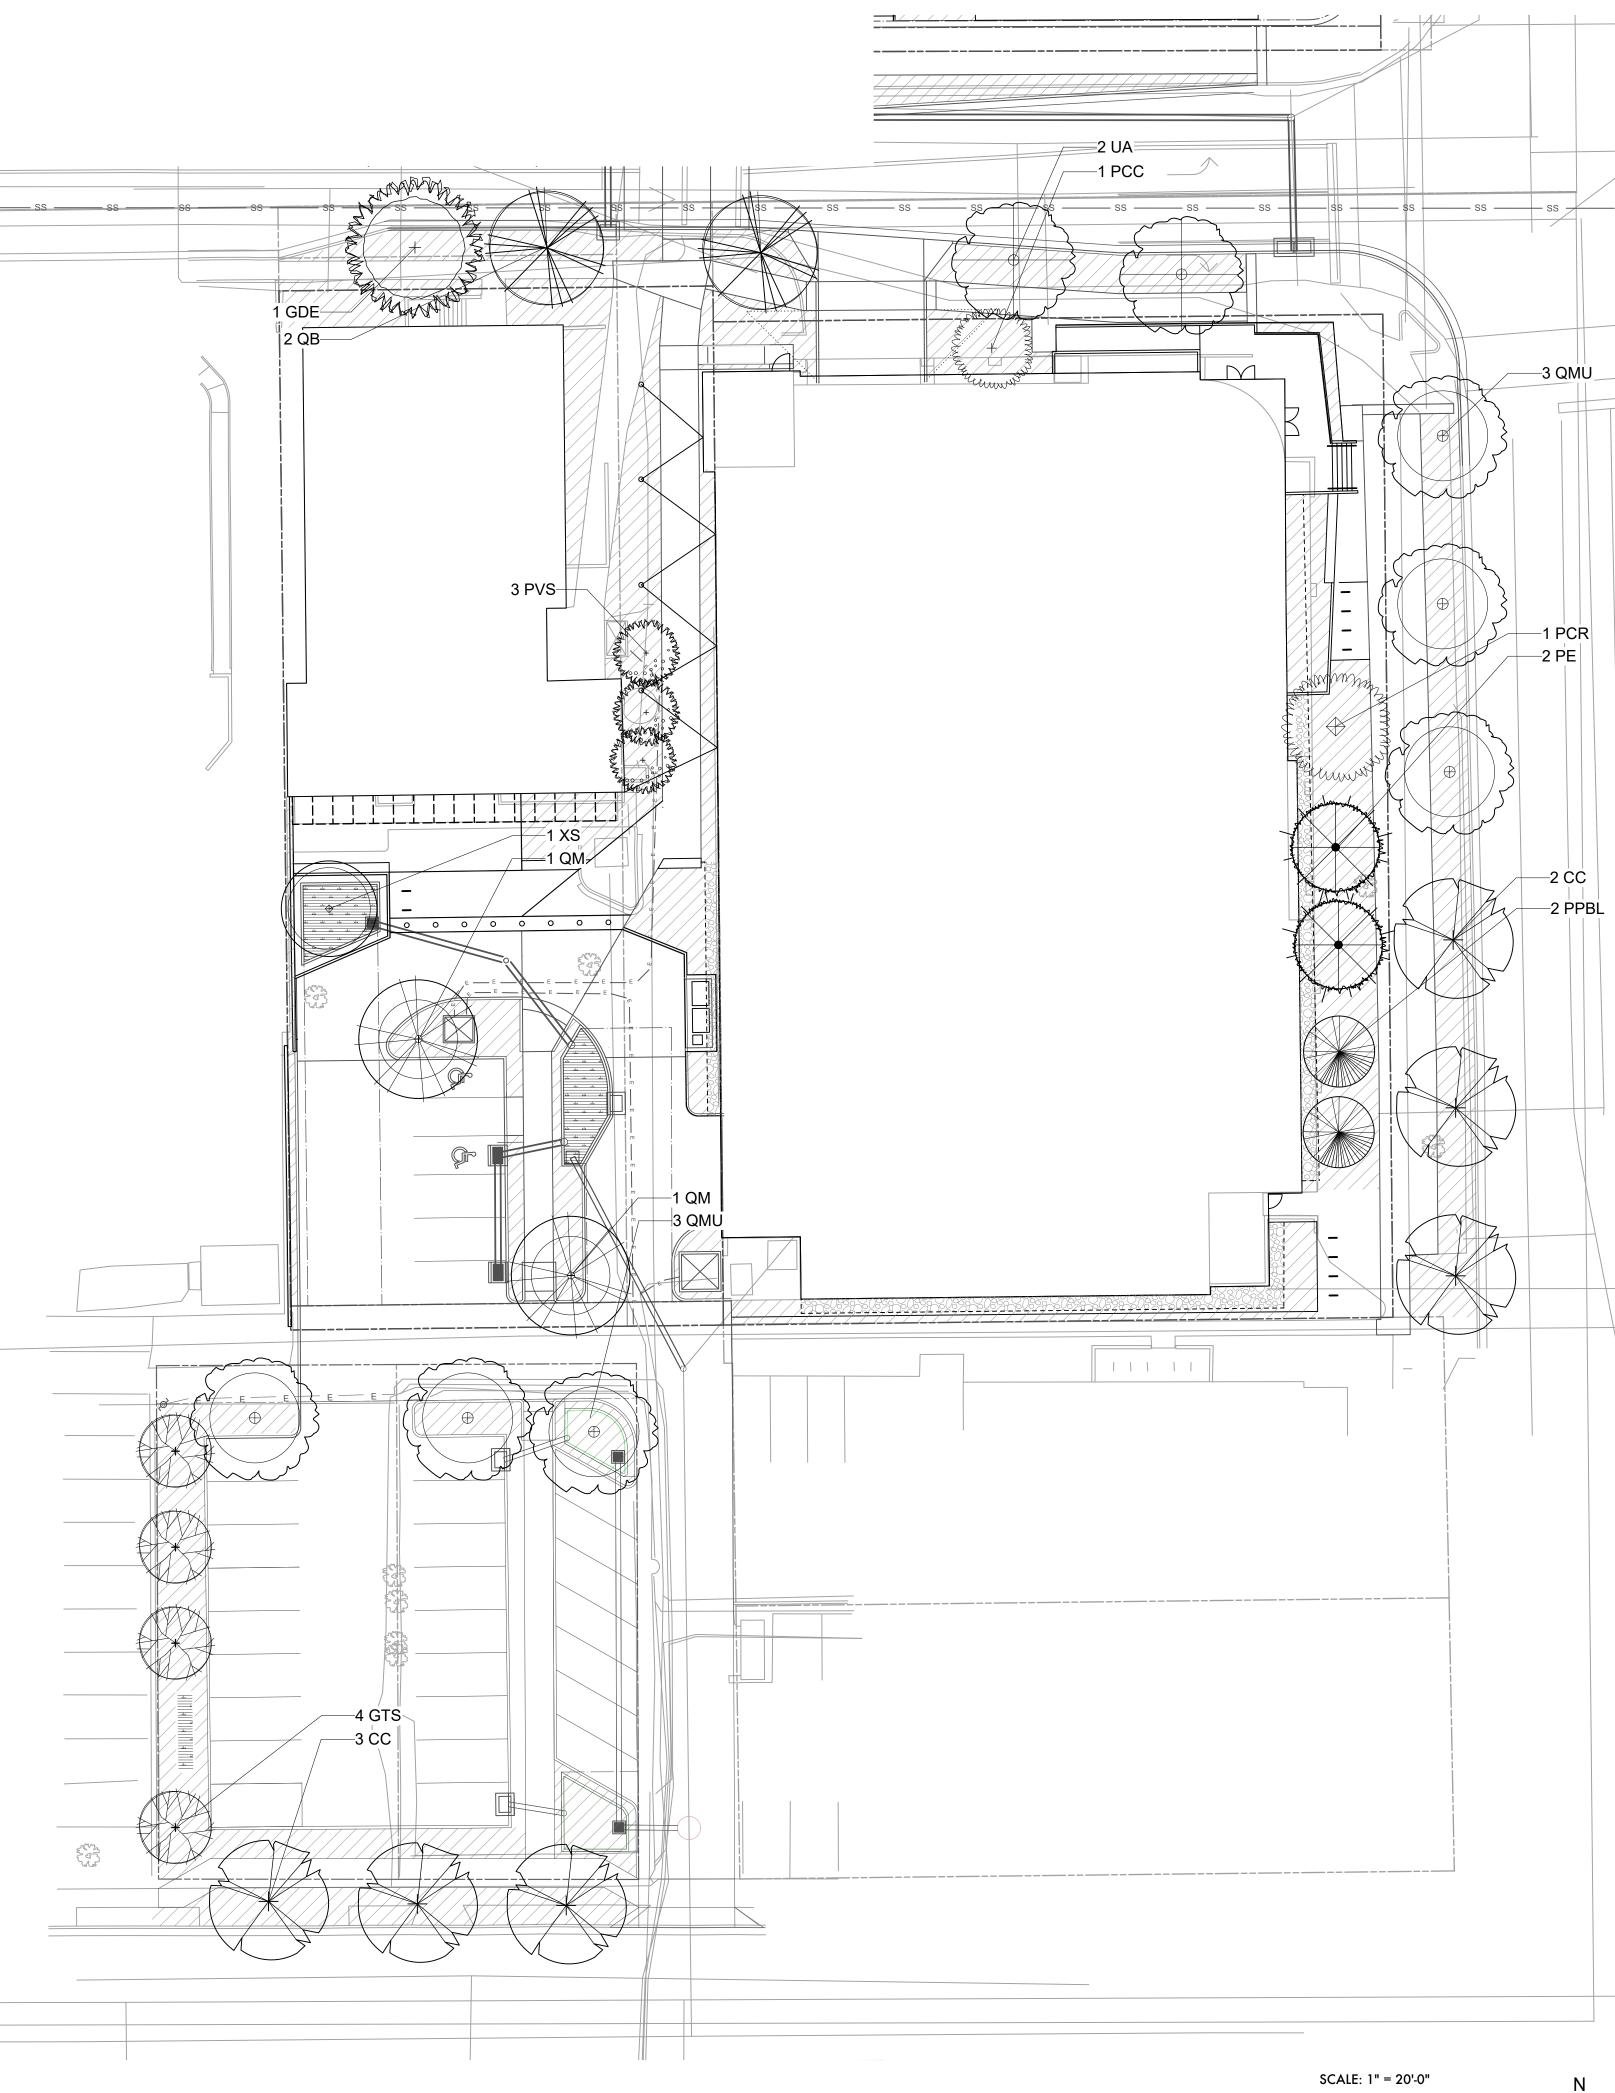

SCALE: 1" = 20'-0" 20 10 0 20 FT

### LEGEND



EXISTING TREE TO REMAIN

PLANTING BED - SHRUBS, ORN GRASSES, VINES, PERENNIALS -5 GAL SHRUBS, 1 GAL GRASSES AND PERENNIALS

PLANTING BED - WATER QUALITY PLANTINGS

ROCK MULCH

·---- LANDSCAPE EDGER

### TREE KEY

-3 QMU\_

–2 CC

-2 PPBL

ORNAMENTAL TREES								
KEY	SIZE	BOTANICAL NAME	COMMON NAME					
GTS	2.0" CAL	. GLEDITSIA TRIACANTHOS STREET KEEPEF	STREET KEEPER HONEYLOCUST					
PVS	2.0" CAL	. PRUNUS VIRGINIANA 'SHUBERT'	SHUBERT OR CANADA RED CHOKE					
PCR	2.0" CAL	. PYRUS CALLERYANA 'REDSPIRE'	REDSPIRE PEAR					
XS	2.0" CAL	XANTHOCERAS SORBIFOLIA	YELLOWHORN					
SHAD	E TREES							
KEY	SIZE	BOTANICAL NAME	COMMON NAME					
CC	2.5" CAL	CORYLUS COLURNA	TURKISH FILBERT					
GDE	2.5" CAL	GYMNOCLADUS DIOICUS 'ESPRESSO'	SEEDLESS KENTUCKY COFFEETREE					
QB	2.5" CAL	QUERCUS BICOLOR	SWAMP WHITE OAK					
QM	2.5" CAL	QUERCUS MACROCARPA	BUR OAK					
QMU	2.5" CAL	QUERCUS MUEHLENBERGII	CHINKAPIN OAK					
UA	2.5" CAL	ULMUS ACCOLADE	ACCOLADE ELM					
EVERC	GREEN TF	REES						
KEY	SIZE	BOTANICAL NAME	COMMON NAME					
PPBL	6 FT.	PICEA PUNGENS 'BLUE TOTEM'	FASTIGIATE SPRUCE					
PE	6 FT.	PINUS EDULIS	PINON PINE					

### SIGHT TRIANGLE NOTES: PER BOULDER REVISED CODE 9-9-7(B):

OBSTRUCTION PROHIBITED: NO PERSON SHALL PLACE OR MAINTAIN ANY STRUCTURES, FENCES, LANDSCAPING, OR ANY OTHER OBJECTS WITHIN ANY SIGHT TRIANGLE AREA DESCRIBED IN SUBSECTION (C) OF THIS SECTION THAT OBSTRUCTS OR OBSCURES SIGHT DISTANCE VISIBILITY THROUGH SUCH STRUCTURES, FENCING, LANDSCAPING, OR OTHER OBJECTS BY MORE THAN TWENTY-FIVE PERCENT OF THE TOTAL VIEW IN THE VERTICAL PLANE ABOVE THE SIGHT TRIANGLE AREA BETWEEN A HEIGHT OF THIRTY INCHES AND NINETY-SIX INCHES ABOVE THE ROADWAY SURFACE, EXCEPT FOR THE FOLLOWING:

(1) LANDSCAPING, STRUCTURES, OR FENCES THAT PROTRUDE NO MORE THAN THIRTY INCHES ABOVE THE ADJACENT ROADWAY SURFACE MAY BE PERMITTED WITHIN THE SIGHT TRIANGLE AREA. (2) TREES MAY BE PLANTED AND MAINTAINED WITHIN THE SIGHT

TRIÁNGLE AREA IF ALL BRANCHES ARE TRIMMED TO MAINTAIN A CLEAR VISION FOR A VERTICAL HEIGHT OF NINETY-SIX INCHES ABOVE THE ROADWAY SURFACE AND THE LOCATION OF THE TREES PLANTED, BASED ON THE TREE SPECIES EXPECTED MATURE HEIGHT AND SIZE, DOES NOT OBSTRUCT SIGHT VISIBILITY BY MORE THAN TWENTY-FIVE PERCENT OF THE SIGHT TRIANGLE AREA.





Consultant

### CIVIL

THE SANITAS GROUP 901 FRONT STREET, SUITE 350 LOUISVILLE, CO 80027 T 303 481 2710

### ENTITLEMENTS STUDIO ARCHITECTURE 2995 55TH STREET, #17983 BOULDER, CO 80301 T 720 491 1167

LANDSCAPE STUDIO TERRA INC. 758 CLUB CIRCLE

LOUISVILLE, CO 80027 T 303 494 9138

STRUCTURAL ANTHEM STRUCTURAL ENGINEERS FLATIRON OFFICE PARK 2213 CENTRAL AVENUE BOULDER, CO 80301

T 303 848 8497 MEP **BRANCH PATTERN** 3344 WALNUT STREET DENVER, CO 80205 T 303 382 1920

LIGHTING **AE DESIGN** 1900 WAZEE STREET, #205 DENVER, CO 80202 T 303 296 3034

AV/TECHNOLOGY/SECURITY SALAS O'BRIEN 4900 NAUTILUS CT. N. SUITE 200 BOULDER, CO 80301 T 303 865 5500

Full Design Team Roster on Sheet A0.02 Client and Project Information



COB West Campus Parking Garage 2655 BROADWAY Boulder, CO 80302

Original Issue

Key Plan and Orientation

Revisions

Sheet Status

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Sheet Title


LANDSCAPE PLAN

Sheet Number



Current Issue

Current Issue Date

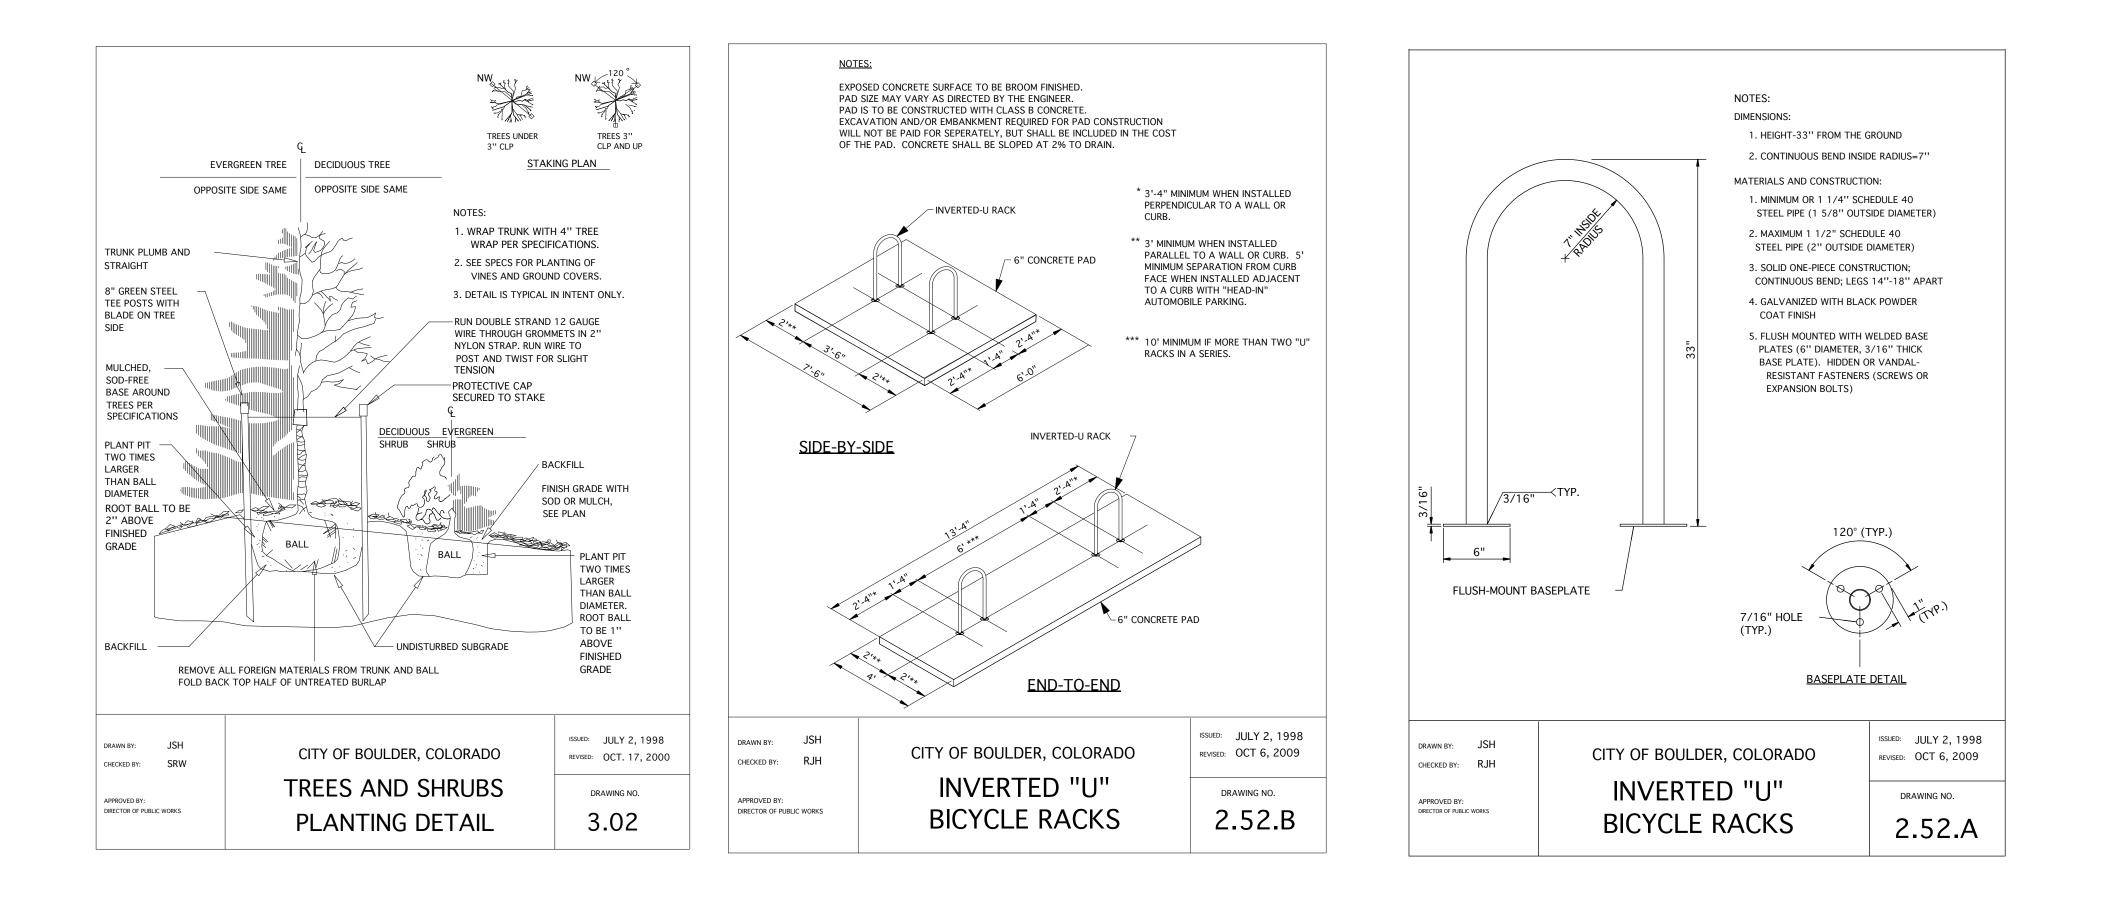





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### CIVIL

THE SANITAS GROUP 901 FRONT STREET, SUITE 350 LOUISVILLE, CO 80027 T 303 481 2710

### ENTITLEMENTS STUDIO ARCHITECTURE 2995 55TH STREET, #17983 BOULDER, CO 80301 T 720 491 1167

LANDSCAPE STUDIO TERRA INC. 758 CLUB CIRCLE LOUISVILLE, CO 80027

T 303 494 9138 STRUCTURAL

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Full Design Team Roster on Sheet A0.02 Client and Project Information

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COB West Campus Parking Garage 2655 BROADWAY Boulder, CO 80302

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PLANTING DETAILS


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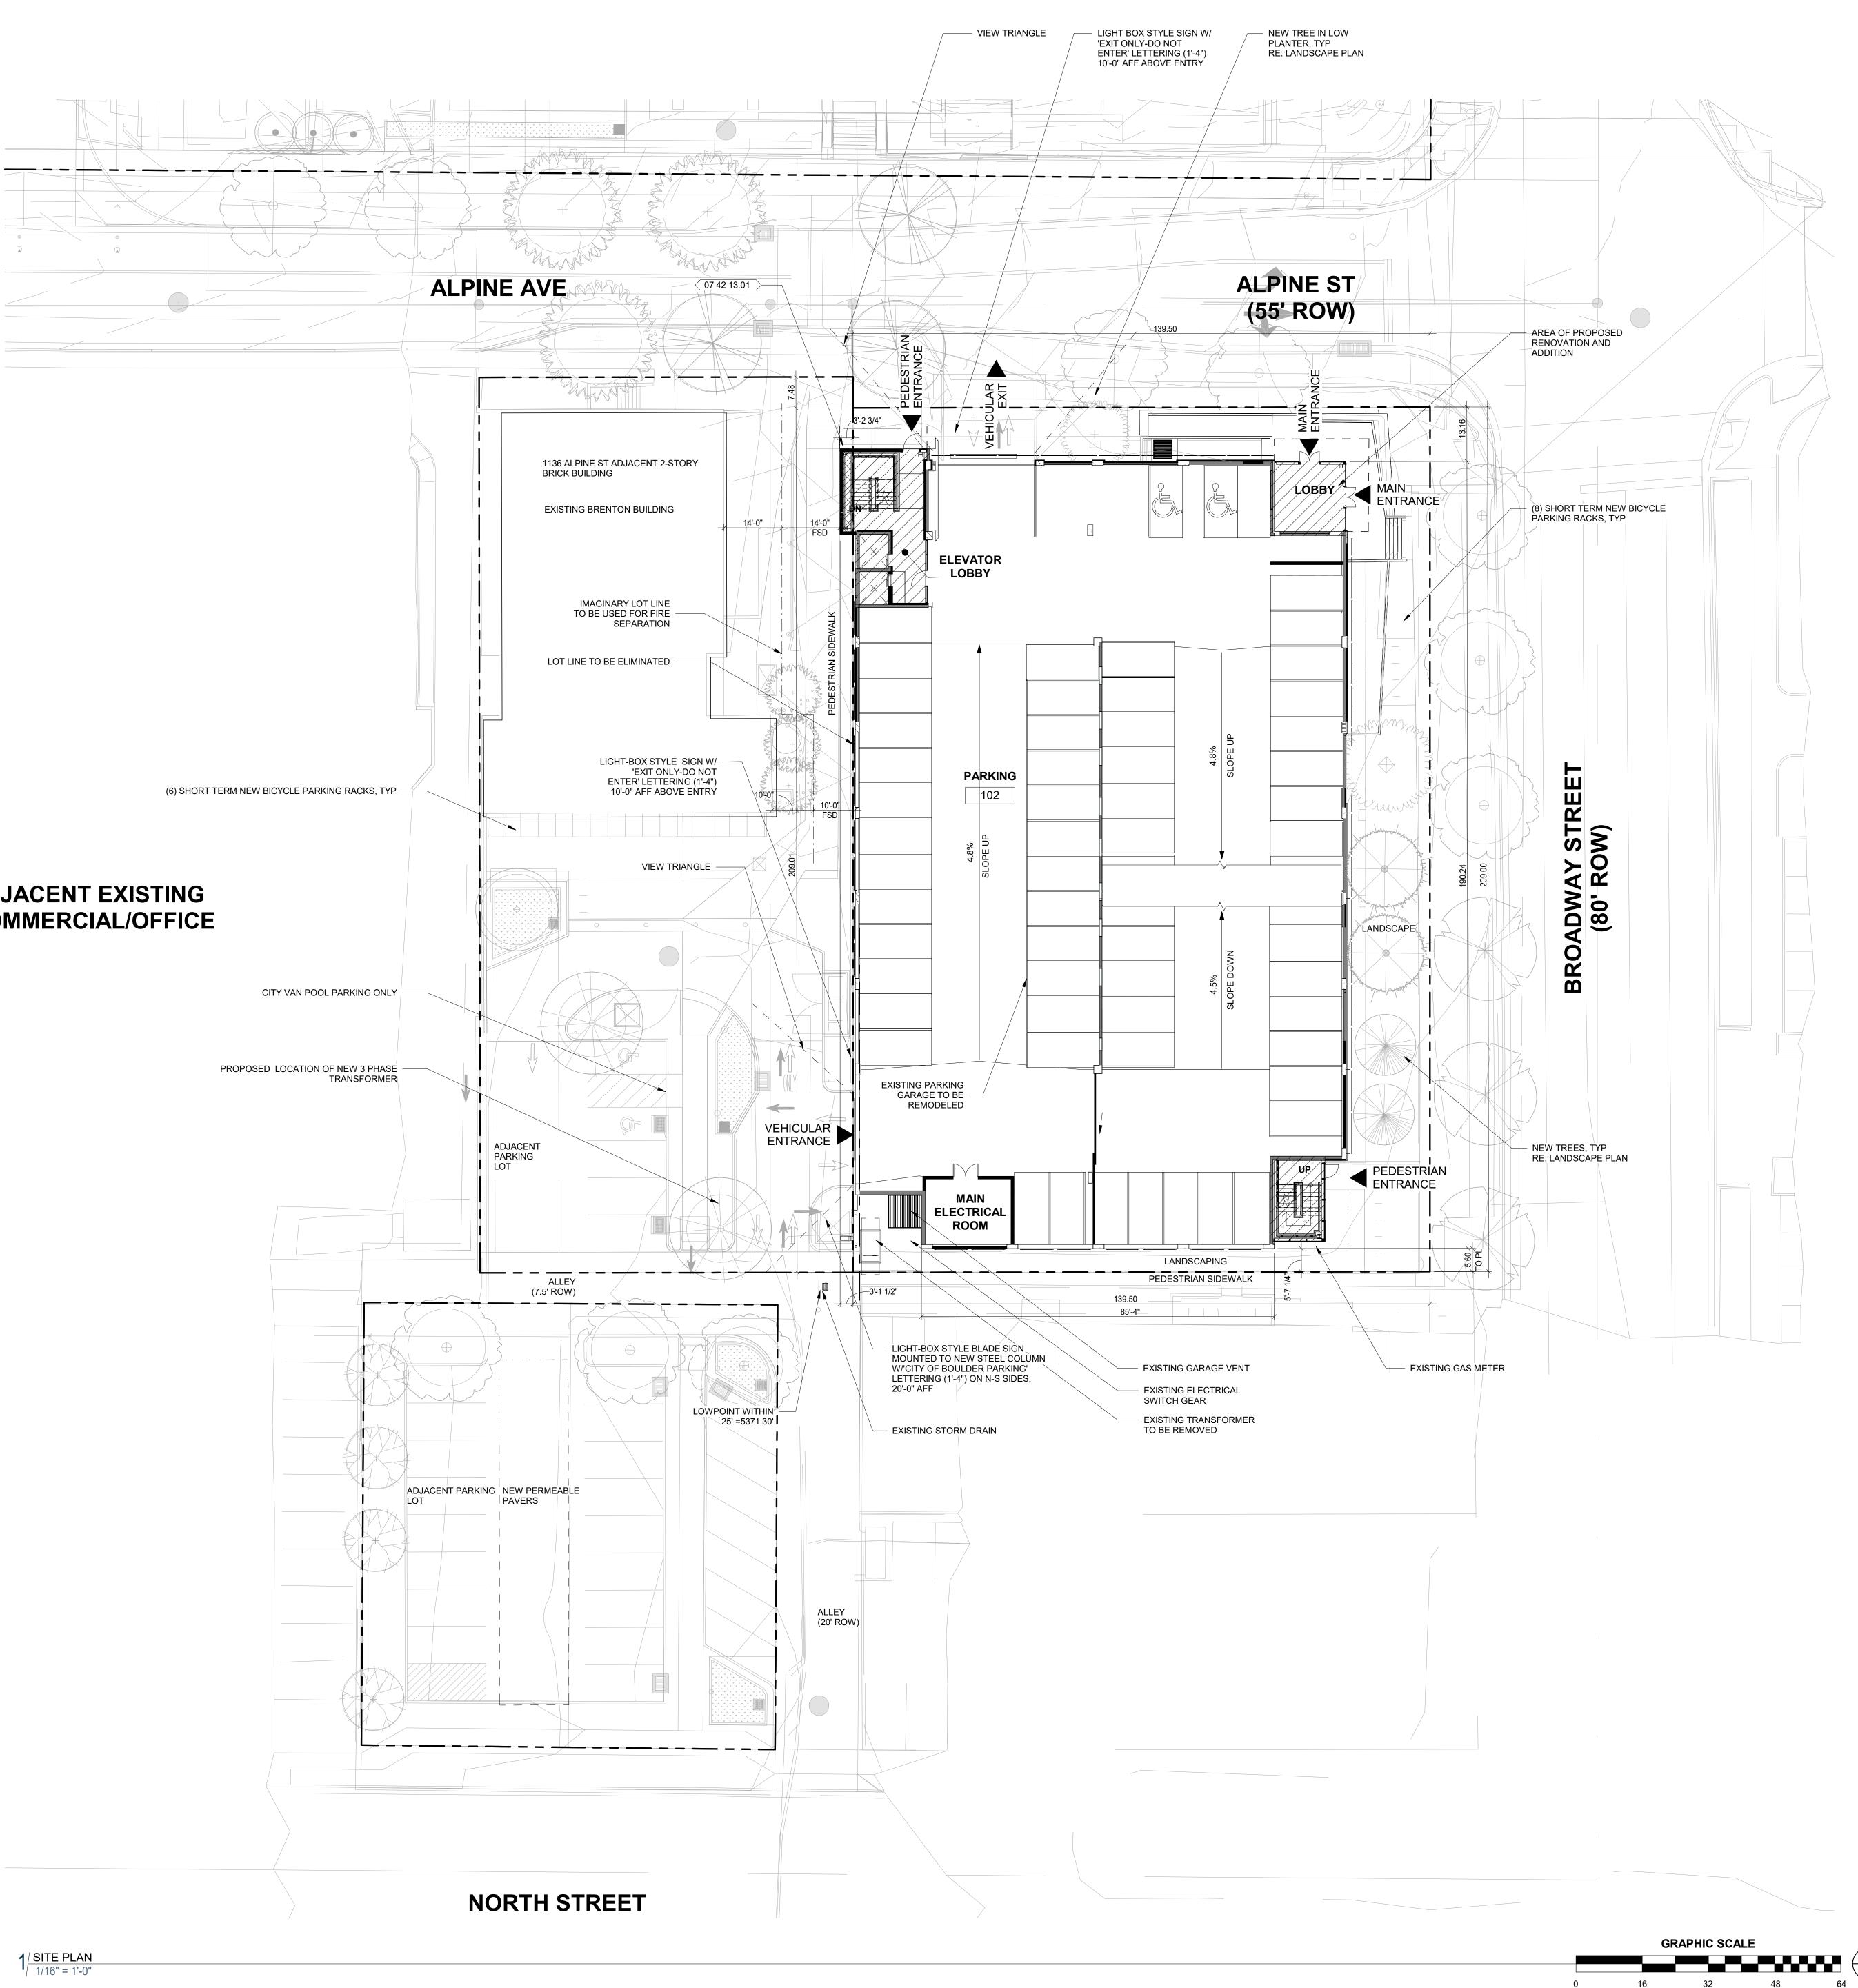


Current Issue SITE REVIEW

Current Issue Date 03/01/2023







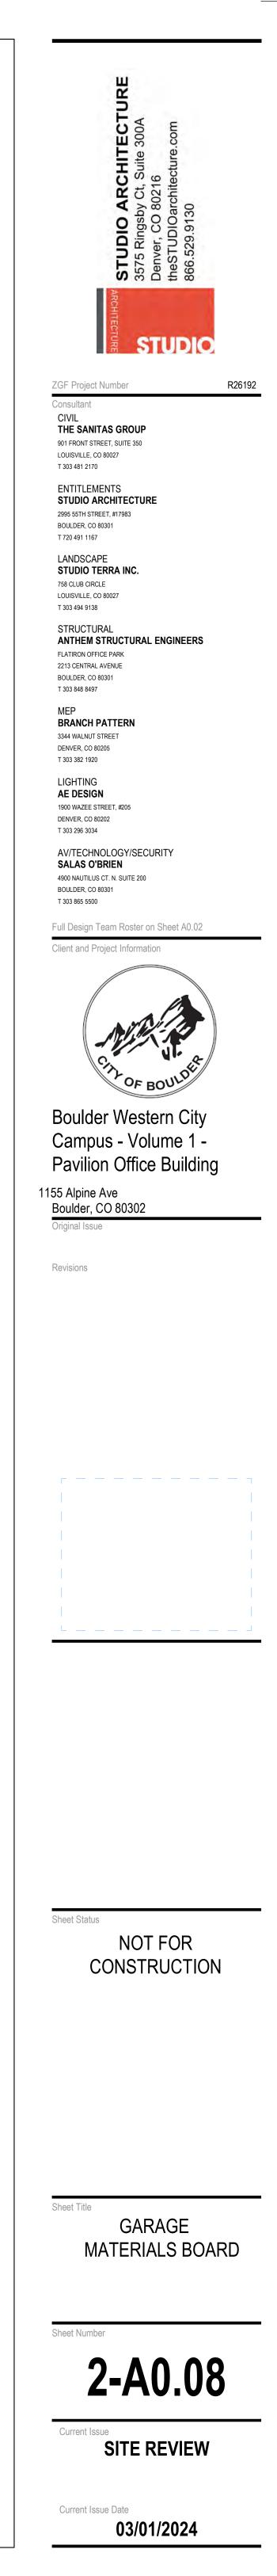



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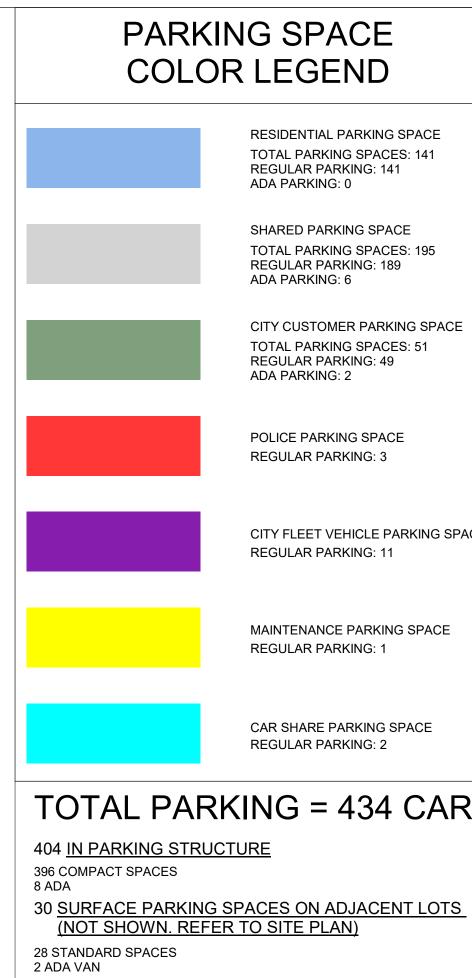
	<b>STUDIO ARCHITECTURE</b> 3575 Ringsby Ct, Suite 300A Denver, CO 80216 theSTUDIOarchitecture.com	866.529.9130	
COF Project N Consultant CIVIL THE SANIT. 901 FRONT STRE	AS GROUP		R26192
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LIGHTING AE DESIGN 1900 WAZEE STF DENVER, CO 802 T 303 296 3034	REET, #205		
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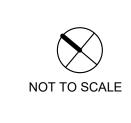




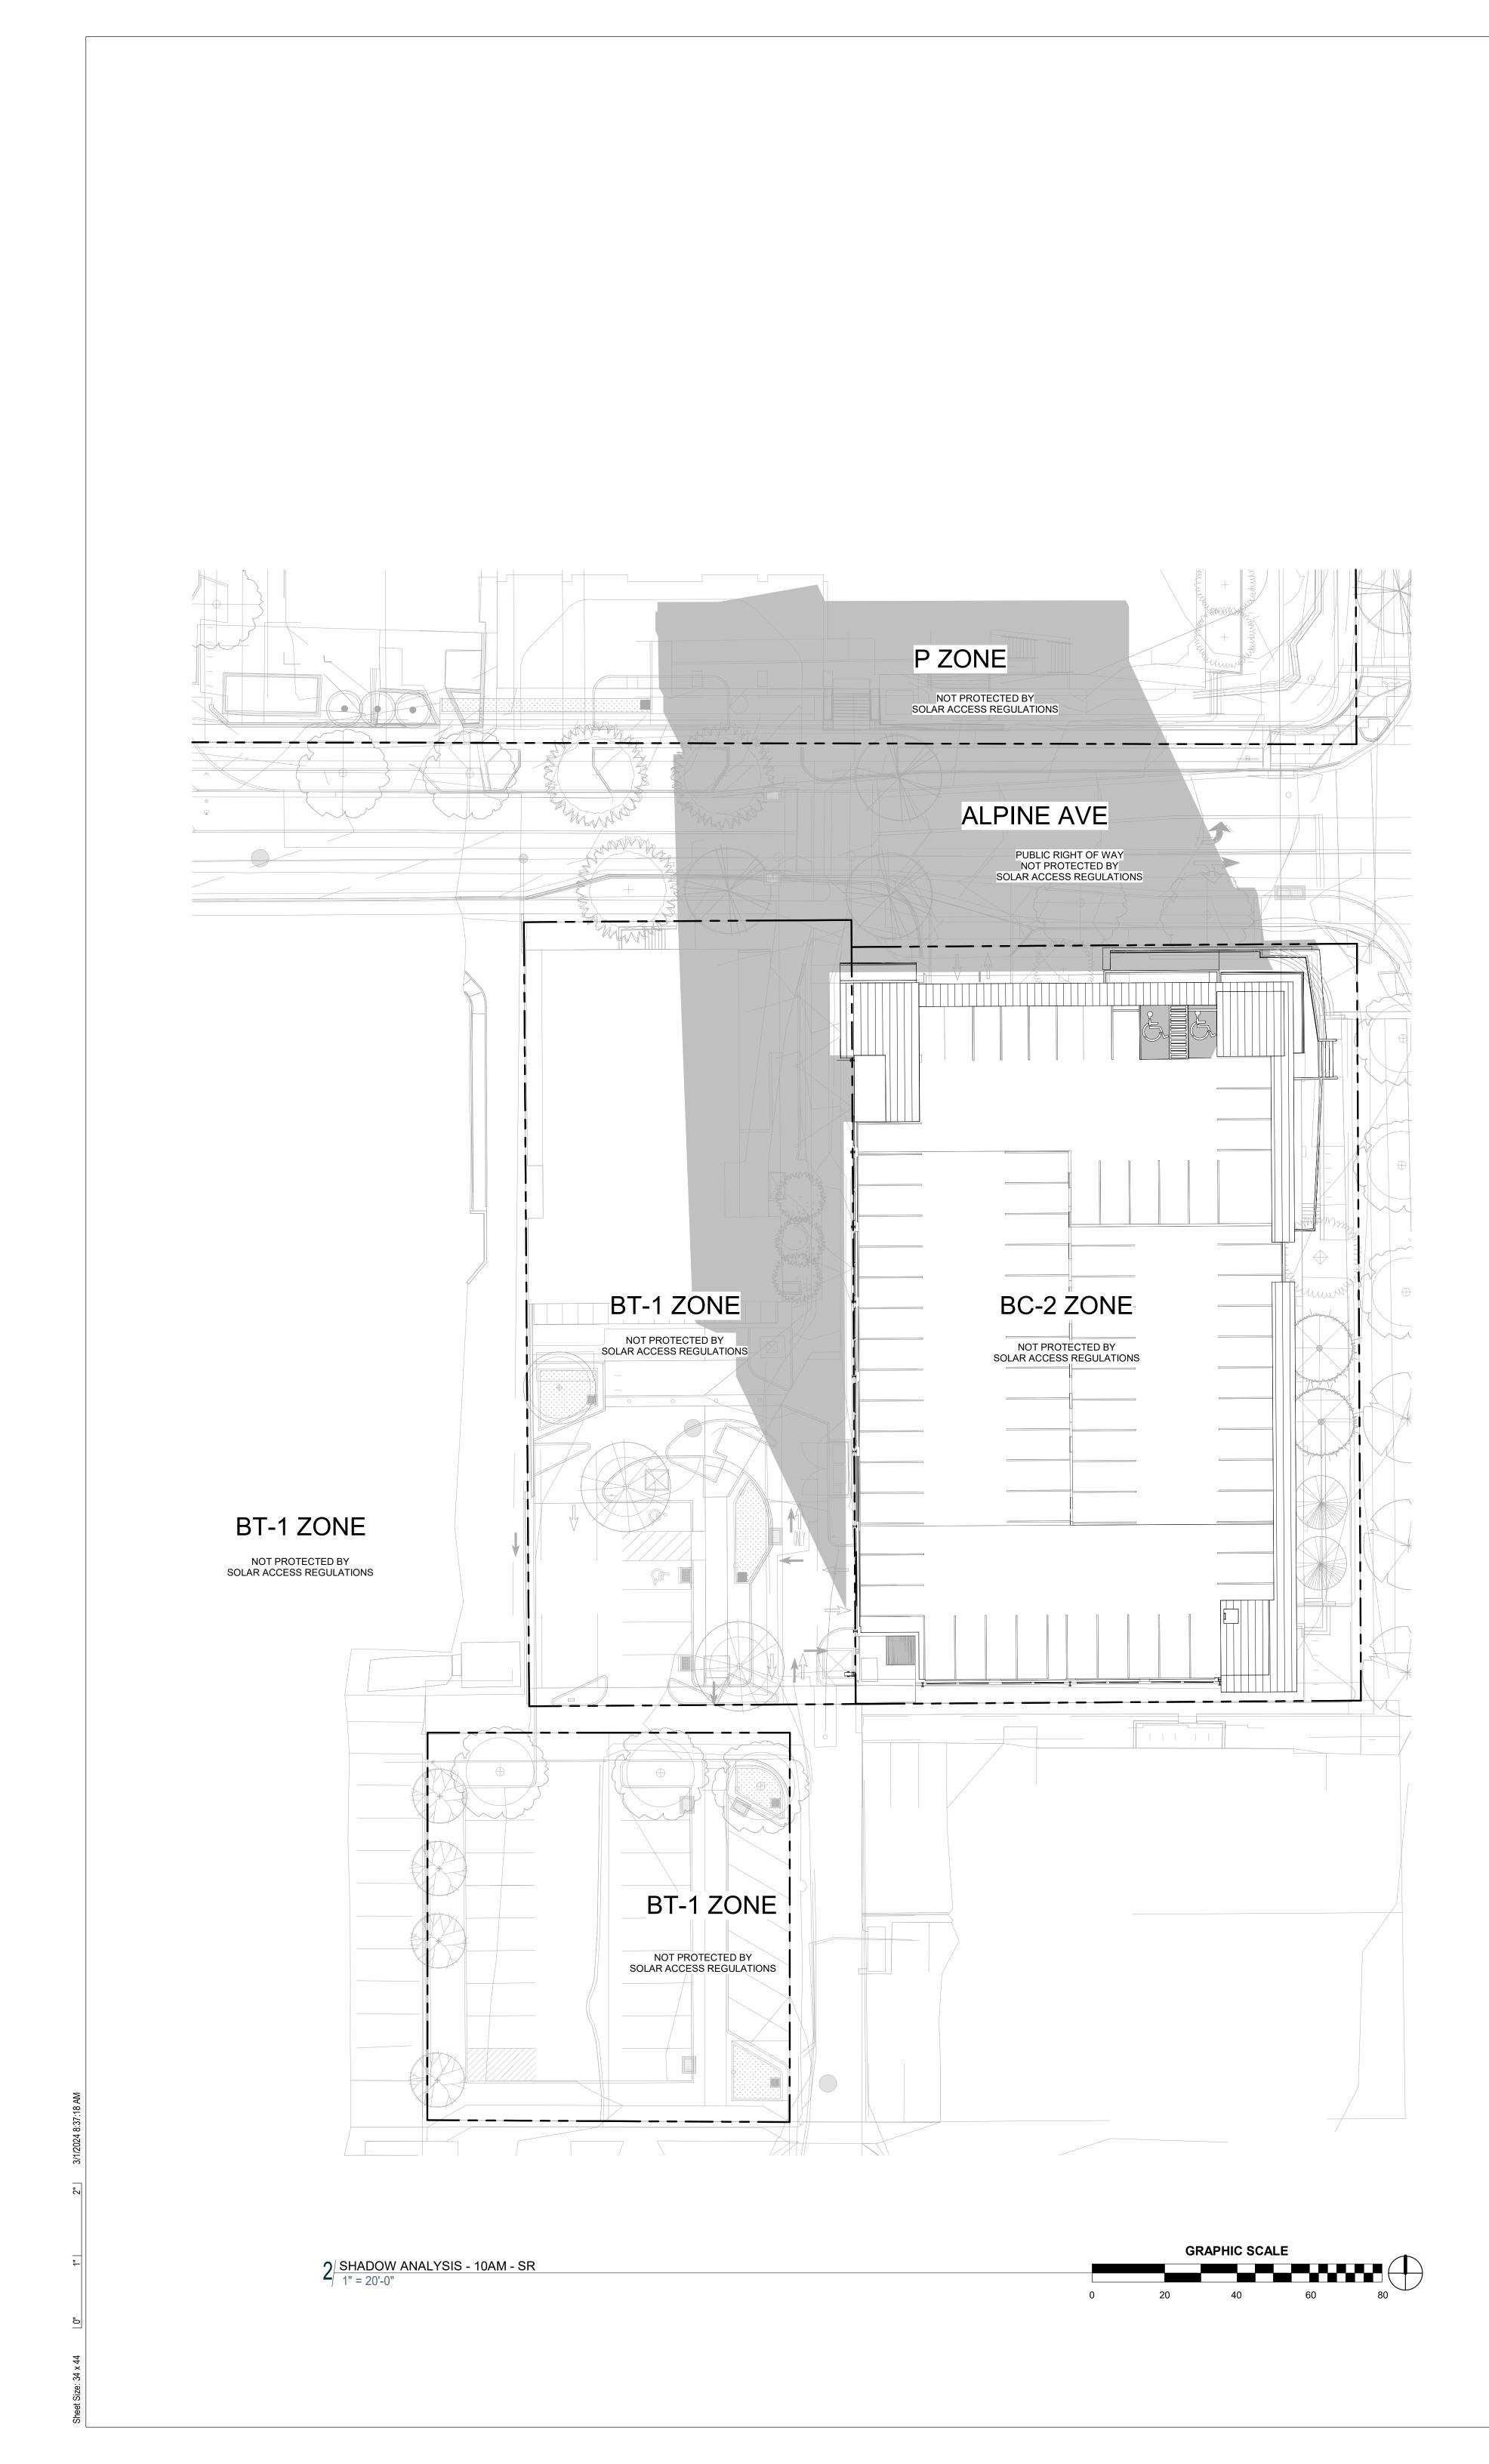

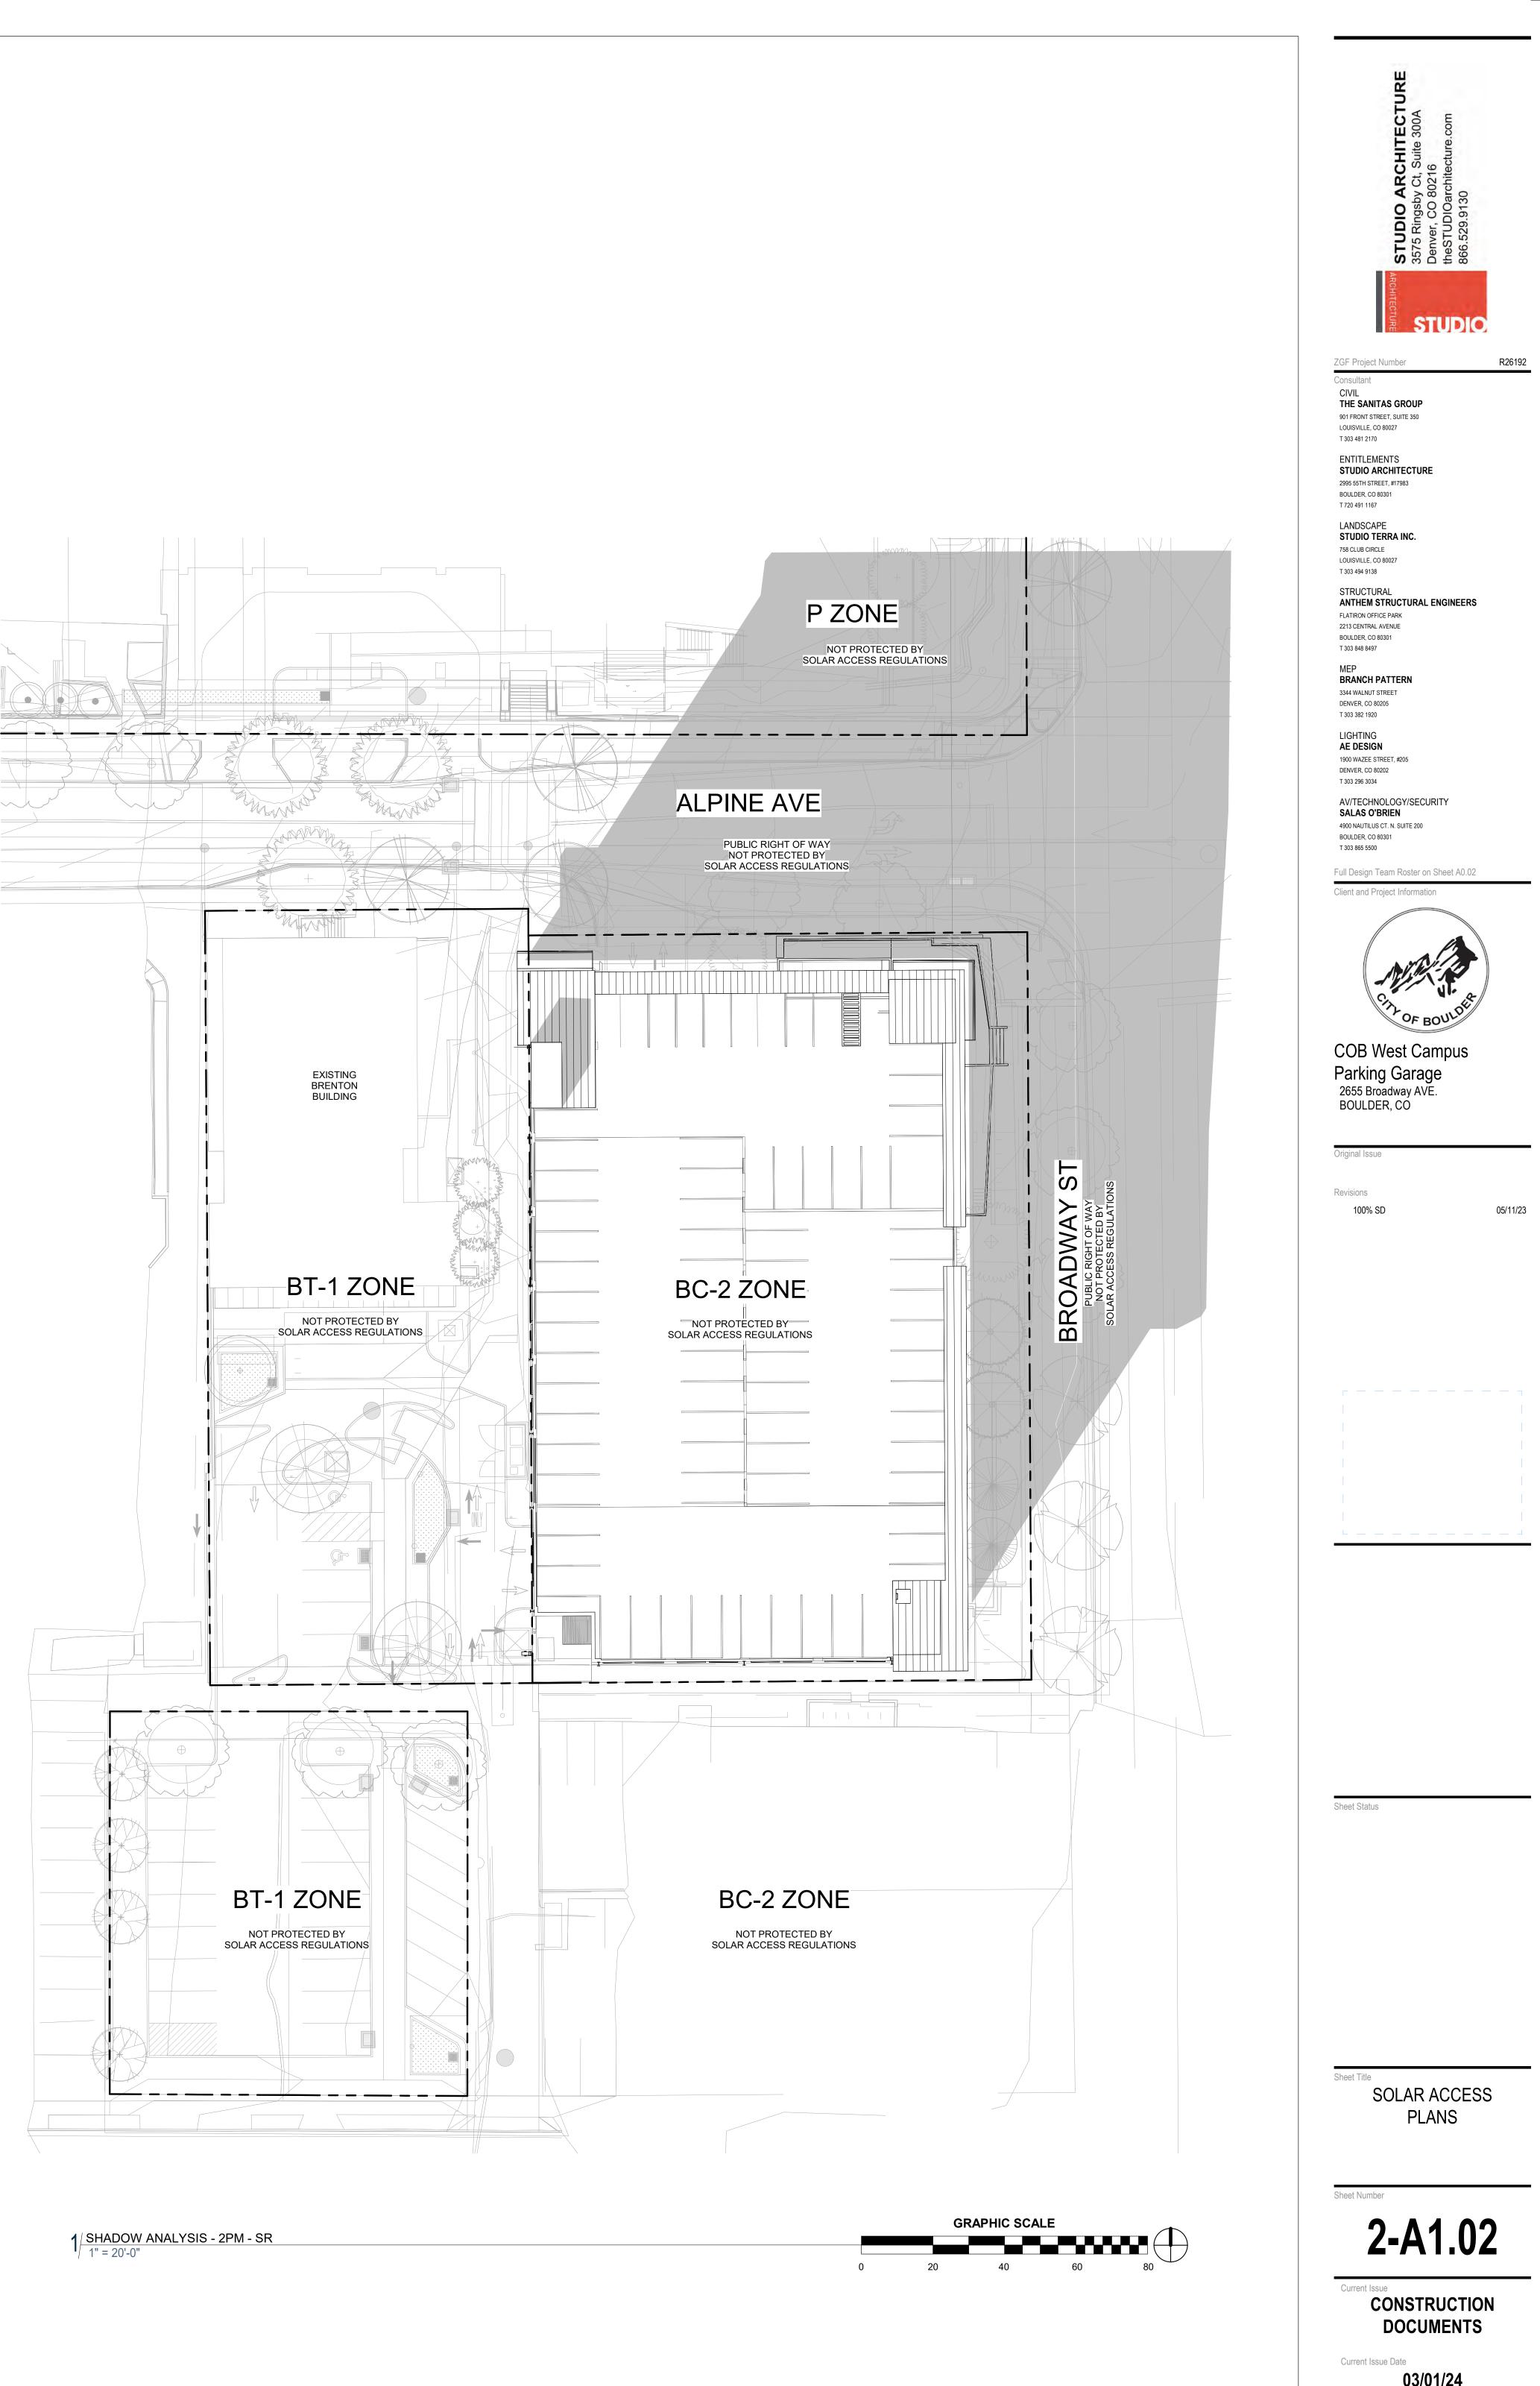

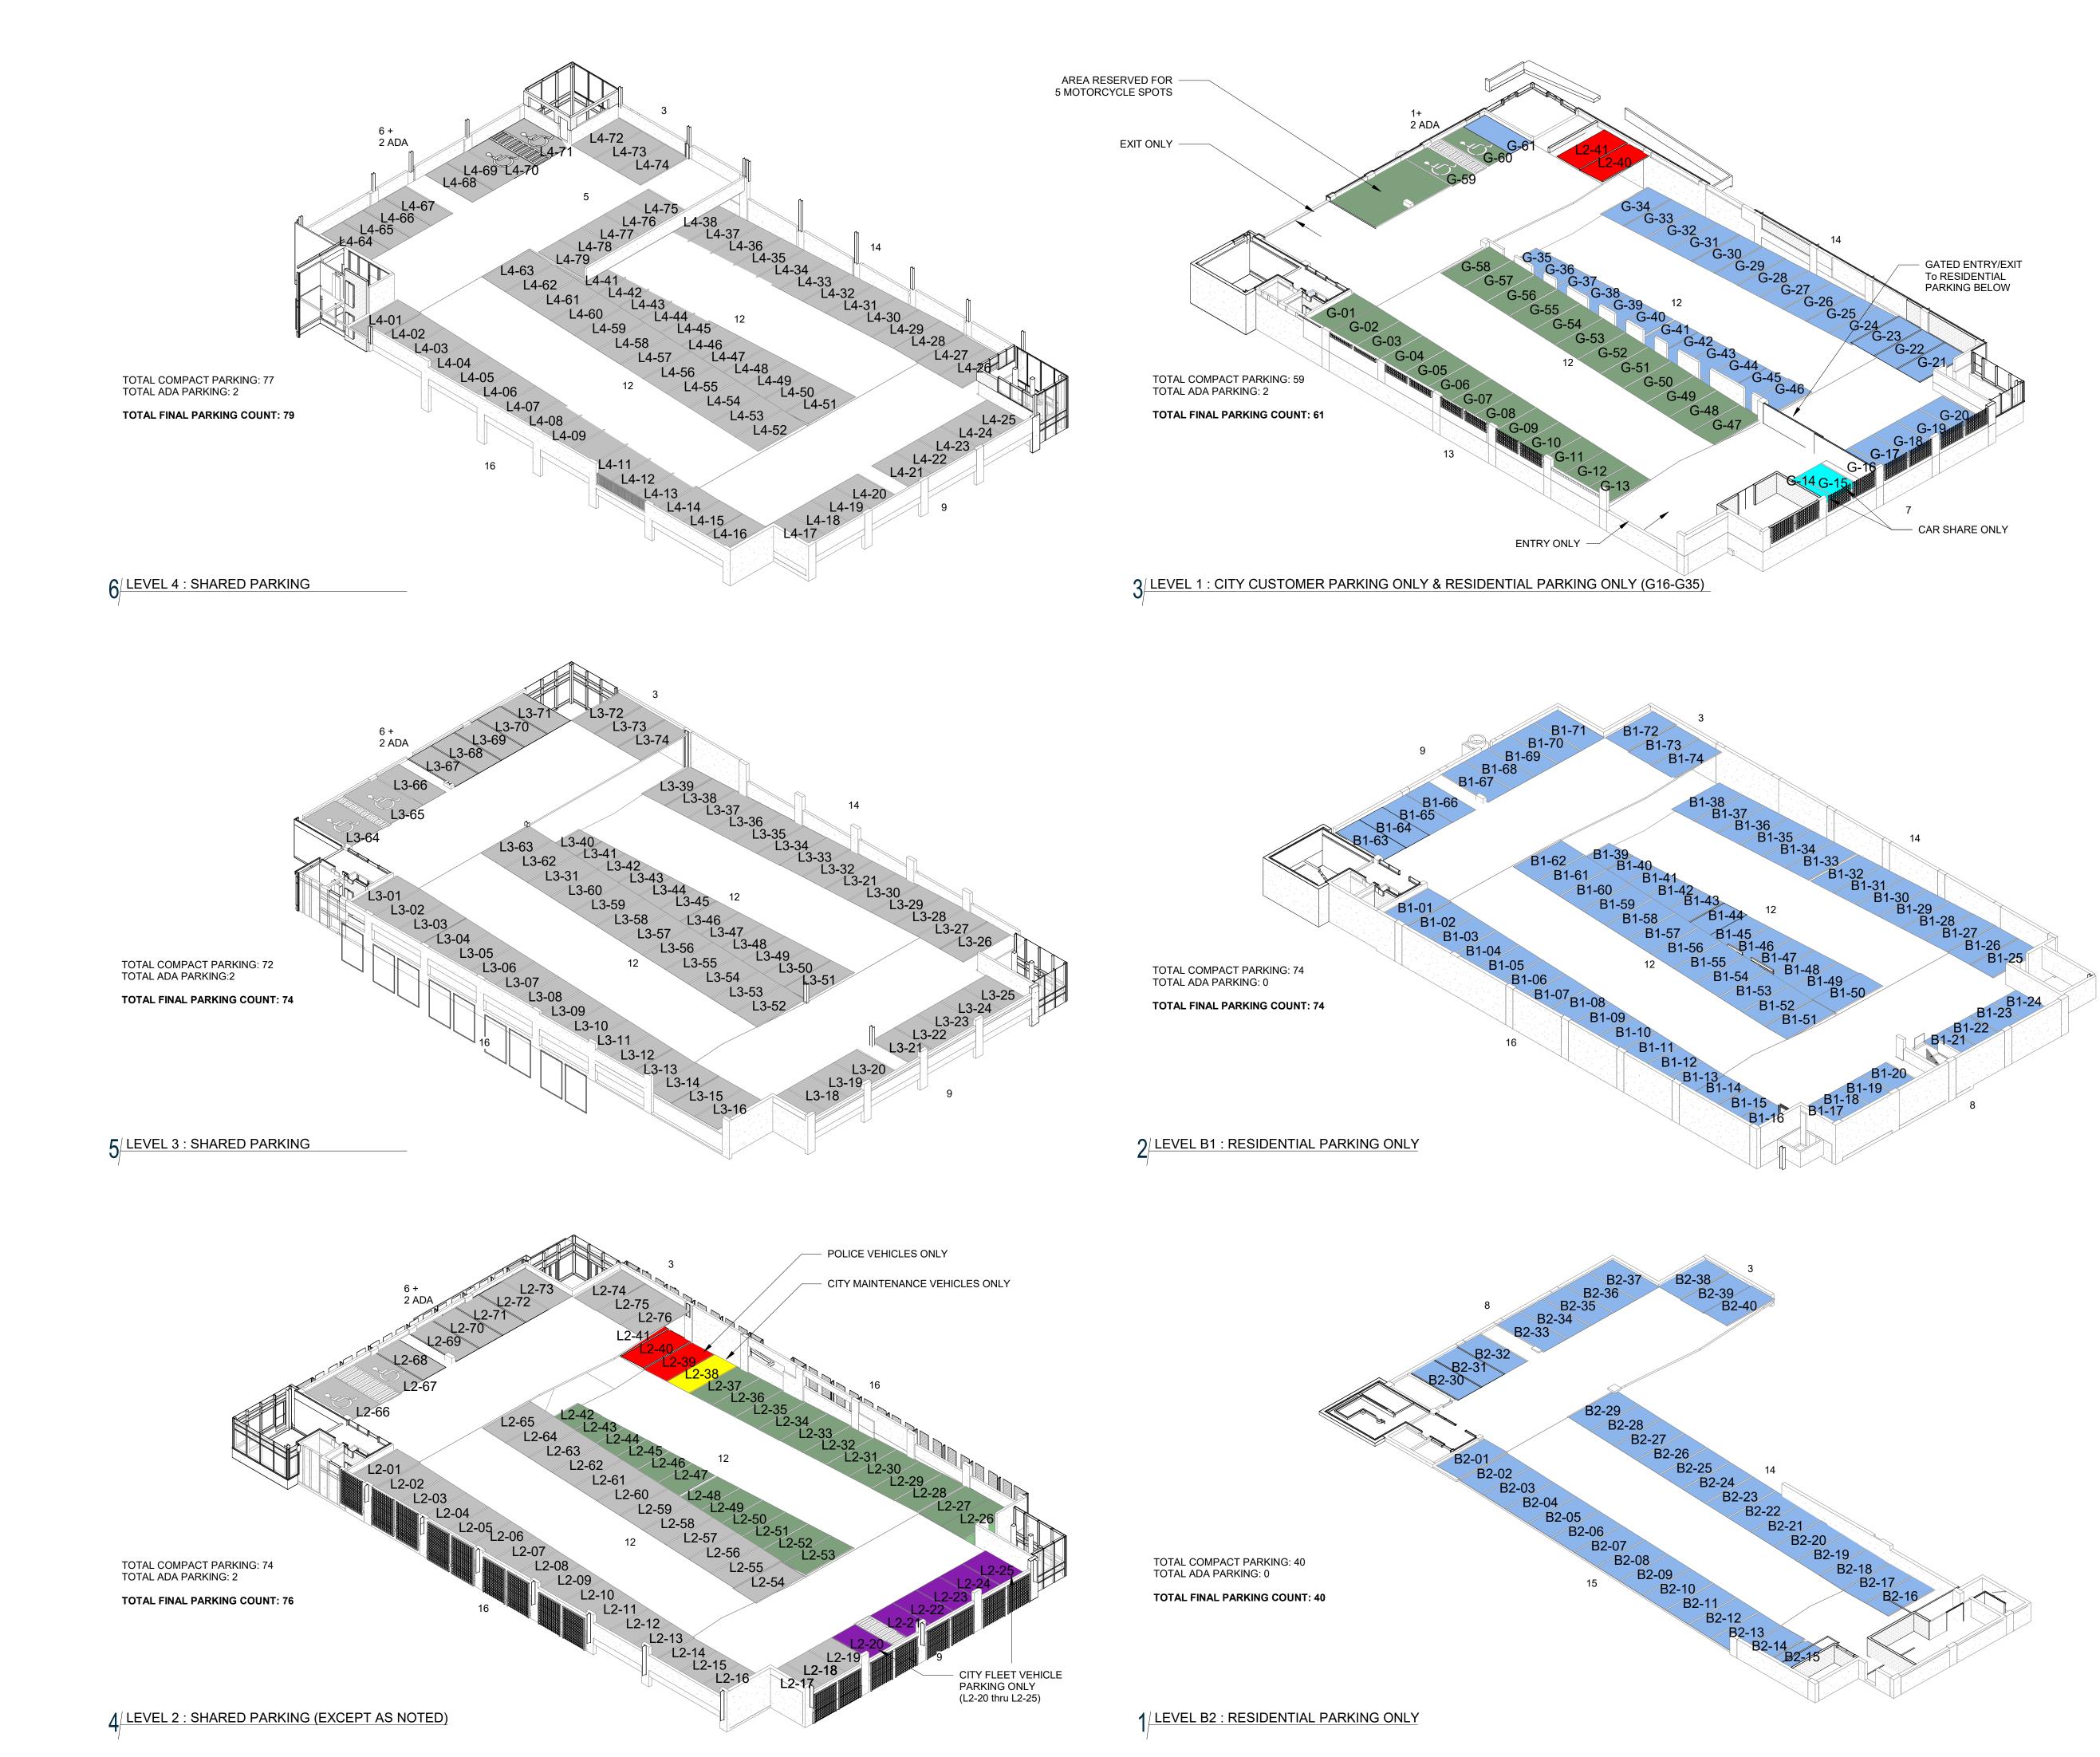

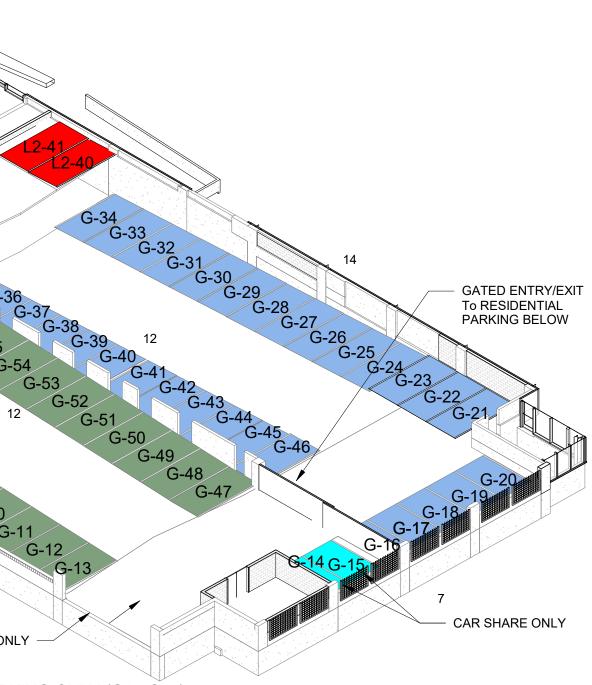

### PARKING SPACE COLOR LEGEND

RESIDENTIAL PARKING SPACE TOTAL PARKING SPACES: 141 REGULAR PARKING: 141 ADA PARKING: 0

SHARED PARKING SPACE TOTAL PARKING SPACES: 195 REGULAR PARKING: 189 ADA PARKING: 6

CITY CUSTOMER PARKING SPACE TOTAL PARKING SPACES: 51 REGULAR PARKING: 49 ADA PARKING: 2

POLICE PARKING SPACE **REGULAR PARKING: 3** 

CITY FLEET VEHICLE PARKING SPACE REGULAR PARKING: 11

MAINTENANCE PARKING SPACE **REGULAR PARKING: 1** 

CAR SHARE PARKING SPACE REGULAR PARKING: 2

### TOTAL PARKING = 434 CARS



ZGF Project Number Consultant

CIVIL The sanitas group 901 FRONT STREET, SUITE 350 LOUISVILLE, CO 80027 T 303 481 2170

ENTITLEMENTS STUDIO ARCHITECTURE 2995 55TH STREET, #17983 BOULDER, CO 80301 T 720 491 1167

LANDSCAPE STUDIO TERRA INC. 758 CLUB CIRCLE LOUISVILLE, CO 80027 T 303 494 9138

STRUCTURAL ANTHEM STRUCTURAL ENGINEERS FLATIRON OFFICE PARK 2213 CENTRAL AVENUE BOULDER, CO 80301

MEP BRANCH PATTERN 3344 WALNUT STREET DENVER, CO 80205 T 303 382 1920

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LIGHTING AE DESIGN 1900 WAZEE STREET, #205 DENVER, CO 80202 T 303 296 3034

AV/TECHNOLOGY/SECURITY SALAS O'BRIEN 4900 NAUTILUS CT. N. SUITE 200 BOULDER, CO 80301 T 303 865 5500

Full Design Team Roster on Sheet A0.02

COB West Campus Parking Garage 2655 Broadway AVE. BOULDER, CO

Revisions

Sheet Title PARKING DIAGRAMS


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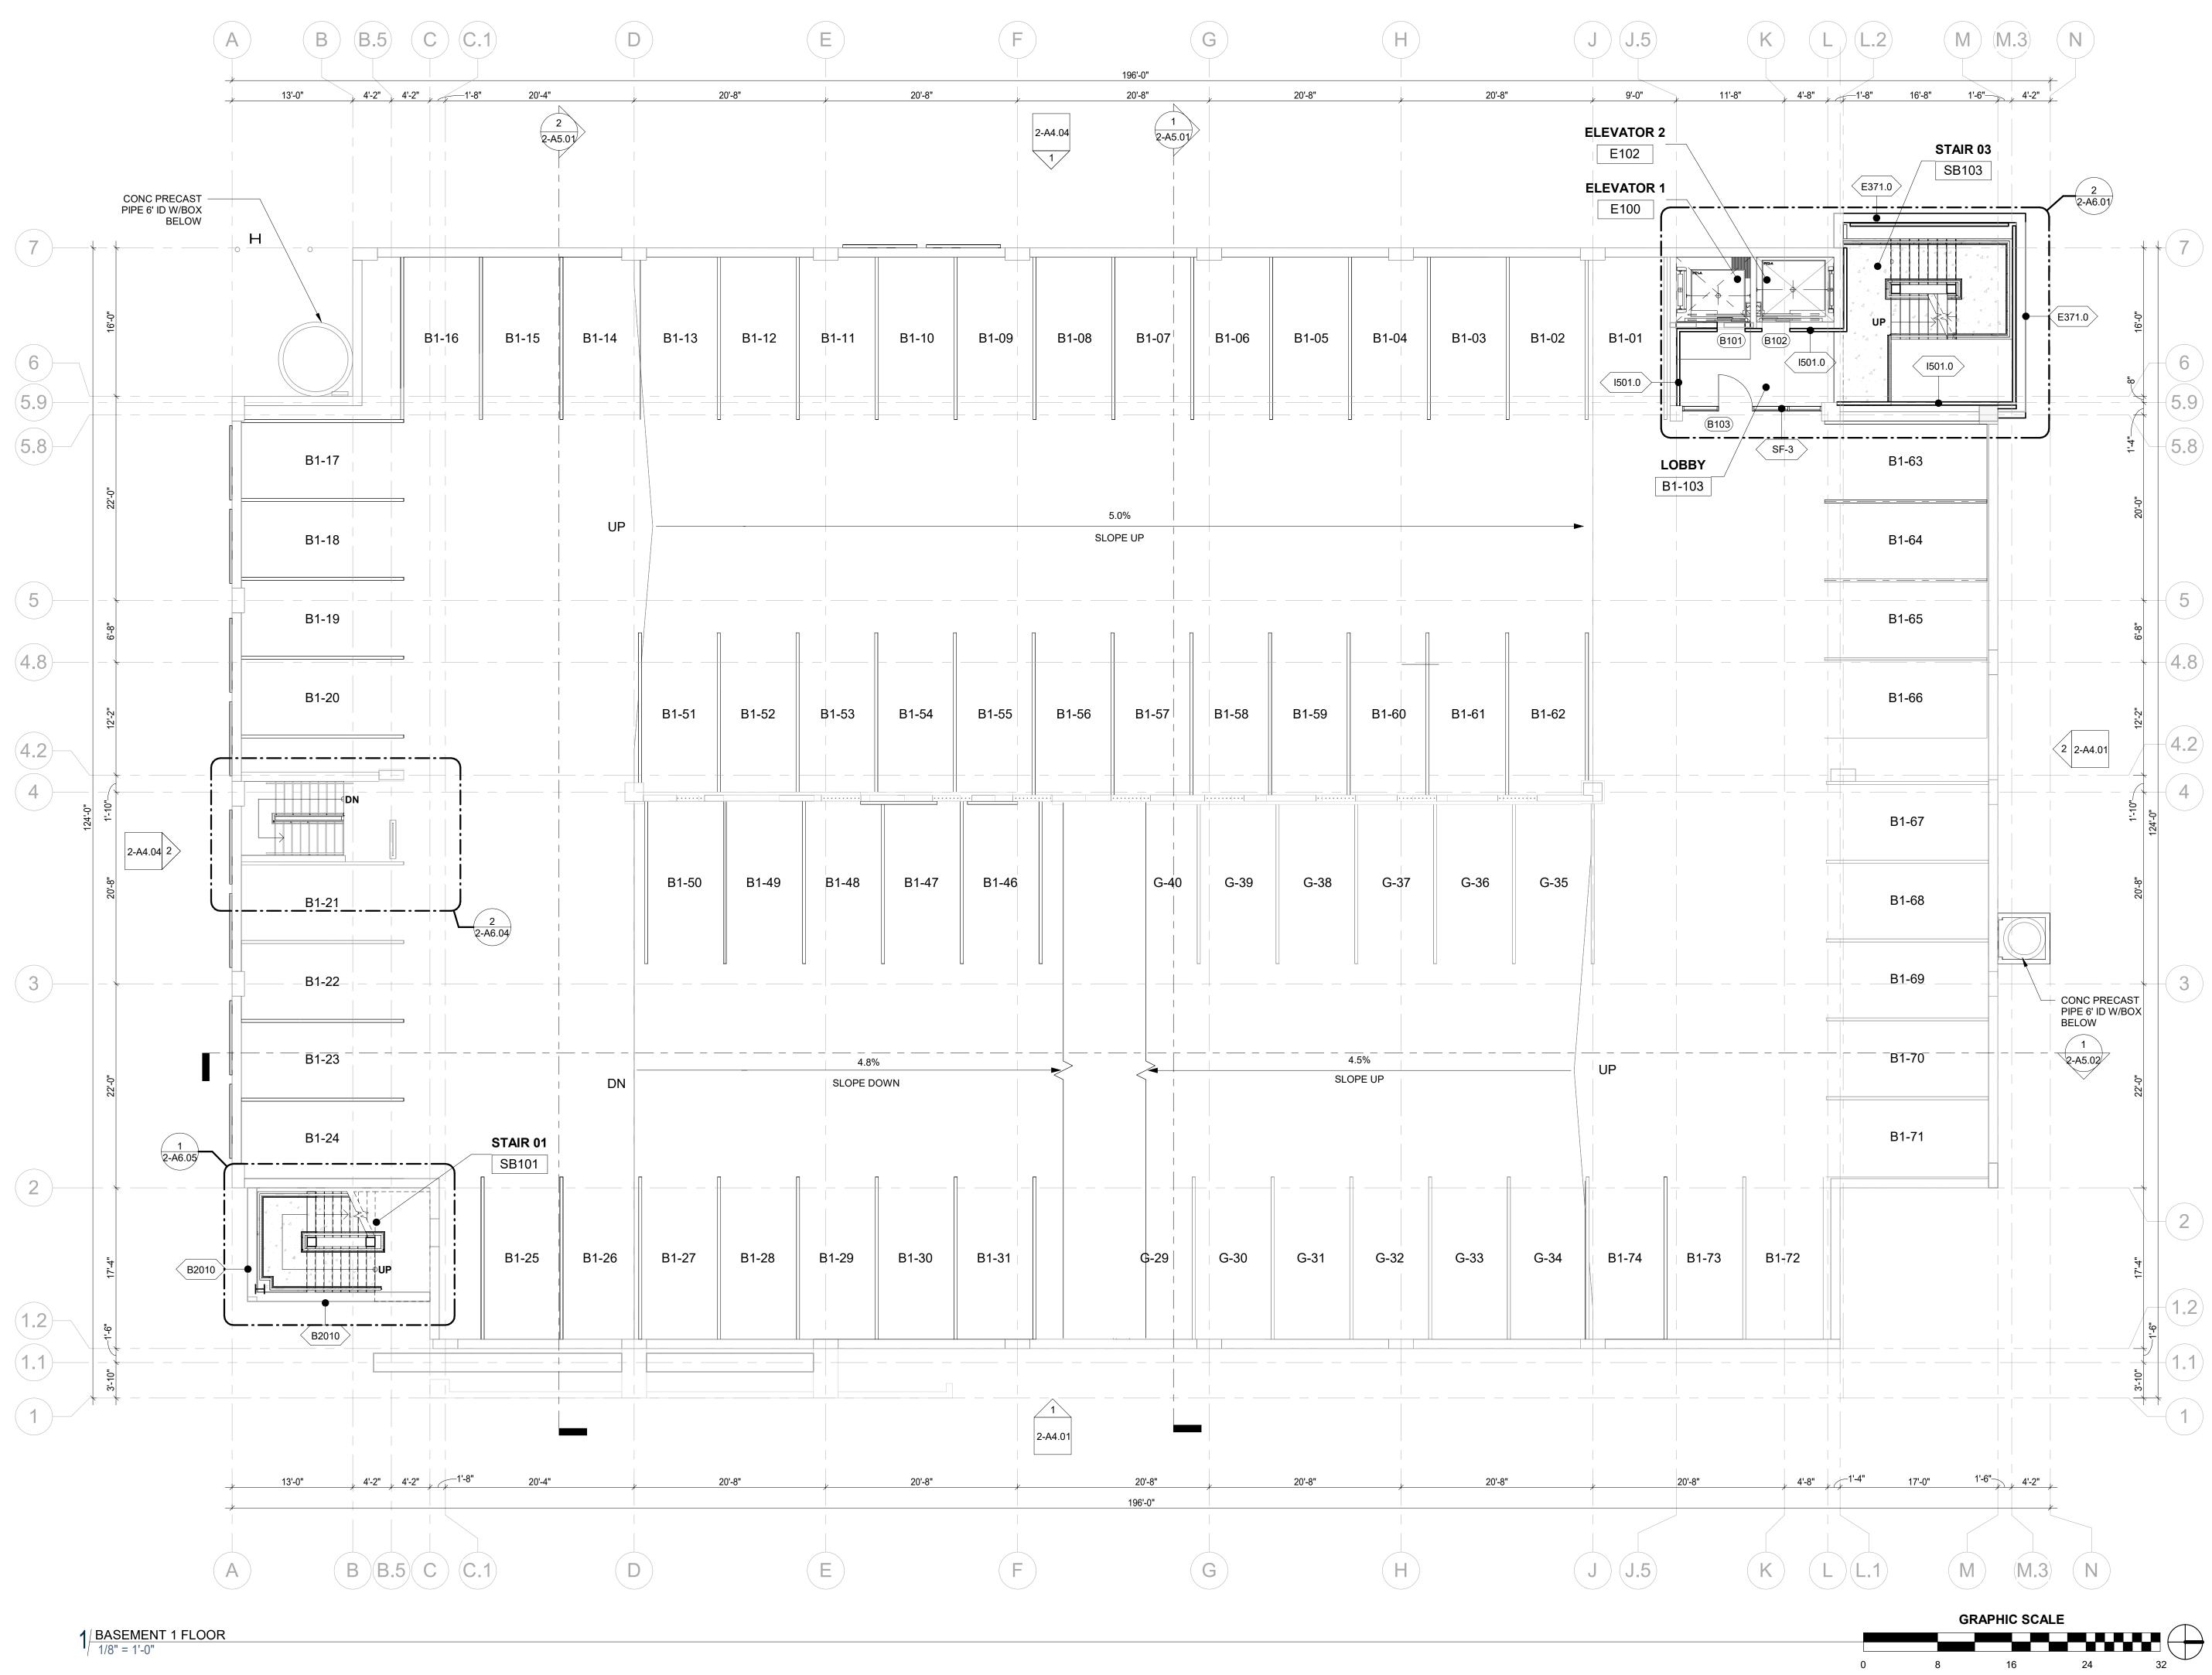


Current Issue CONSTRUCTION DOCUMENTS


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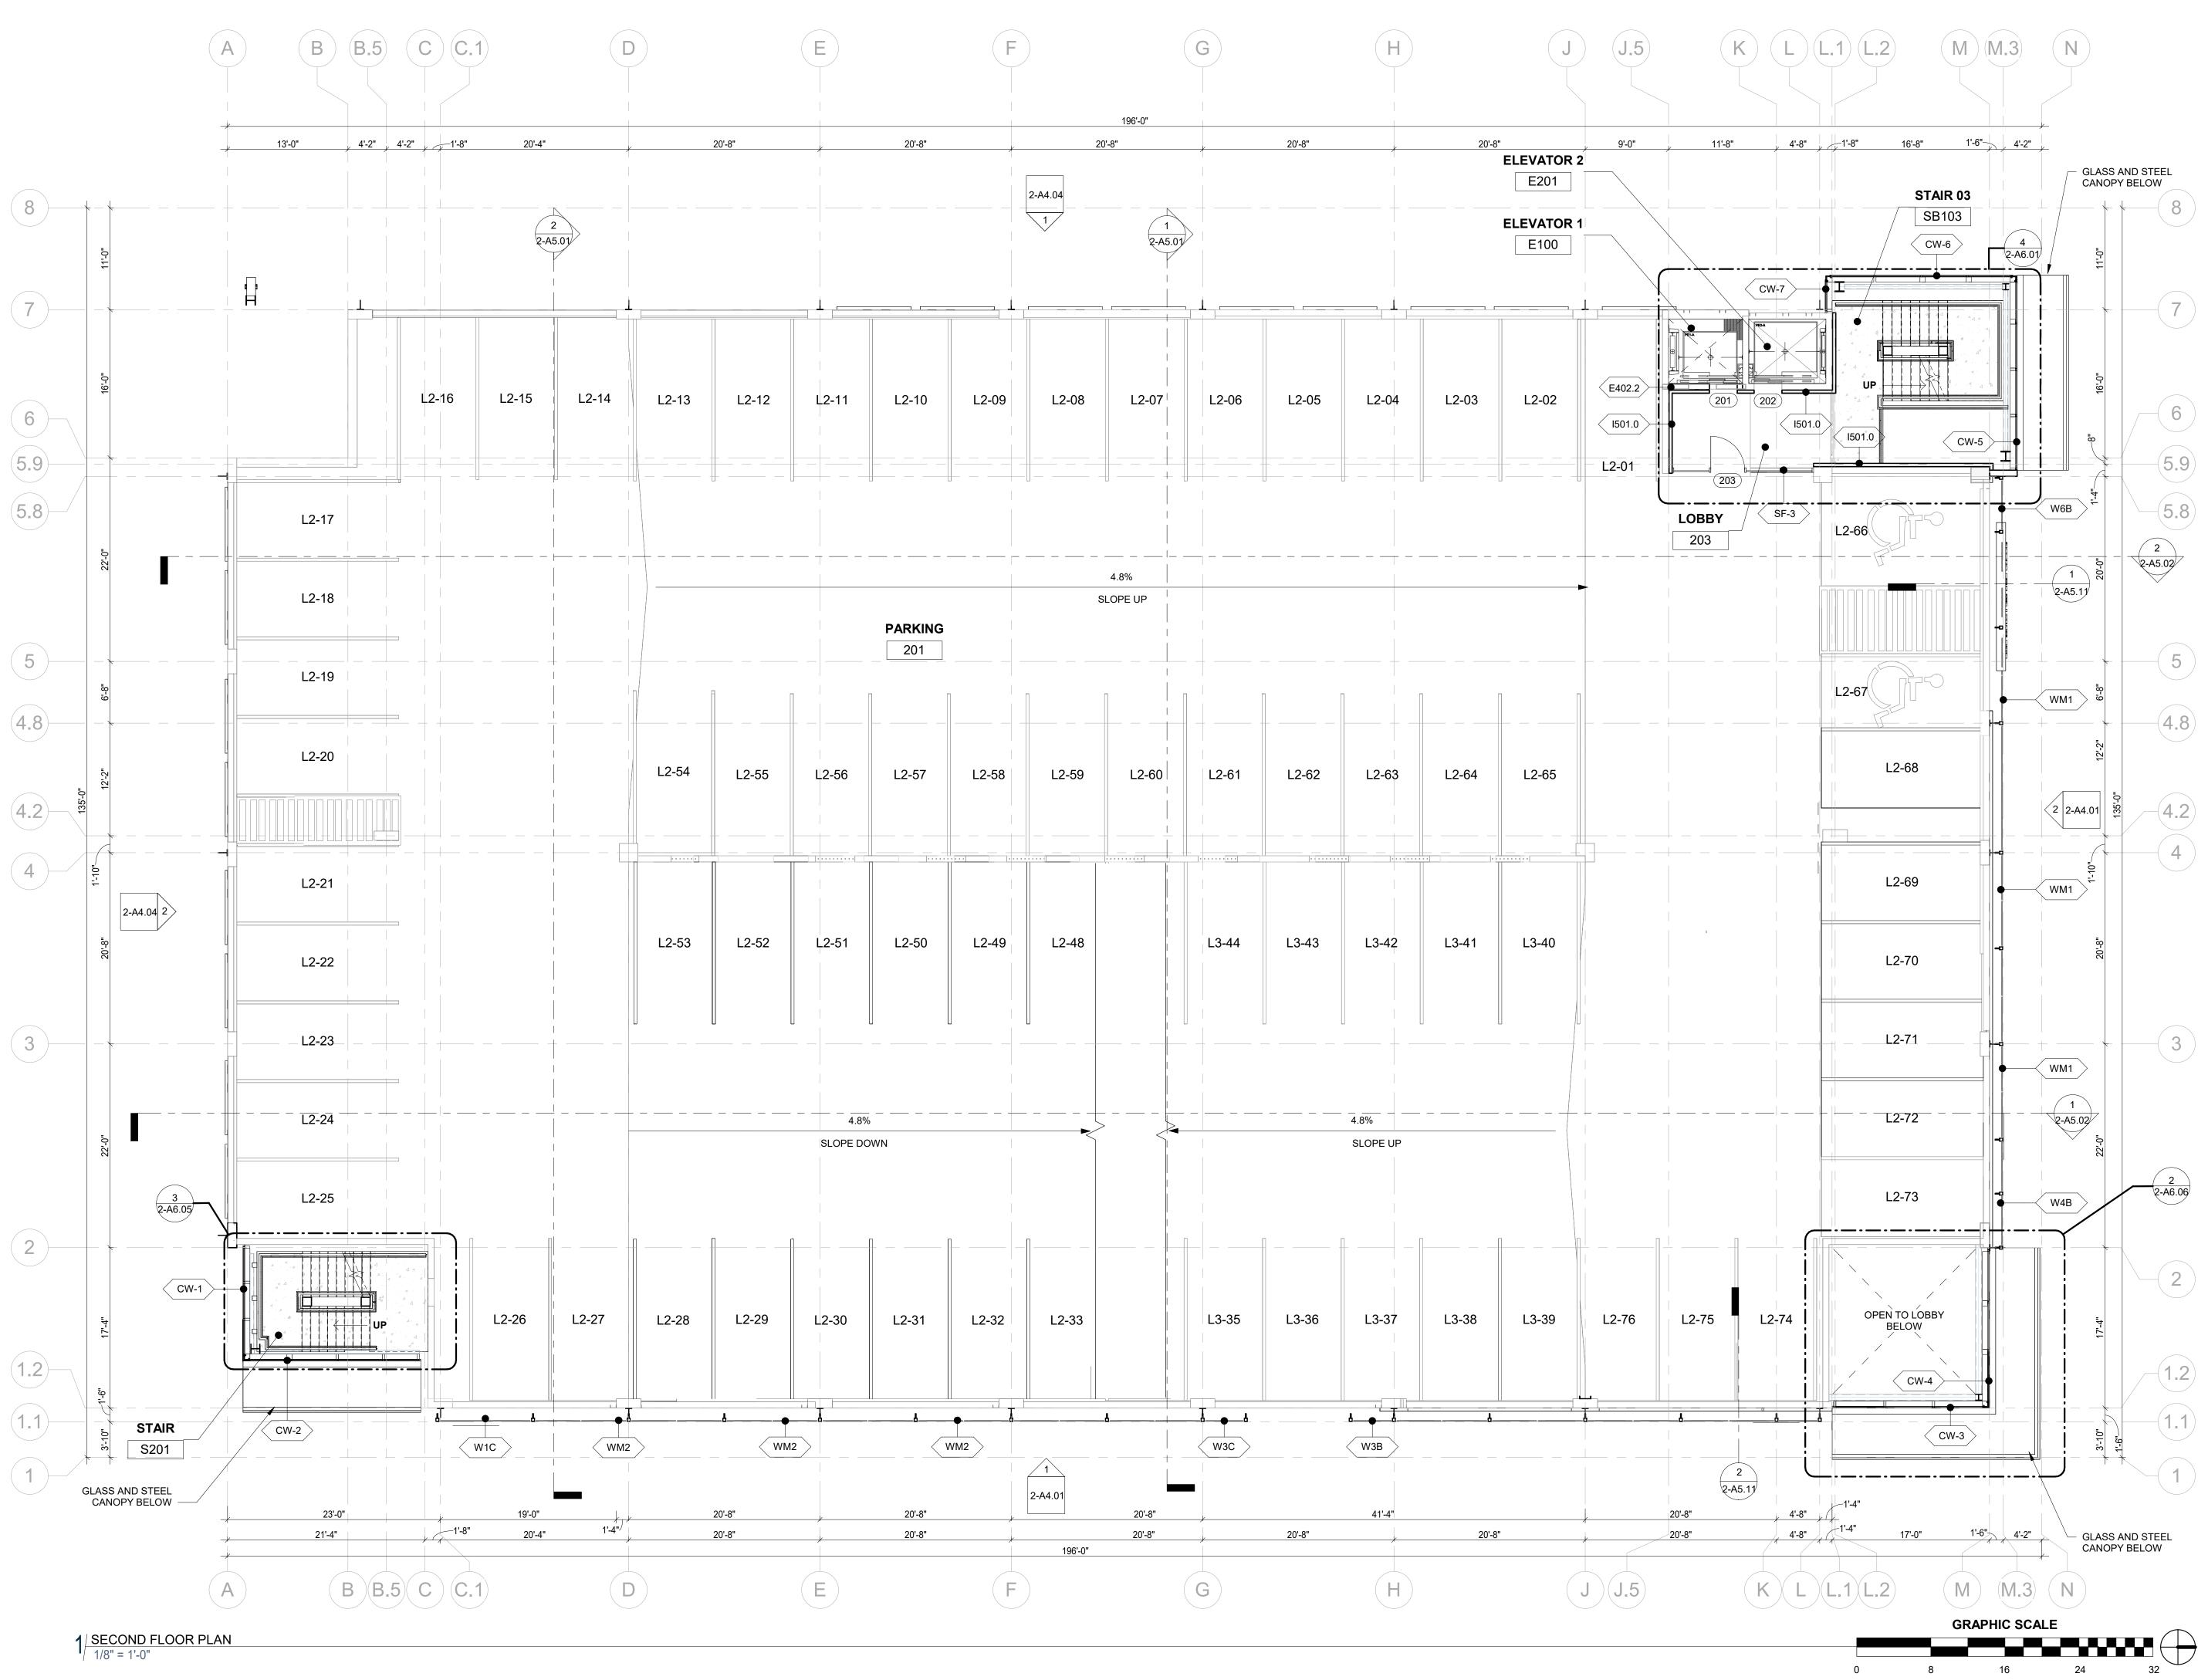
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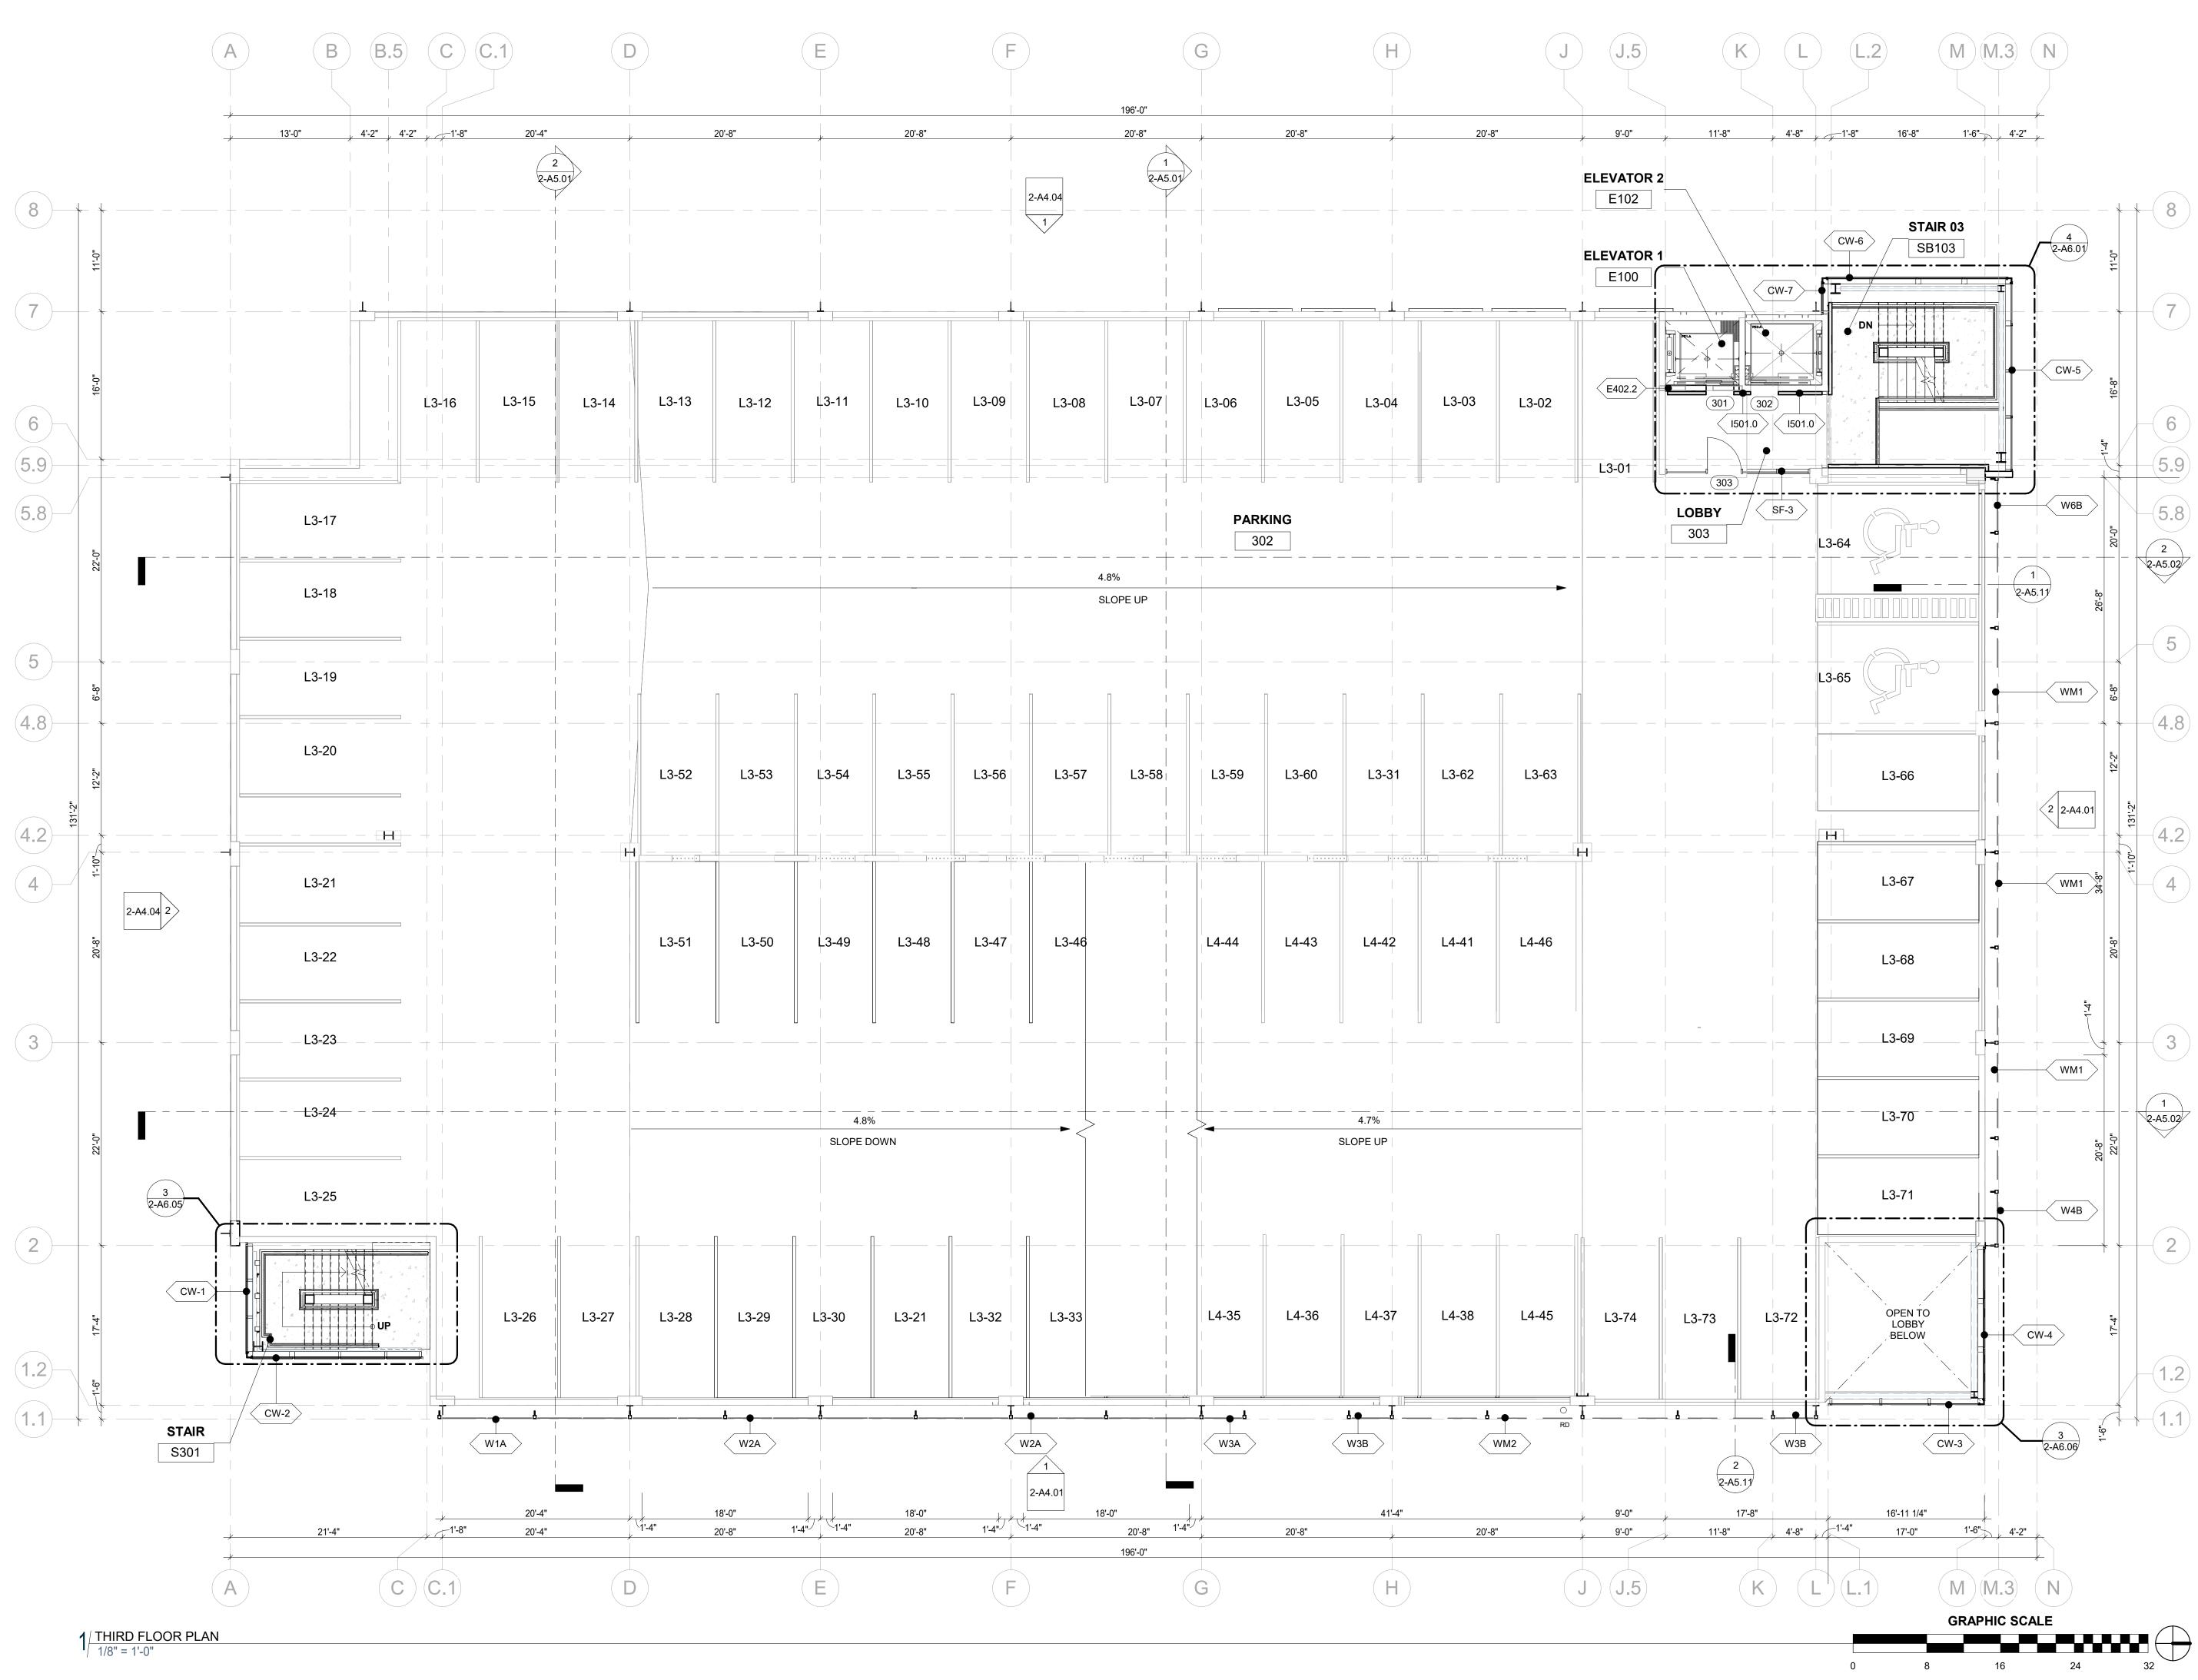
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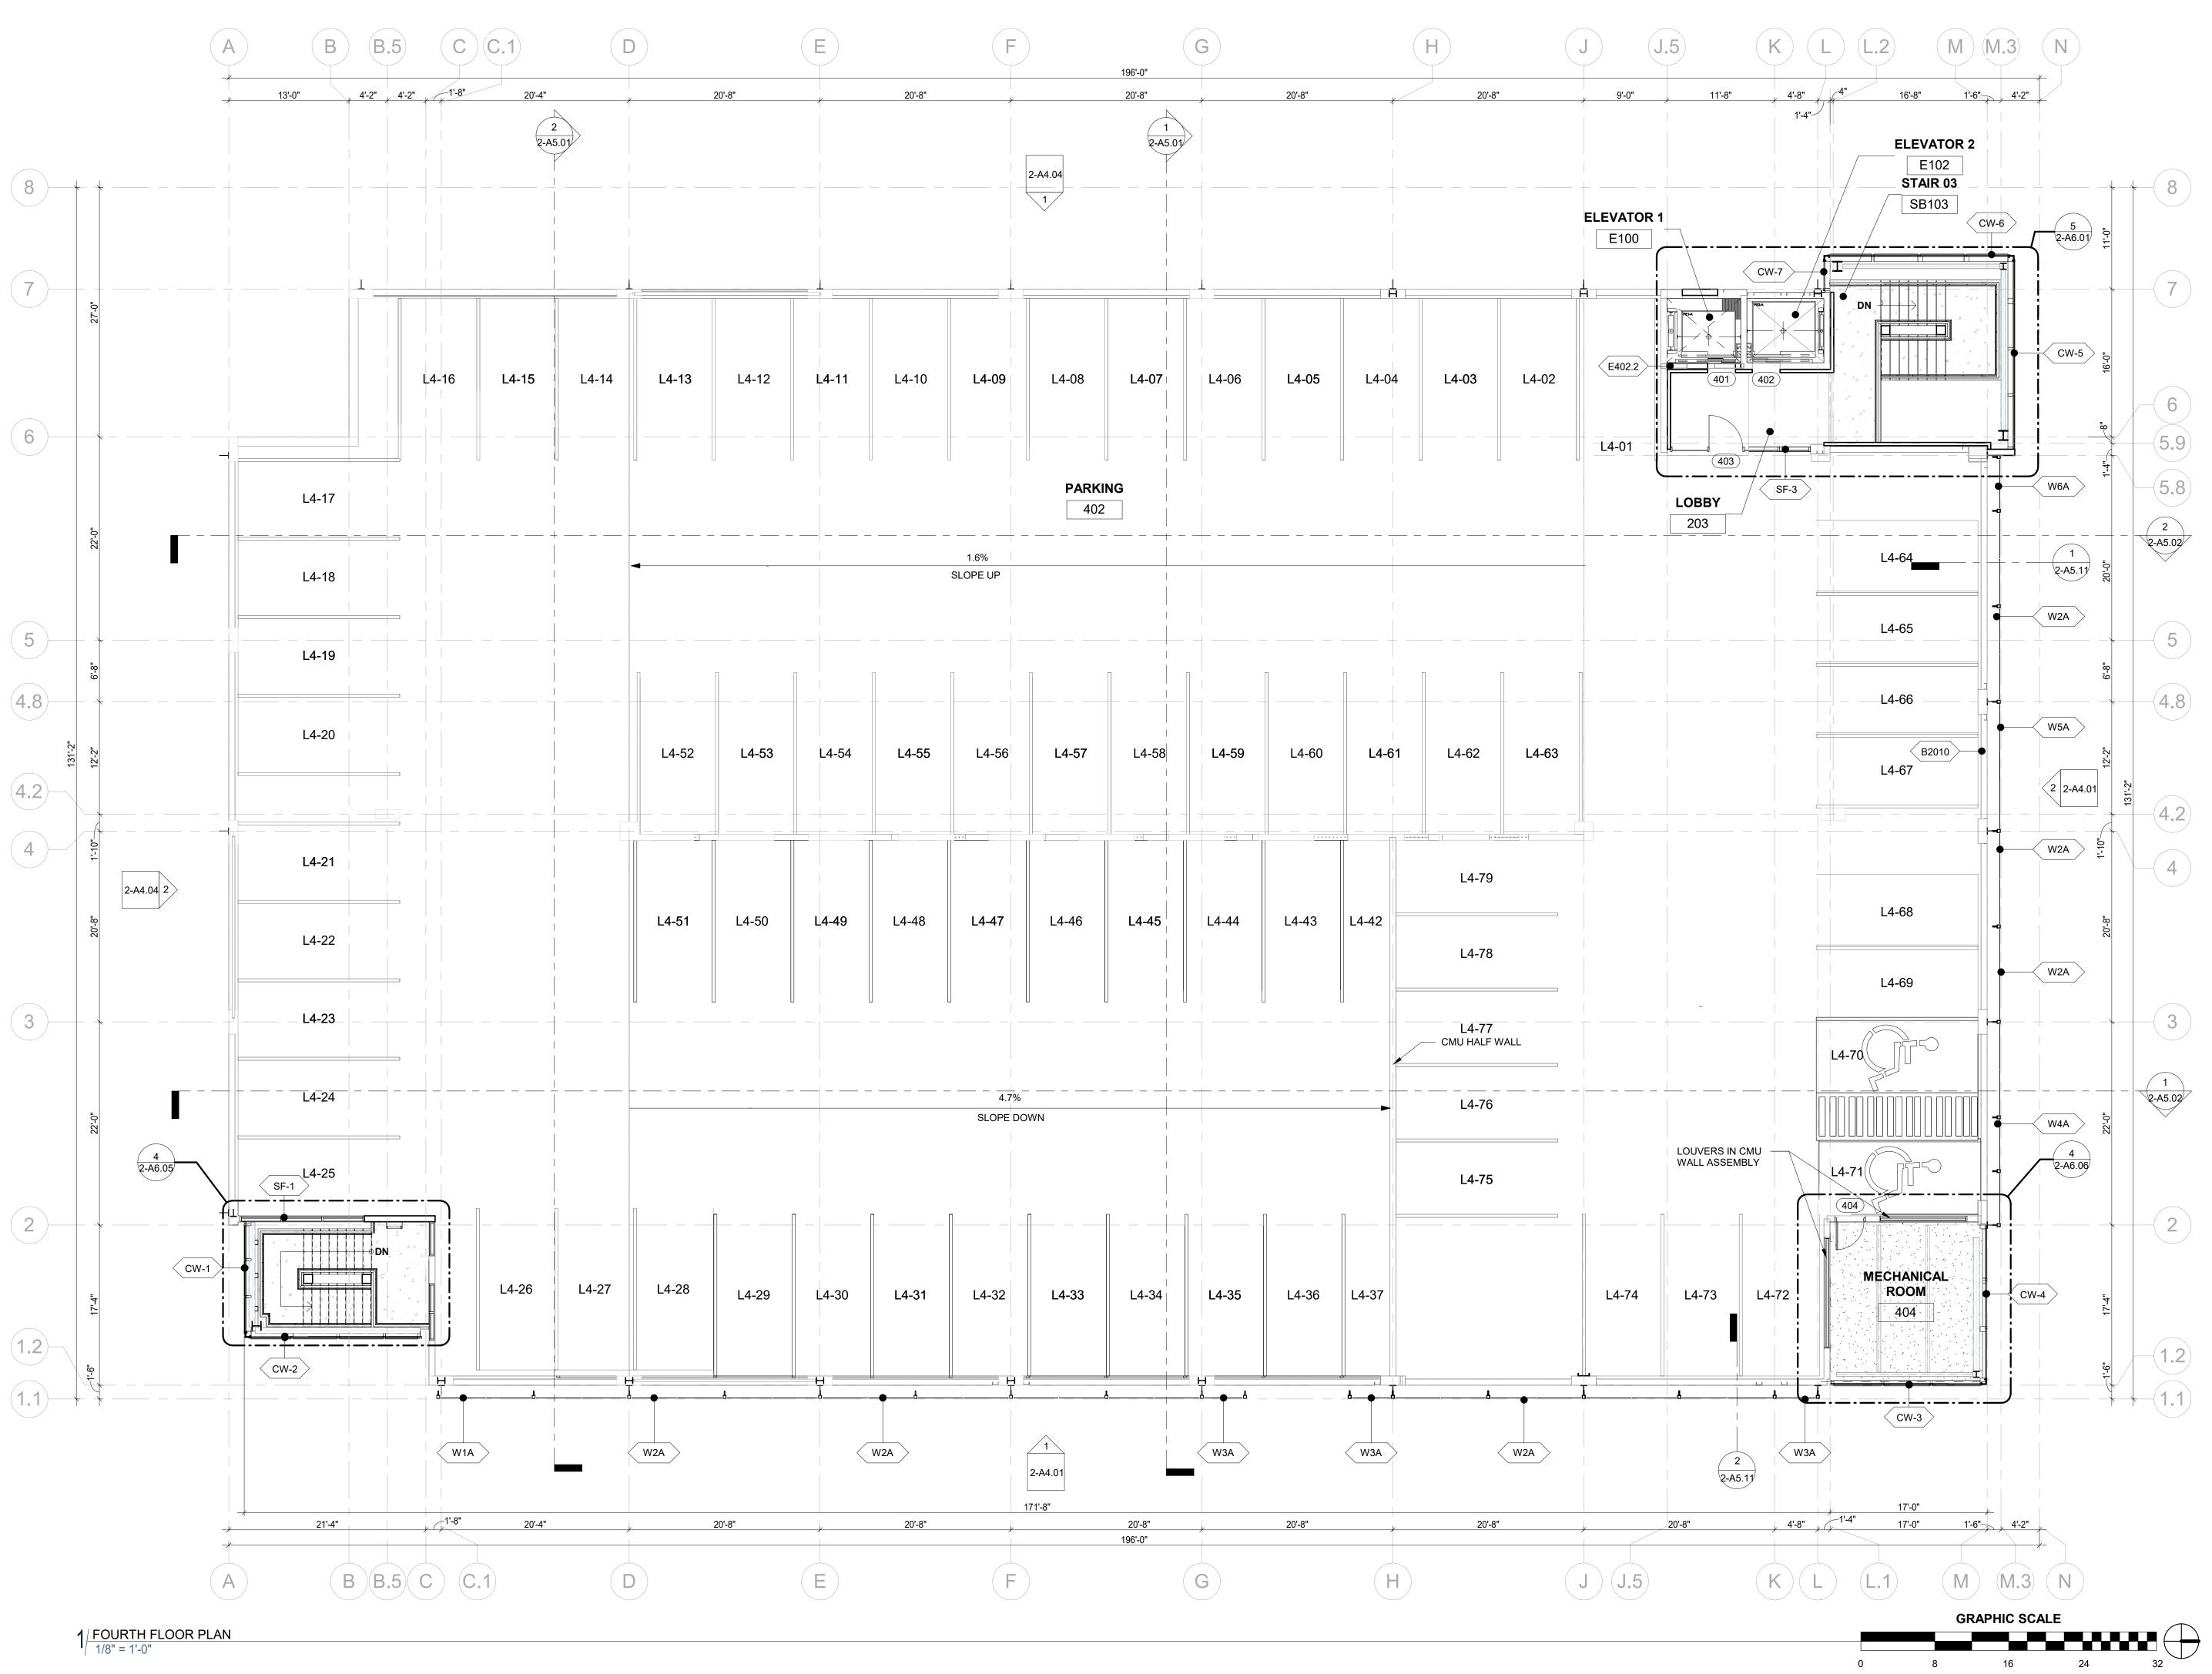
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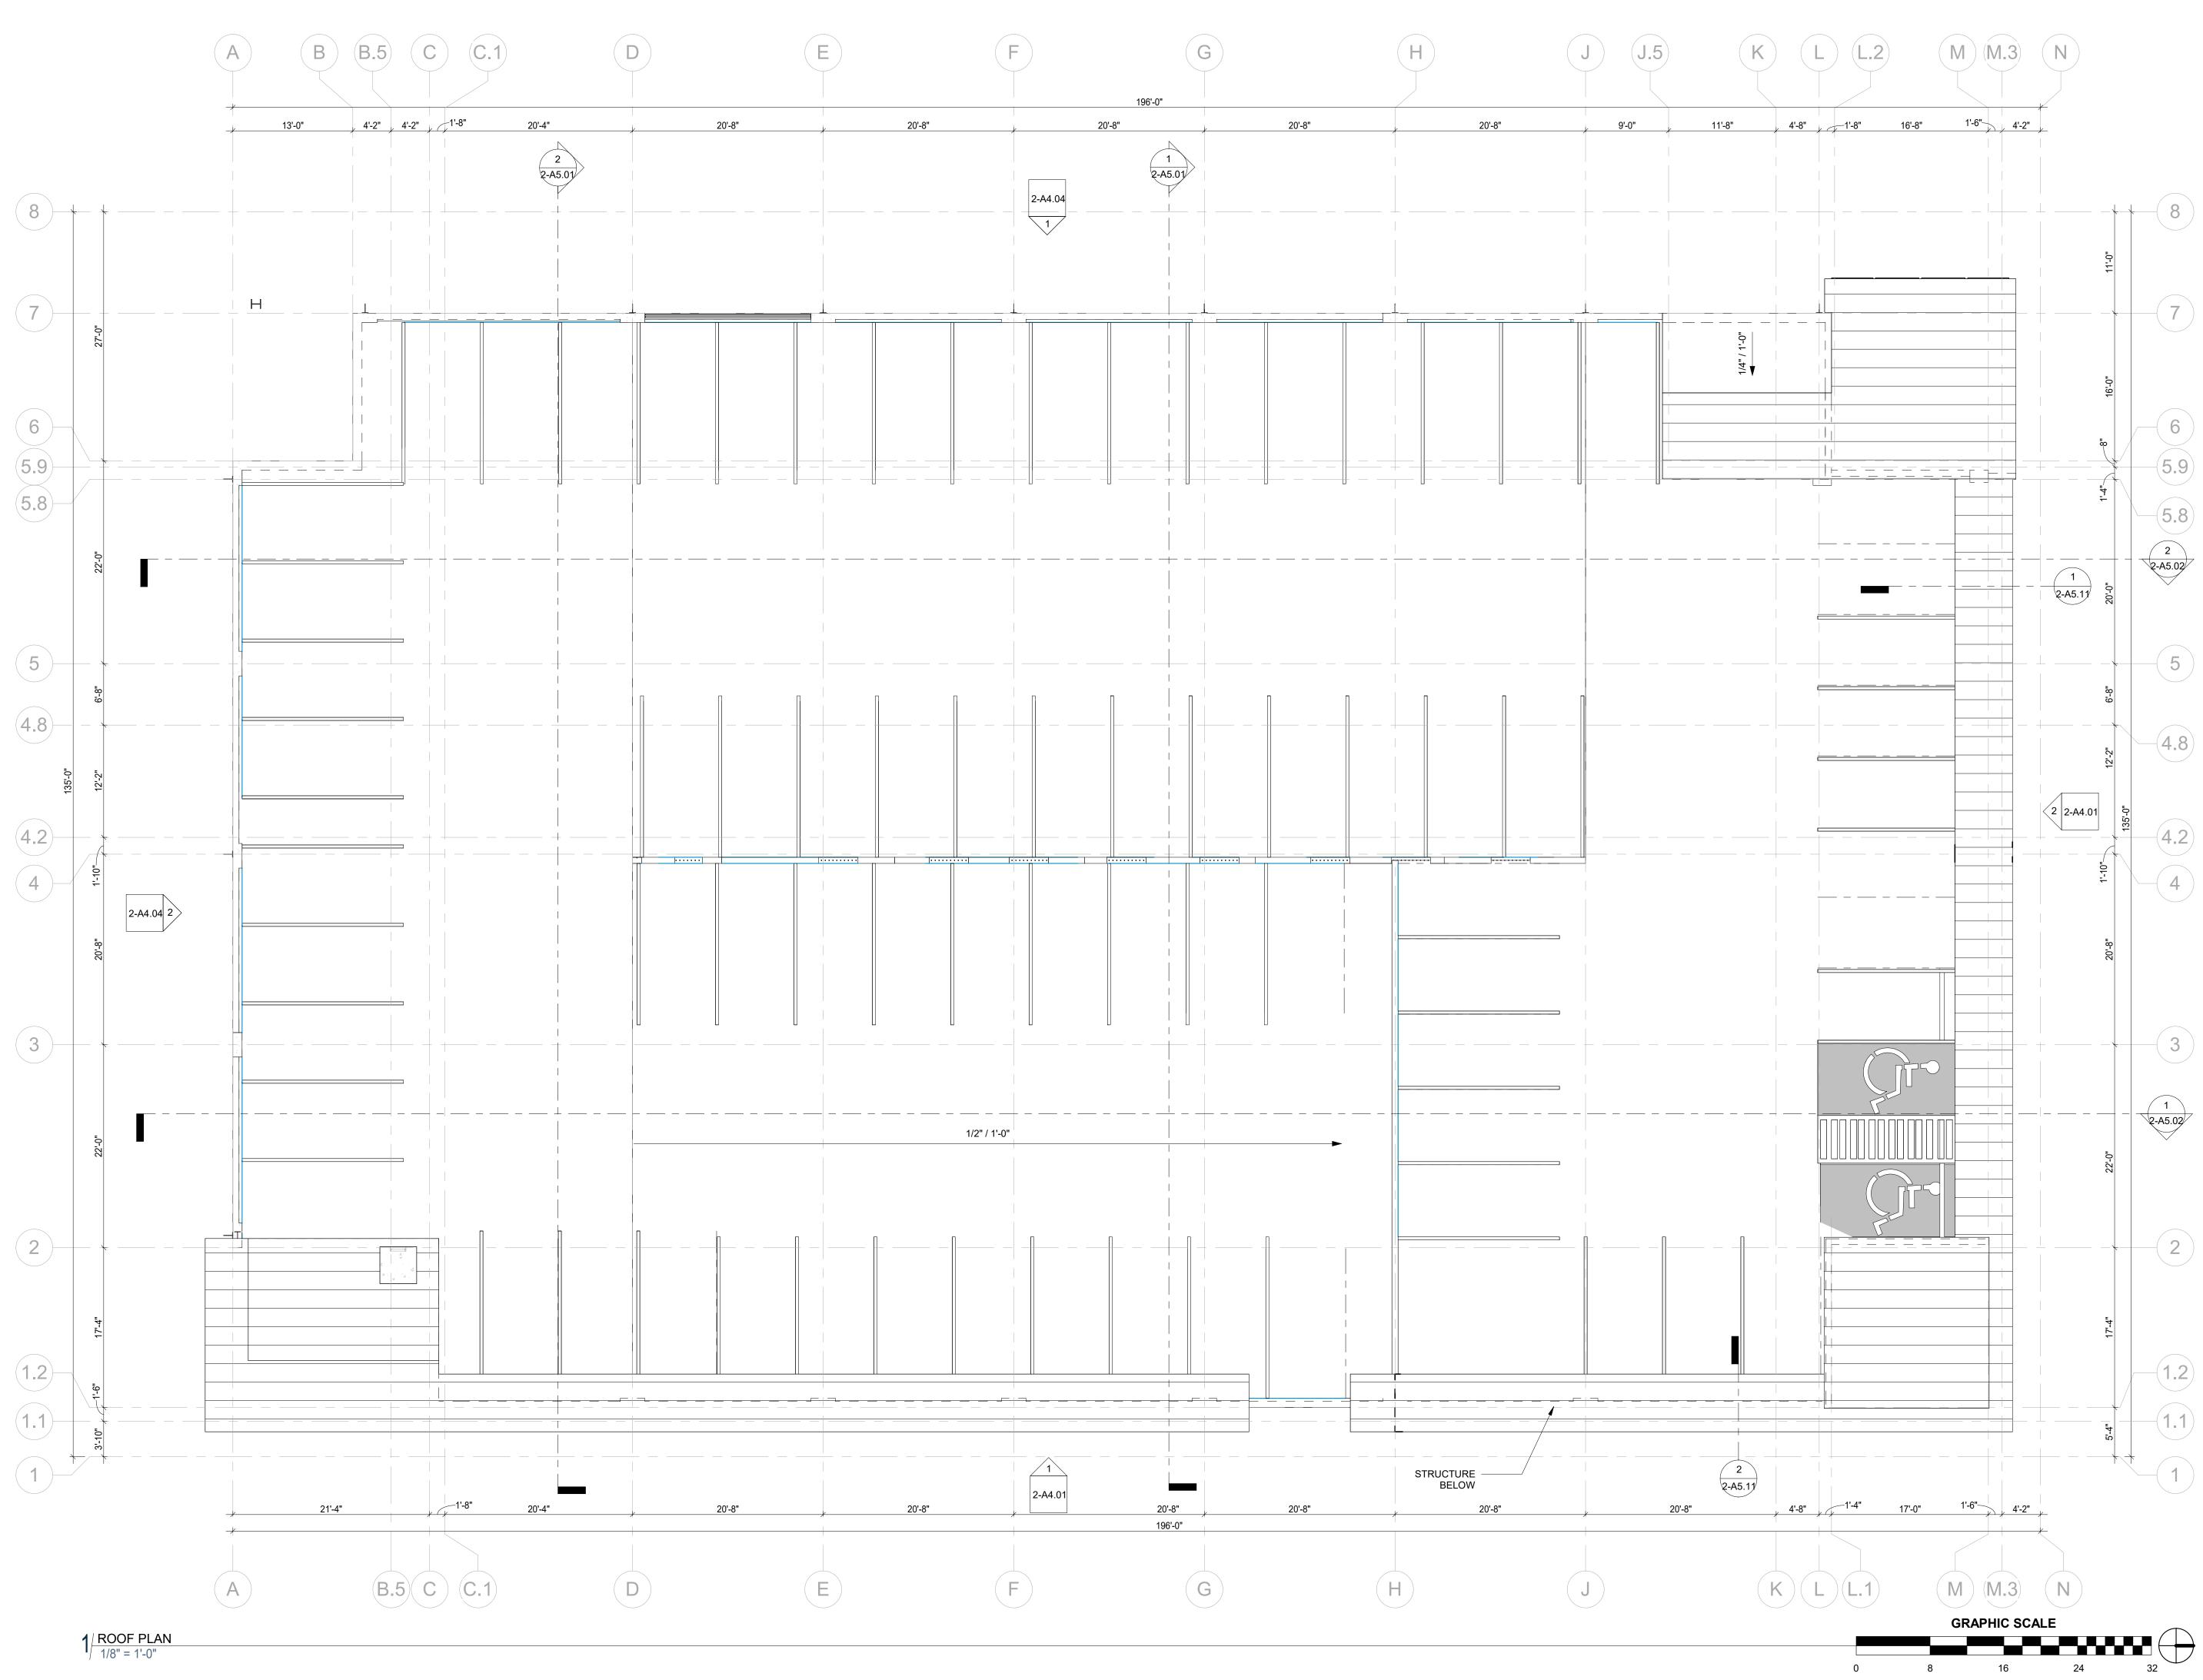
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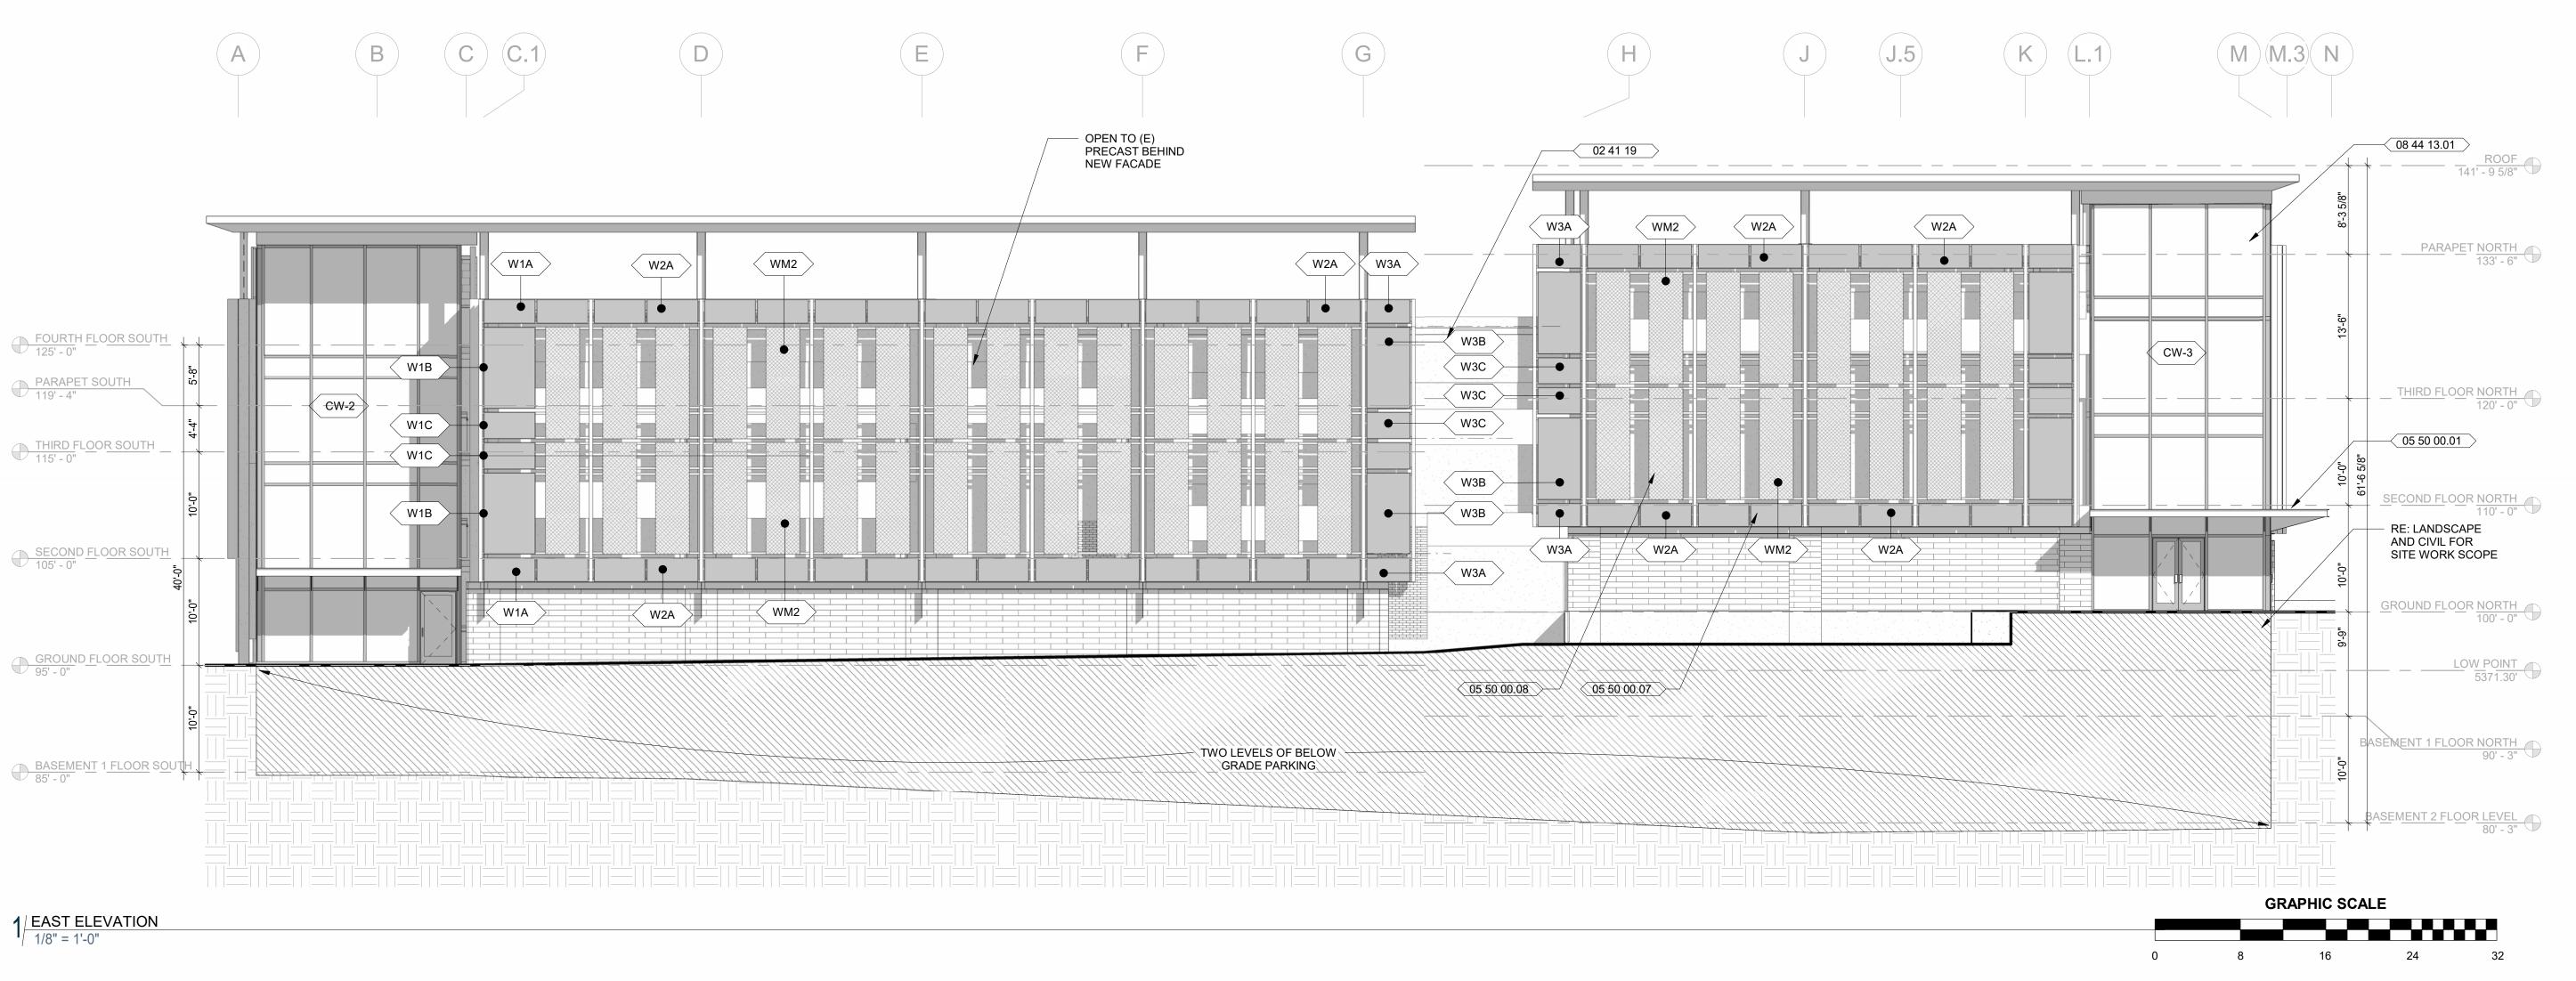


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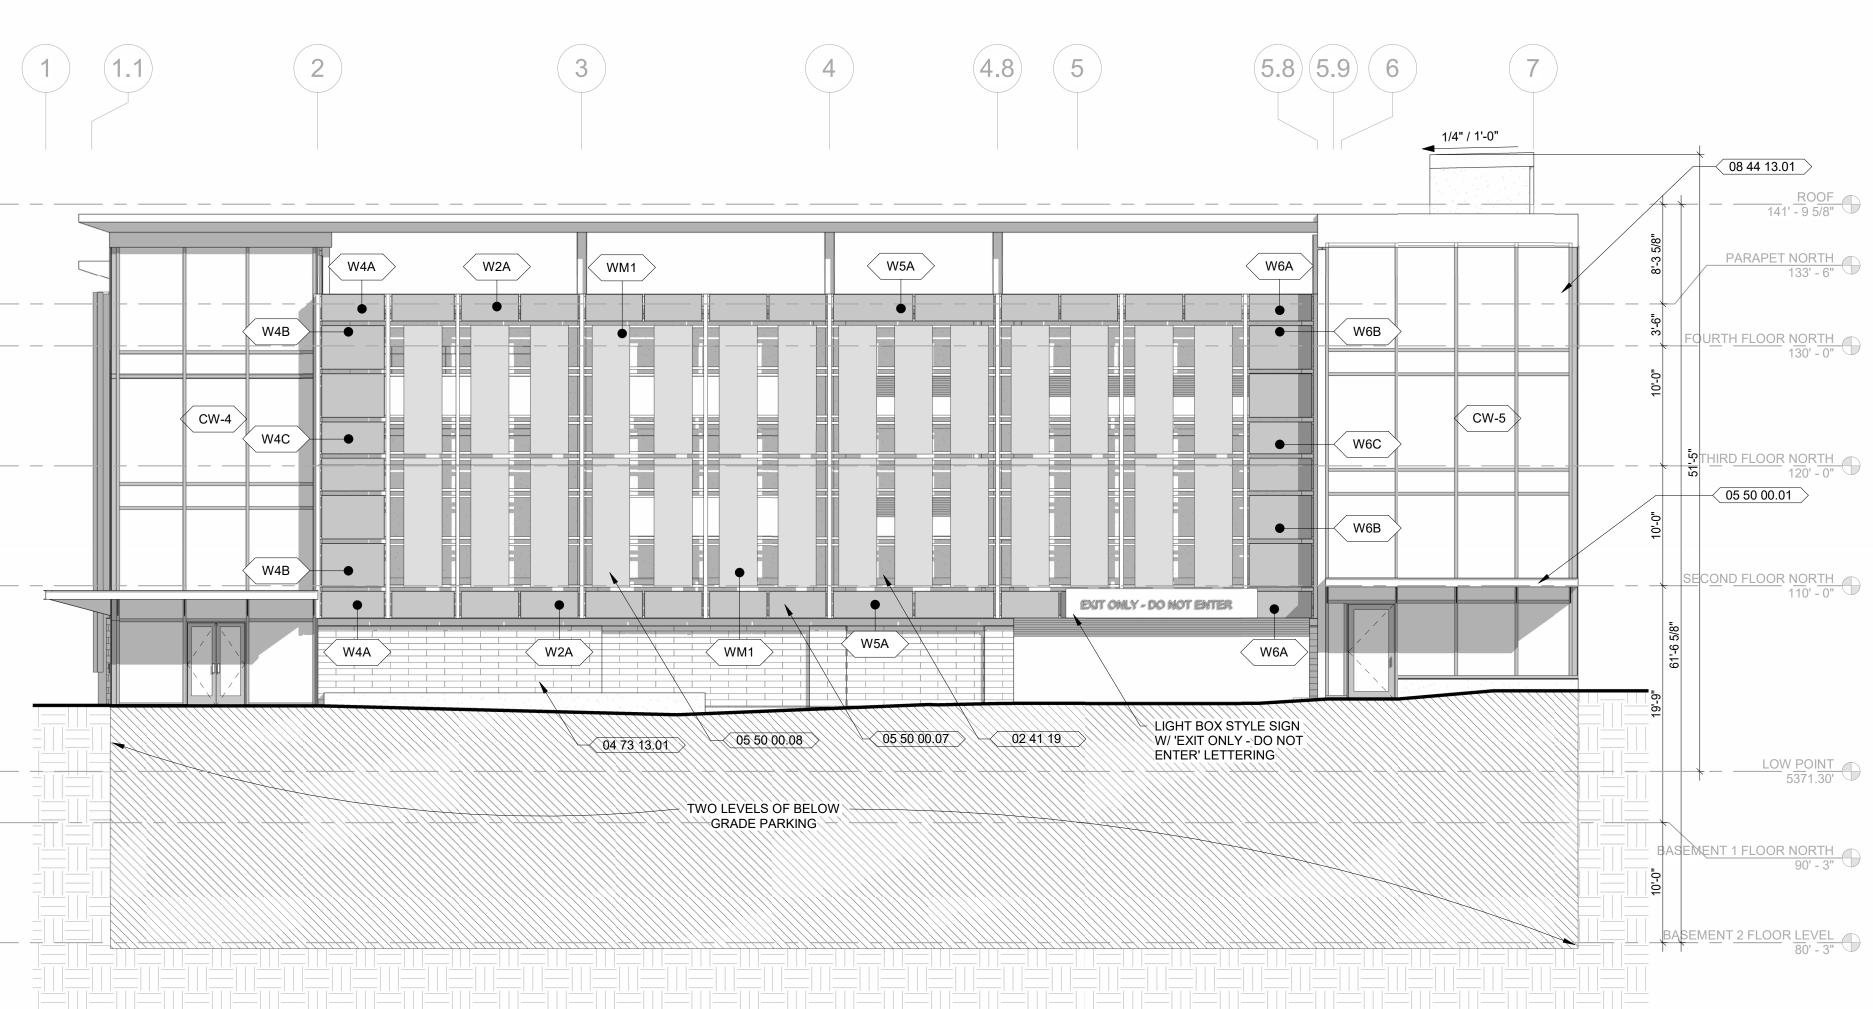





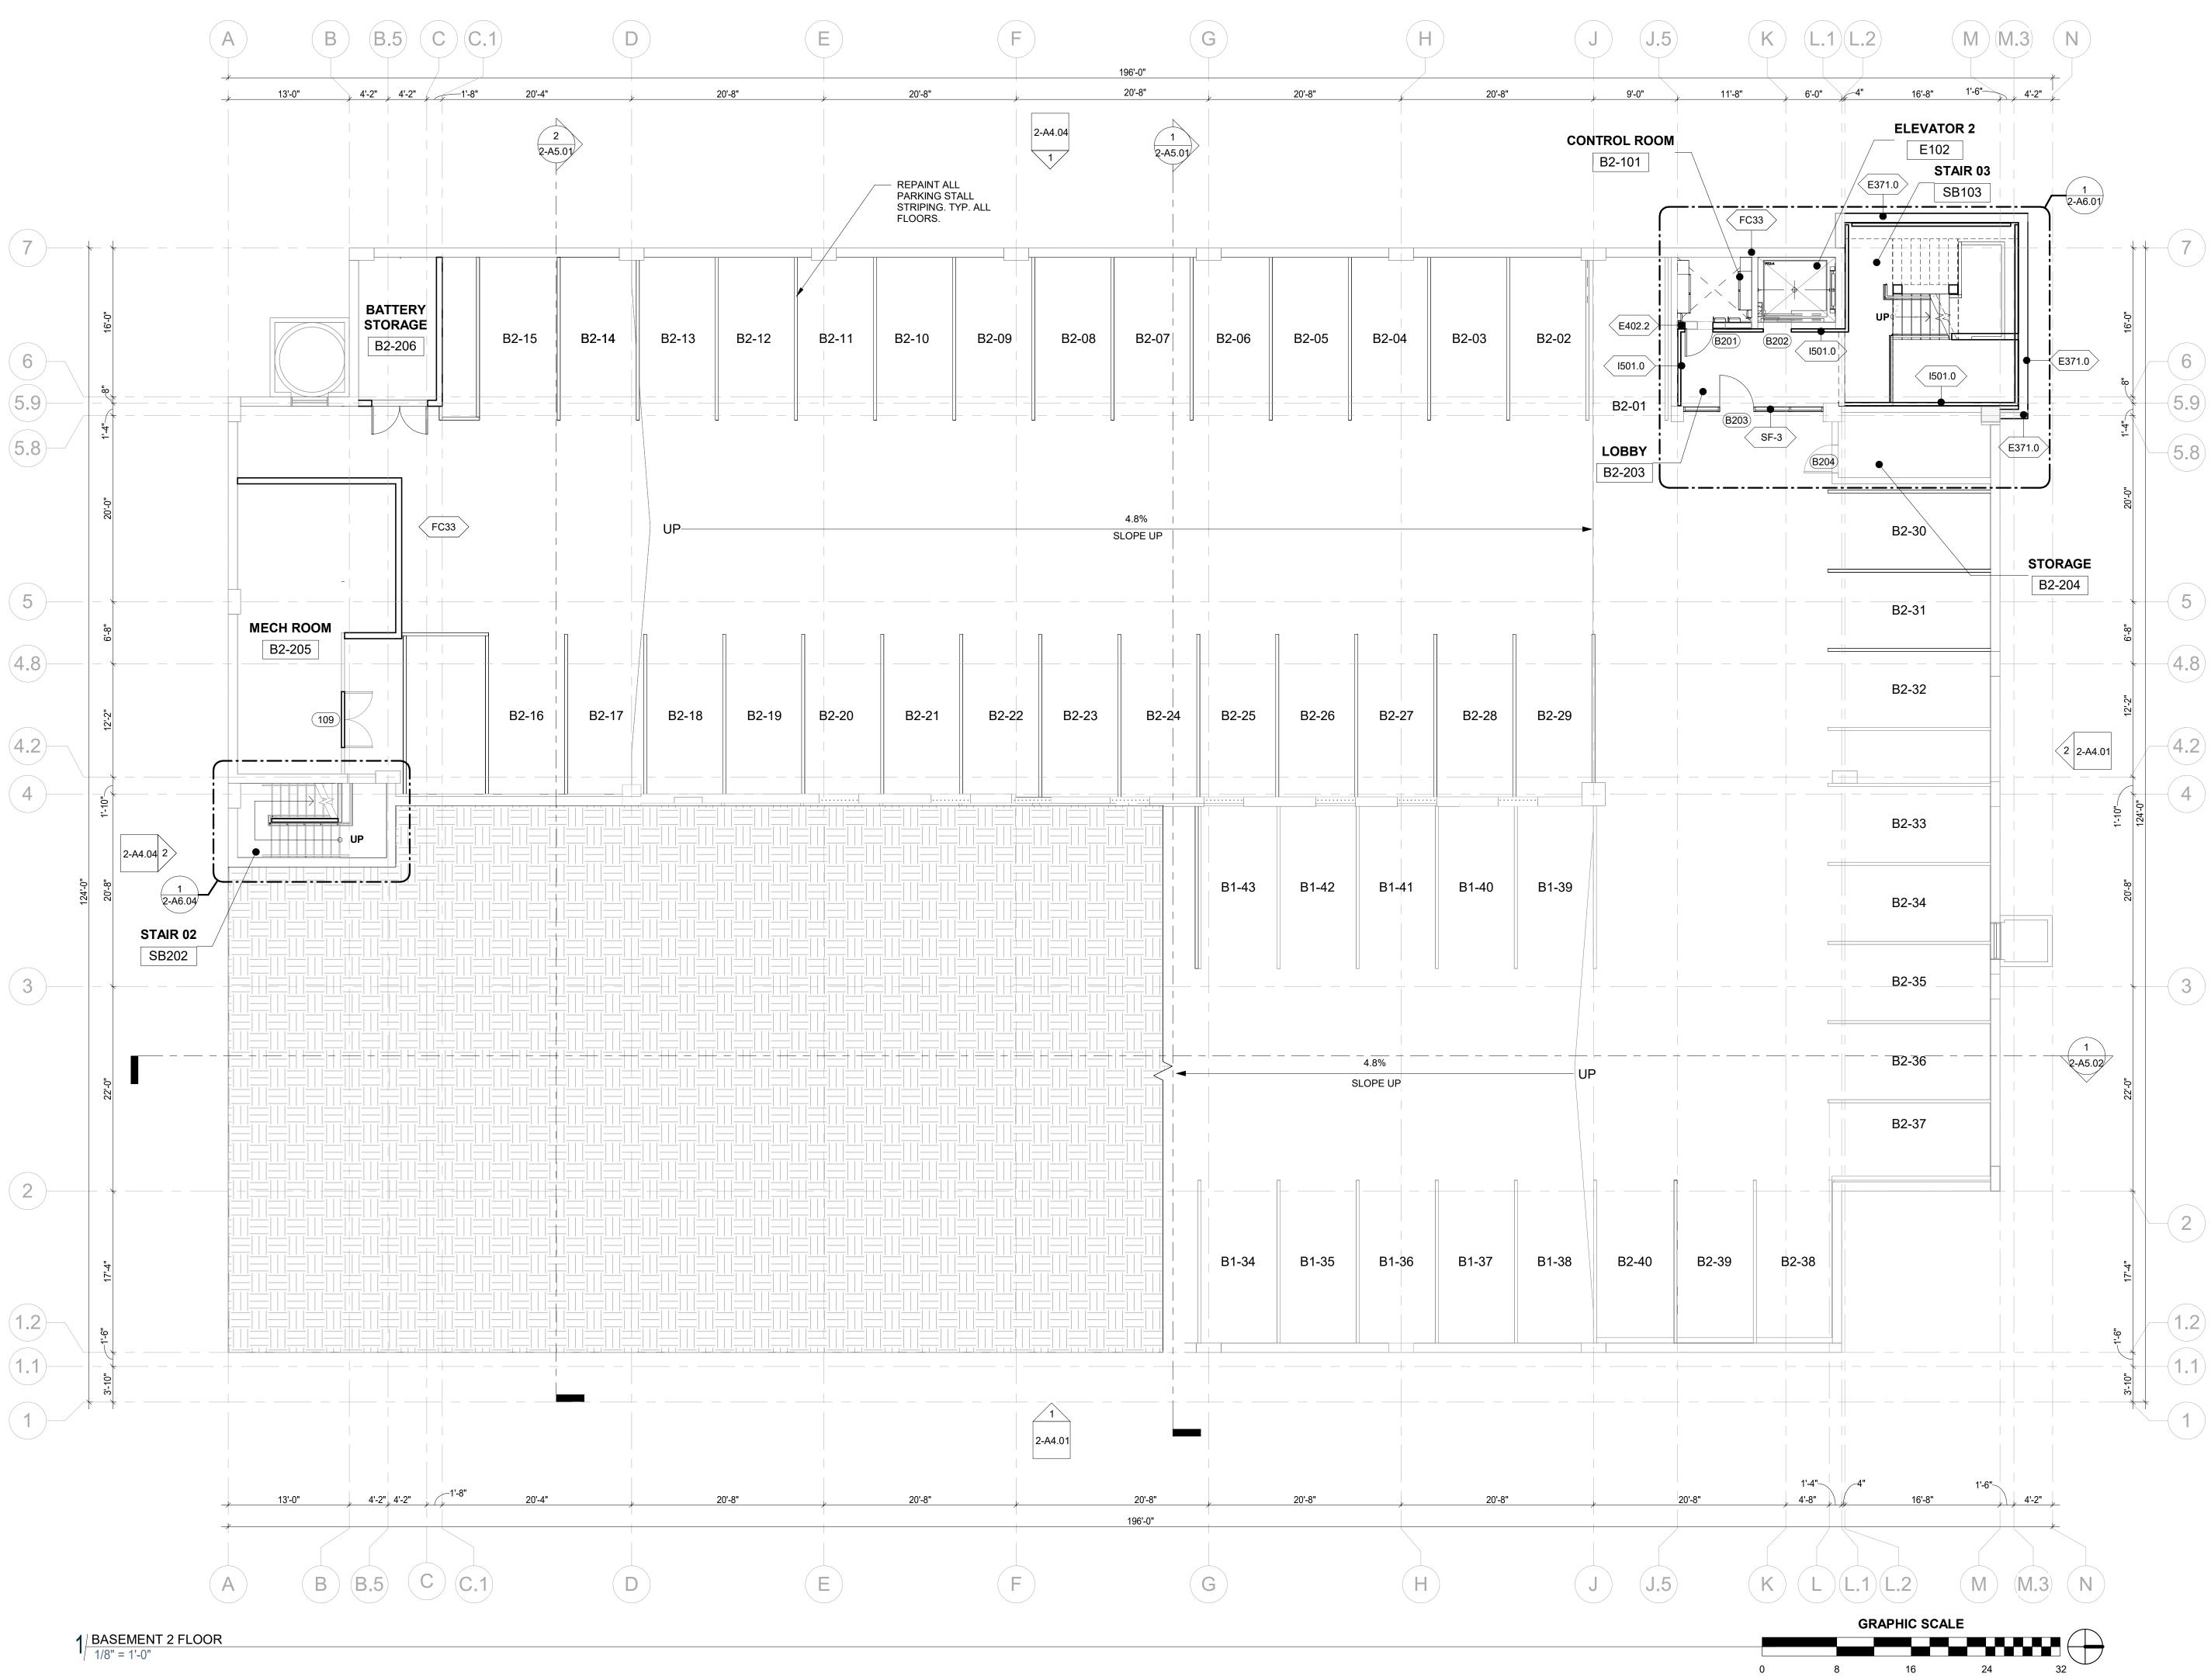



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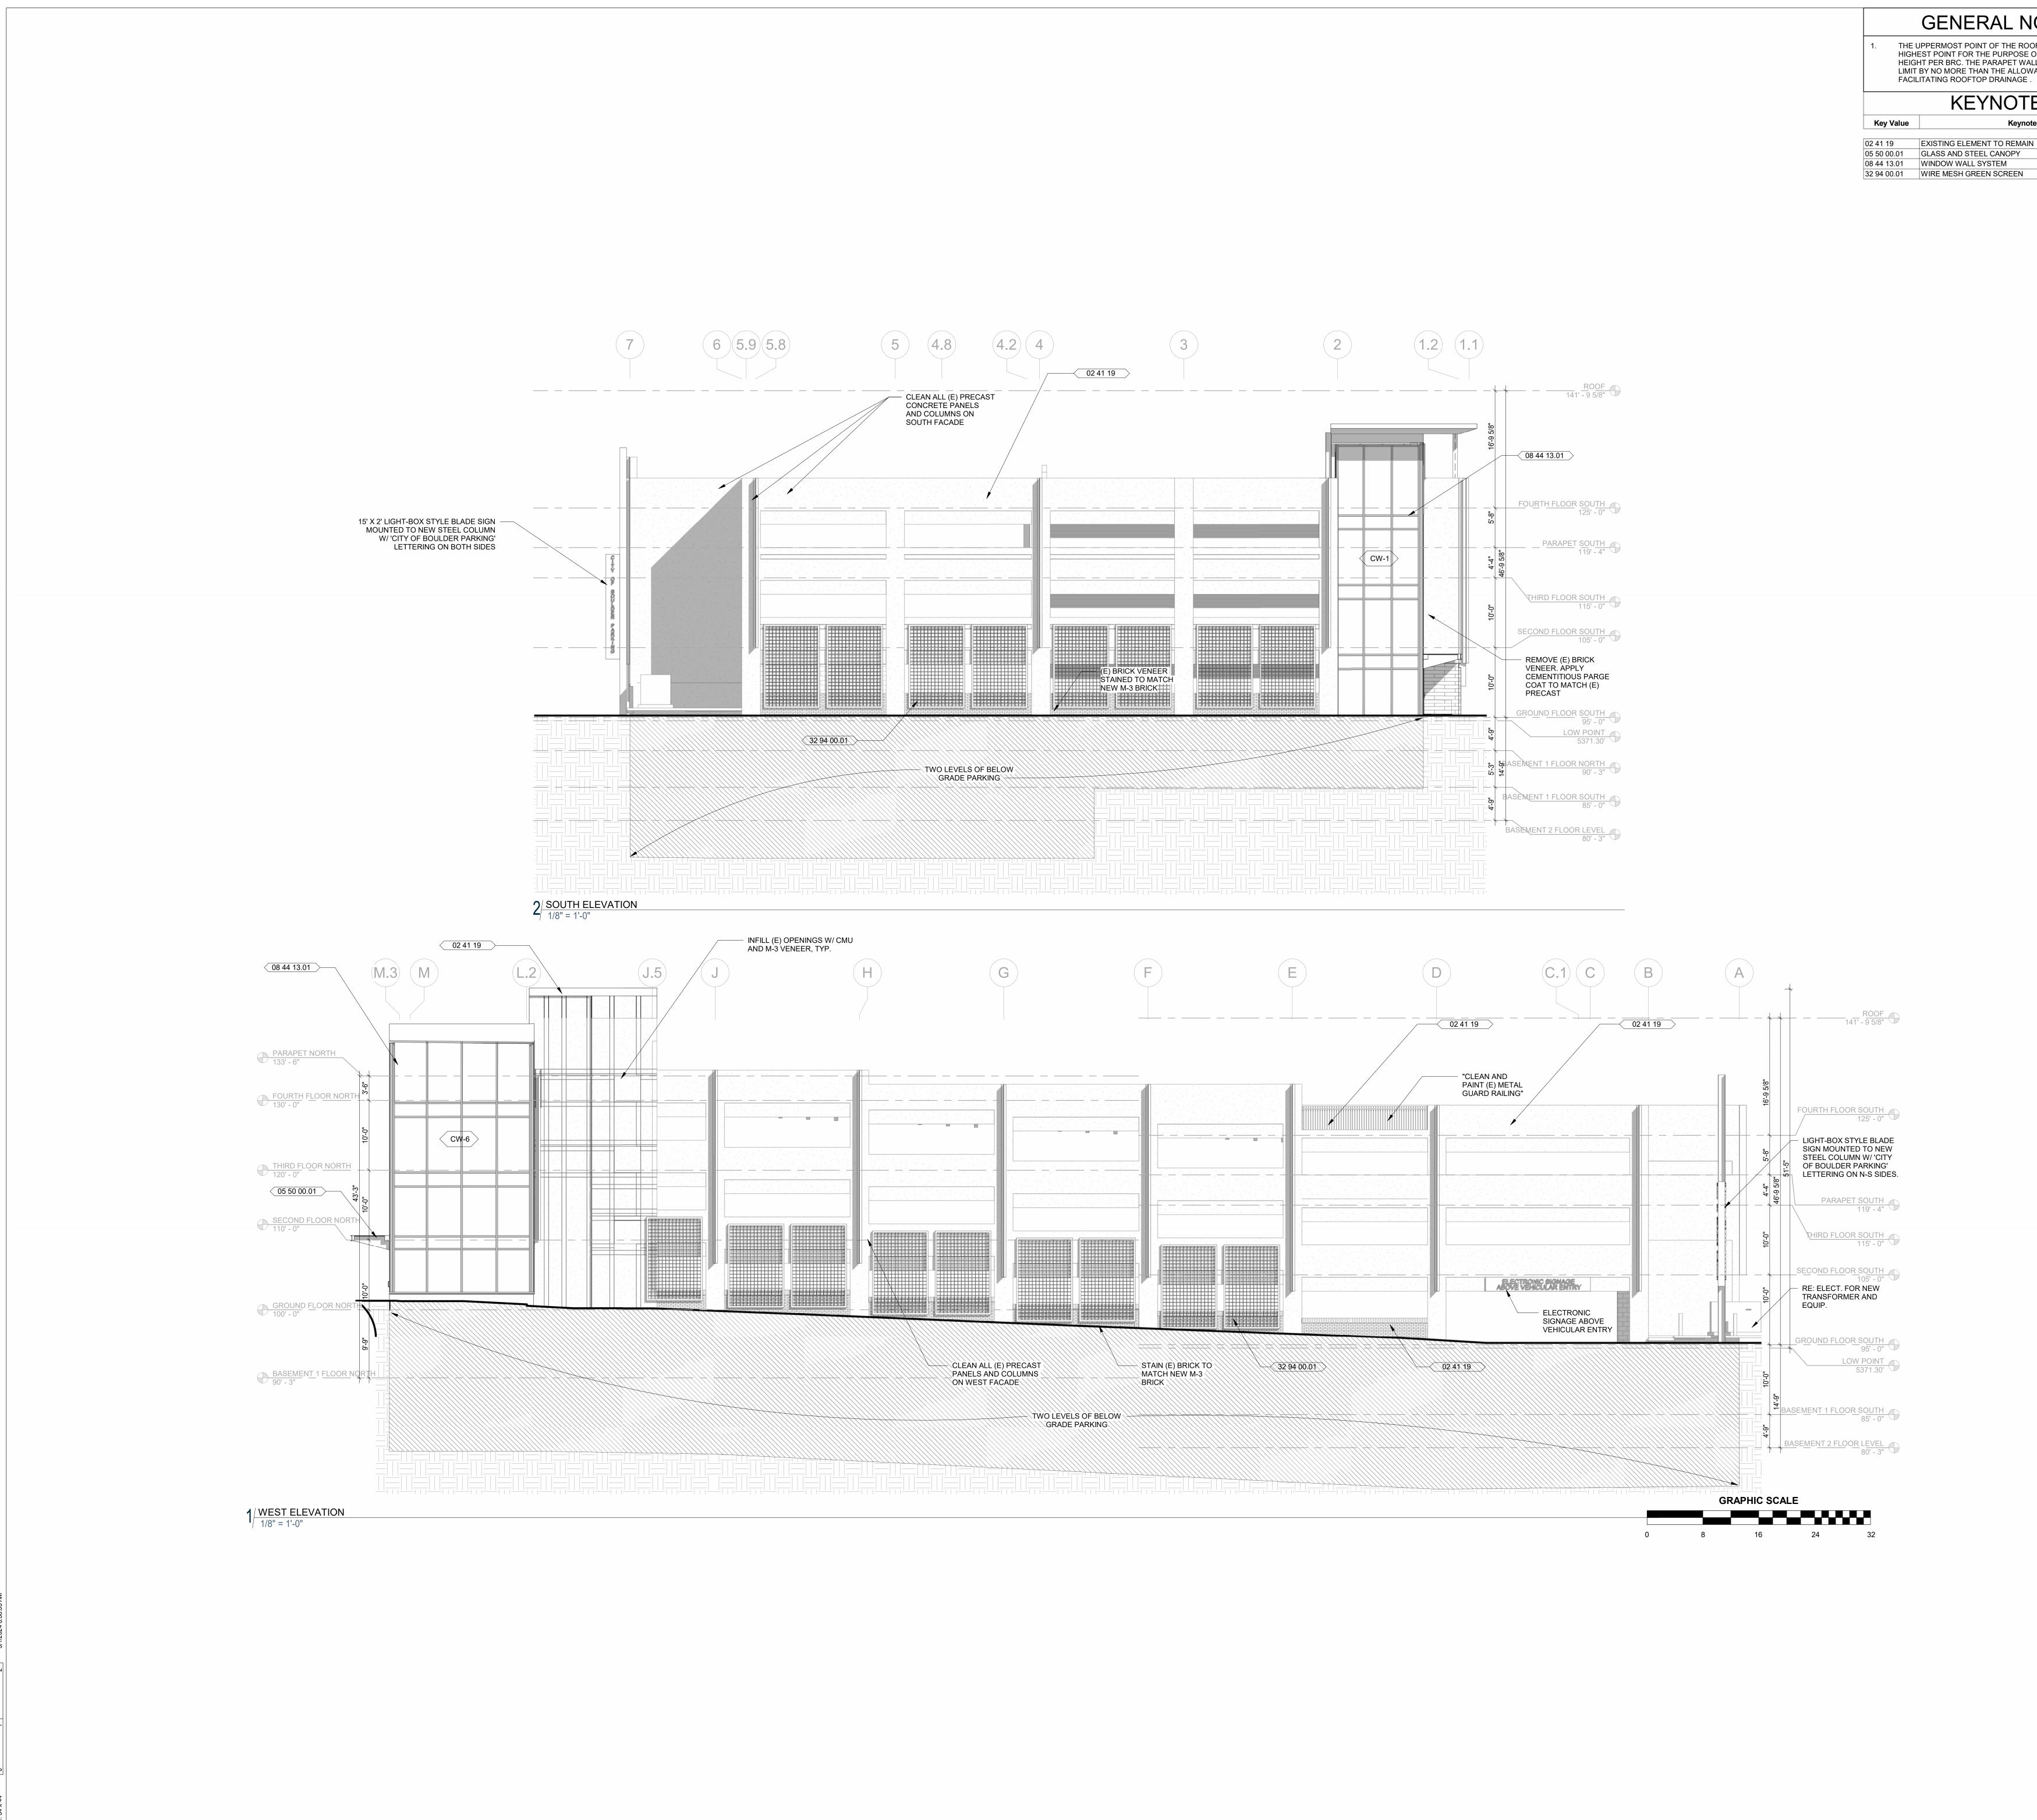
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ENTITLEMENTS STUDIO ARCHITECTURE 2995 55TH STREET, #17983 BOULDER, CO 80301 T 720 491 1167

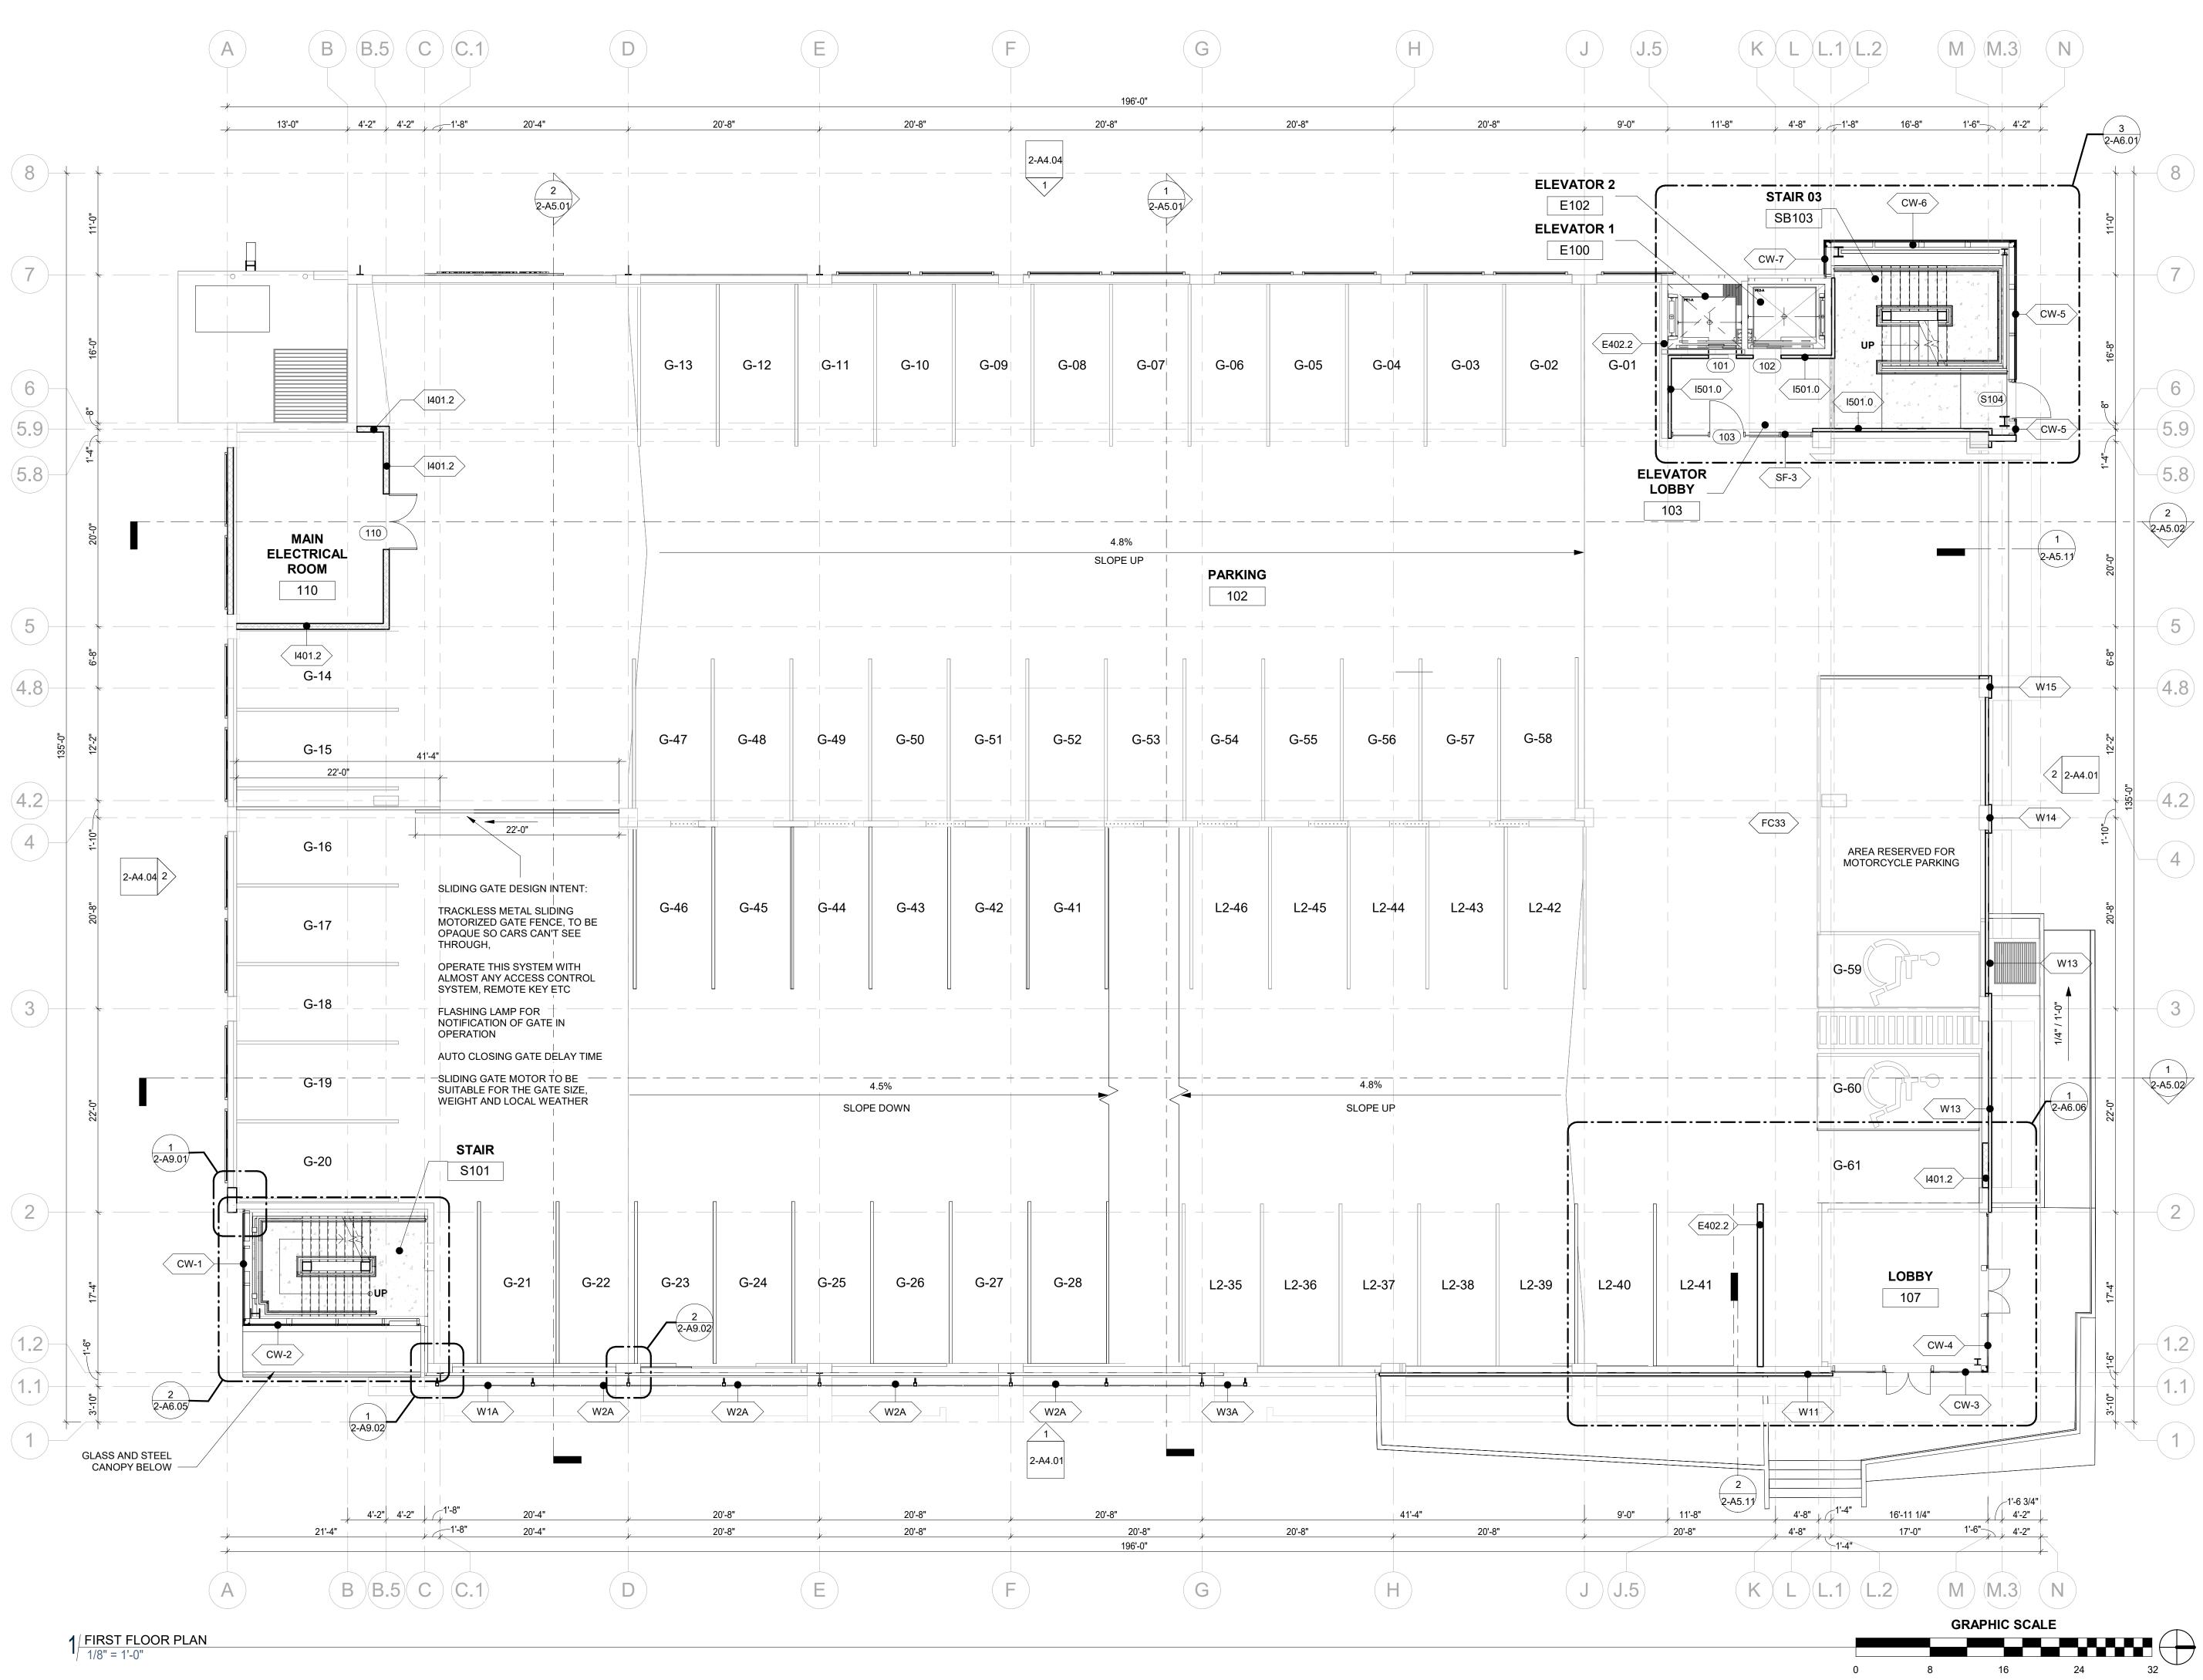LANDSCAPE STUDIO TERRA INC. 758 CLUB CIRCLE LOUISVILLE, CO 80027 T 303 494 9138

STRUCTURAL ANTHEM STRUCTURAL ENGINEERS FLATIRON OFFICE PARK 2213 CENTRAL AVENUE BOULDER, CO 80301
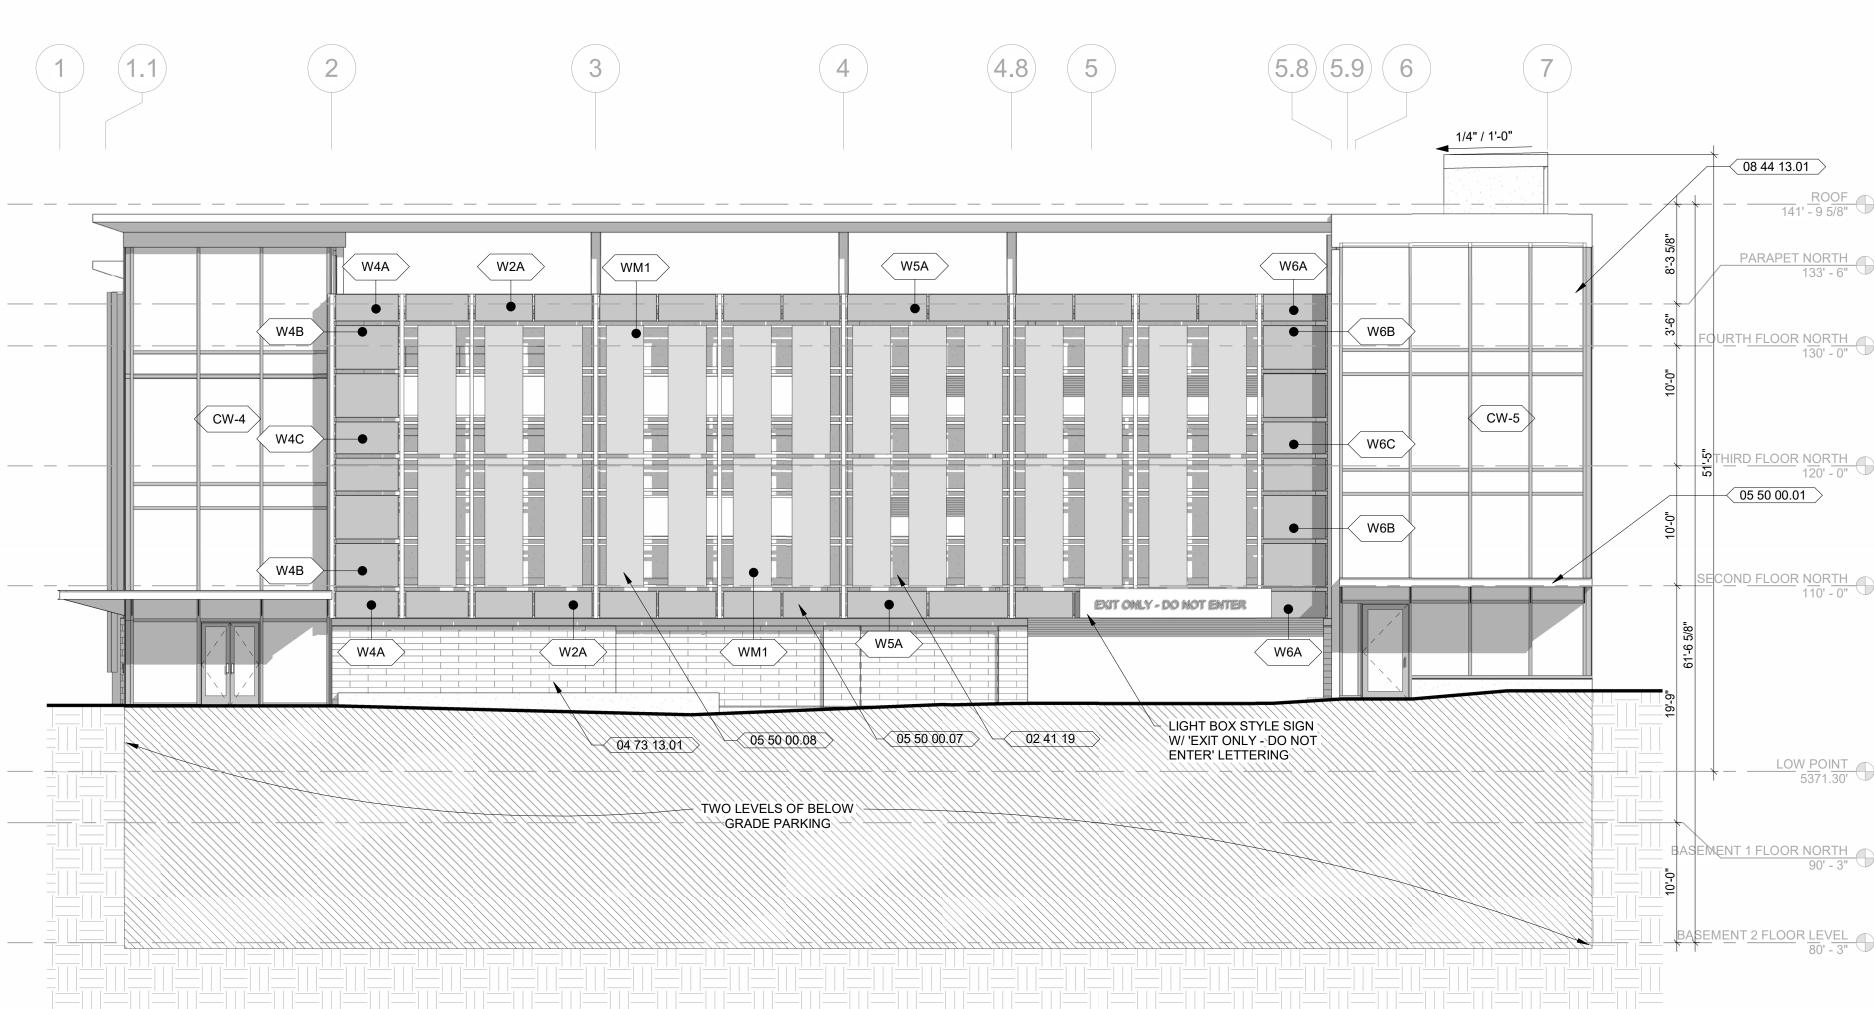
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AV/TECHNOLOGY/SECURITY SALAS O'BRIEN 4900 NAUTILUS CT. N. SUITE 200 BOULDER, CO 80301 T 303 865 5500

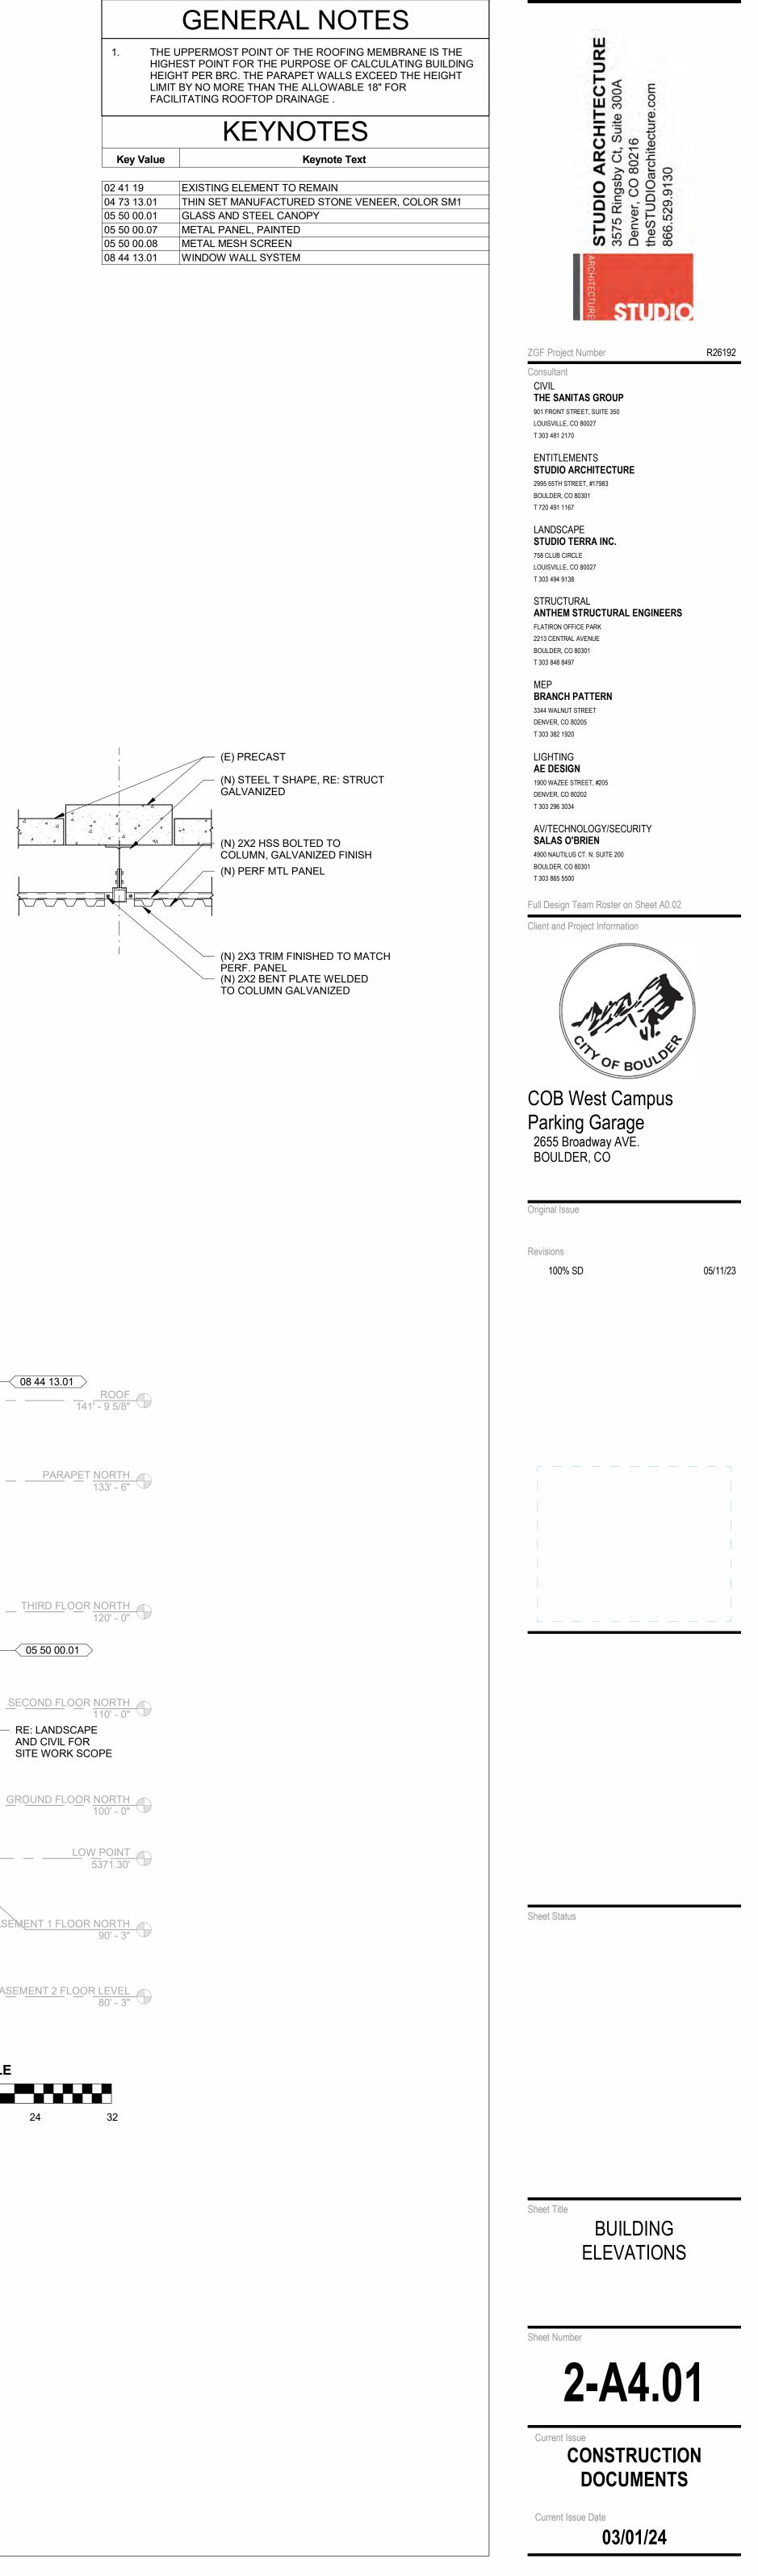Full Design Team Roster on Sheet A0.02 Client and Project Information
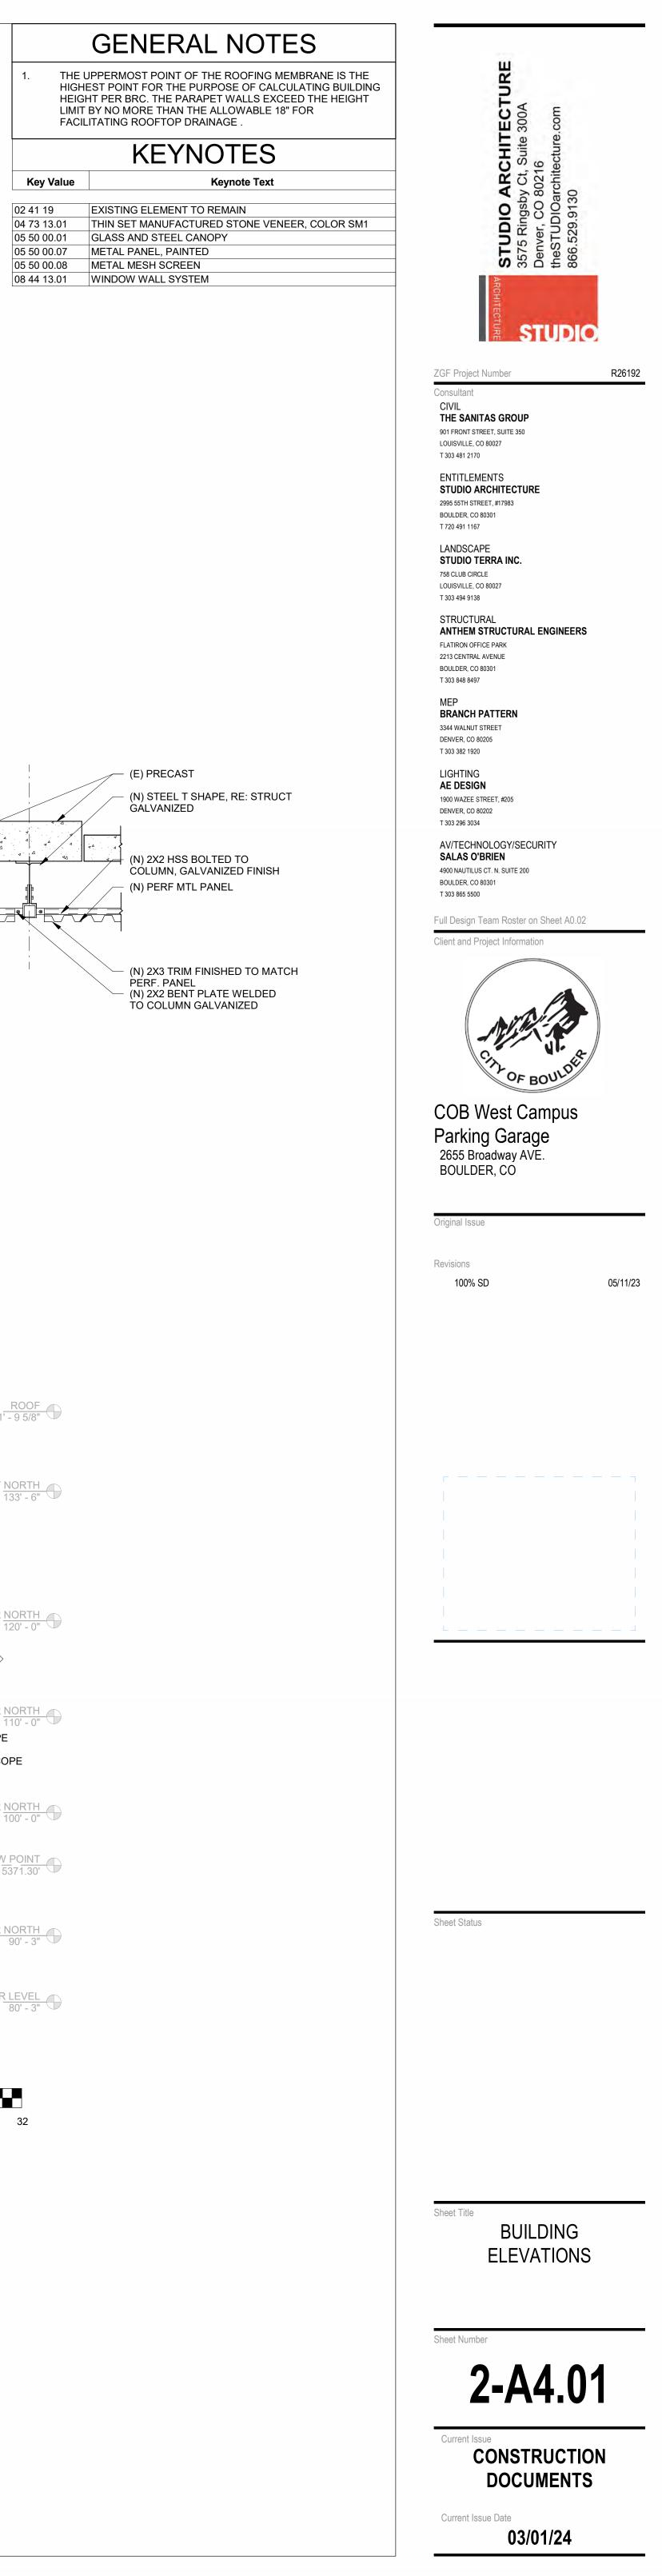
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COB West Campus Parking Garage 2655 Broadway AVE. BOULDER, CO

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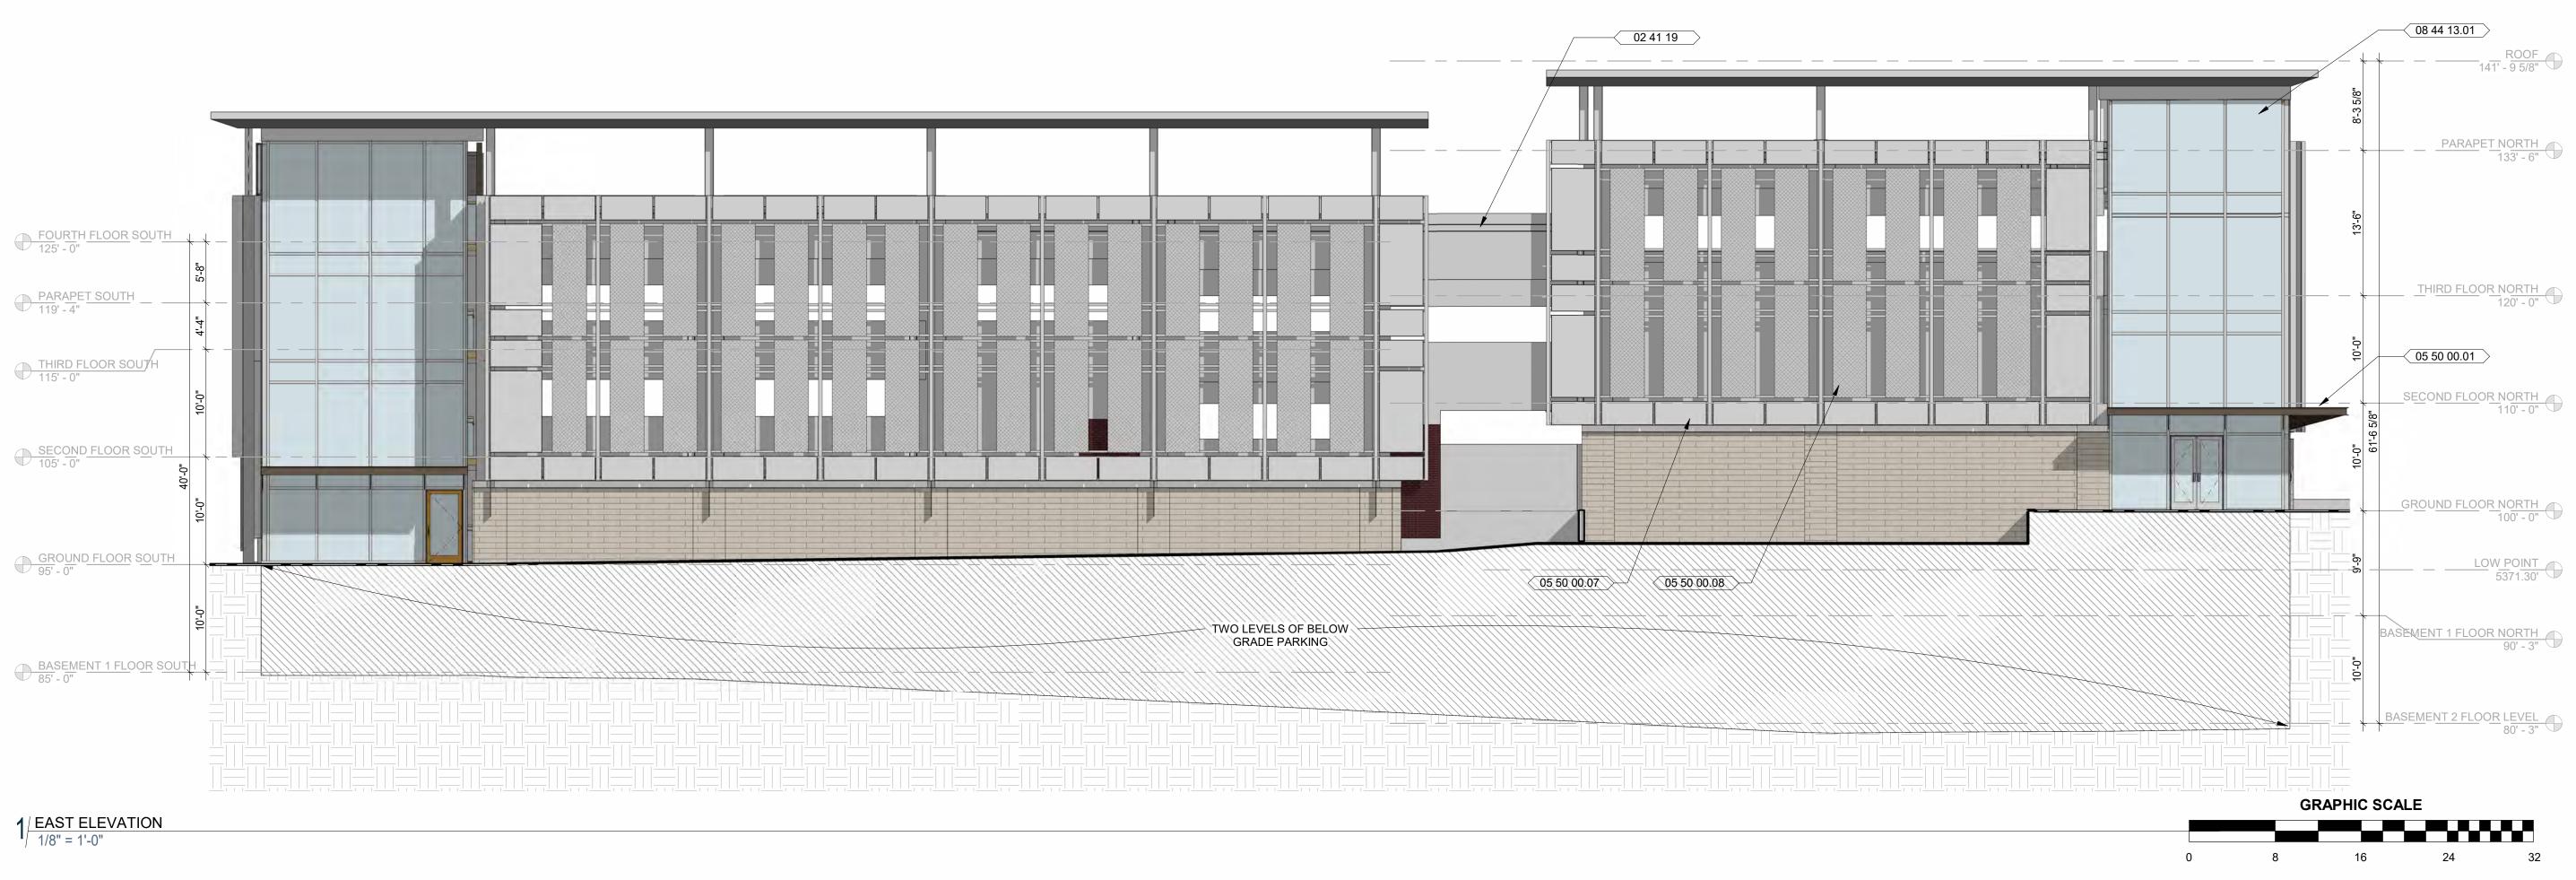
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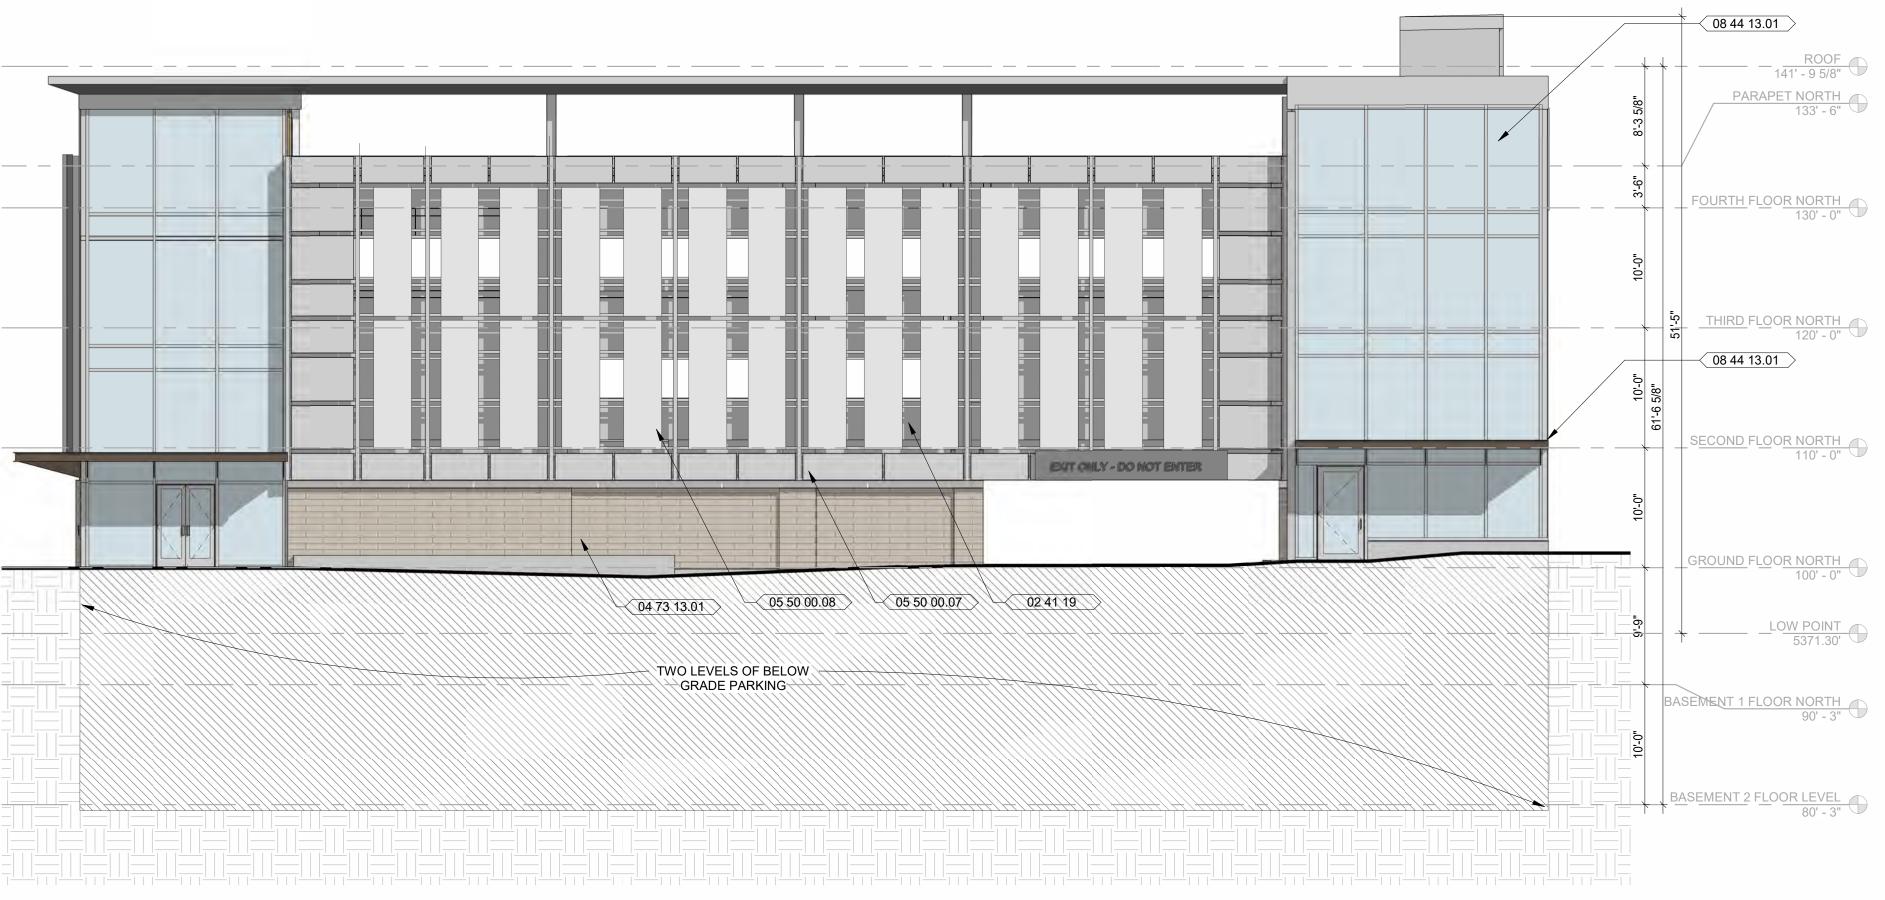
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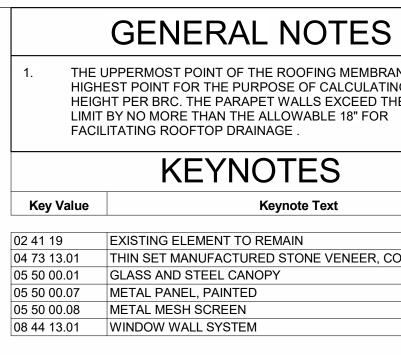






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### GENERAL NOTES

THE UPPERMOST POINT OF THE ROOFING MEMBRANE IS THE HIGHEST POINT FOR THE PURPOSE OF CALCULATING BUILDING HEIGHT PER BRC. THE PARAPET WALLS EXCEED THE HEIGHT

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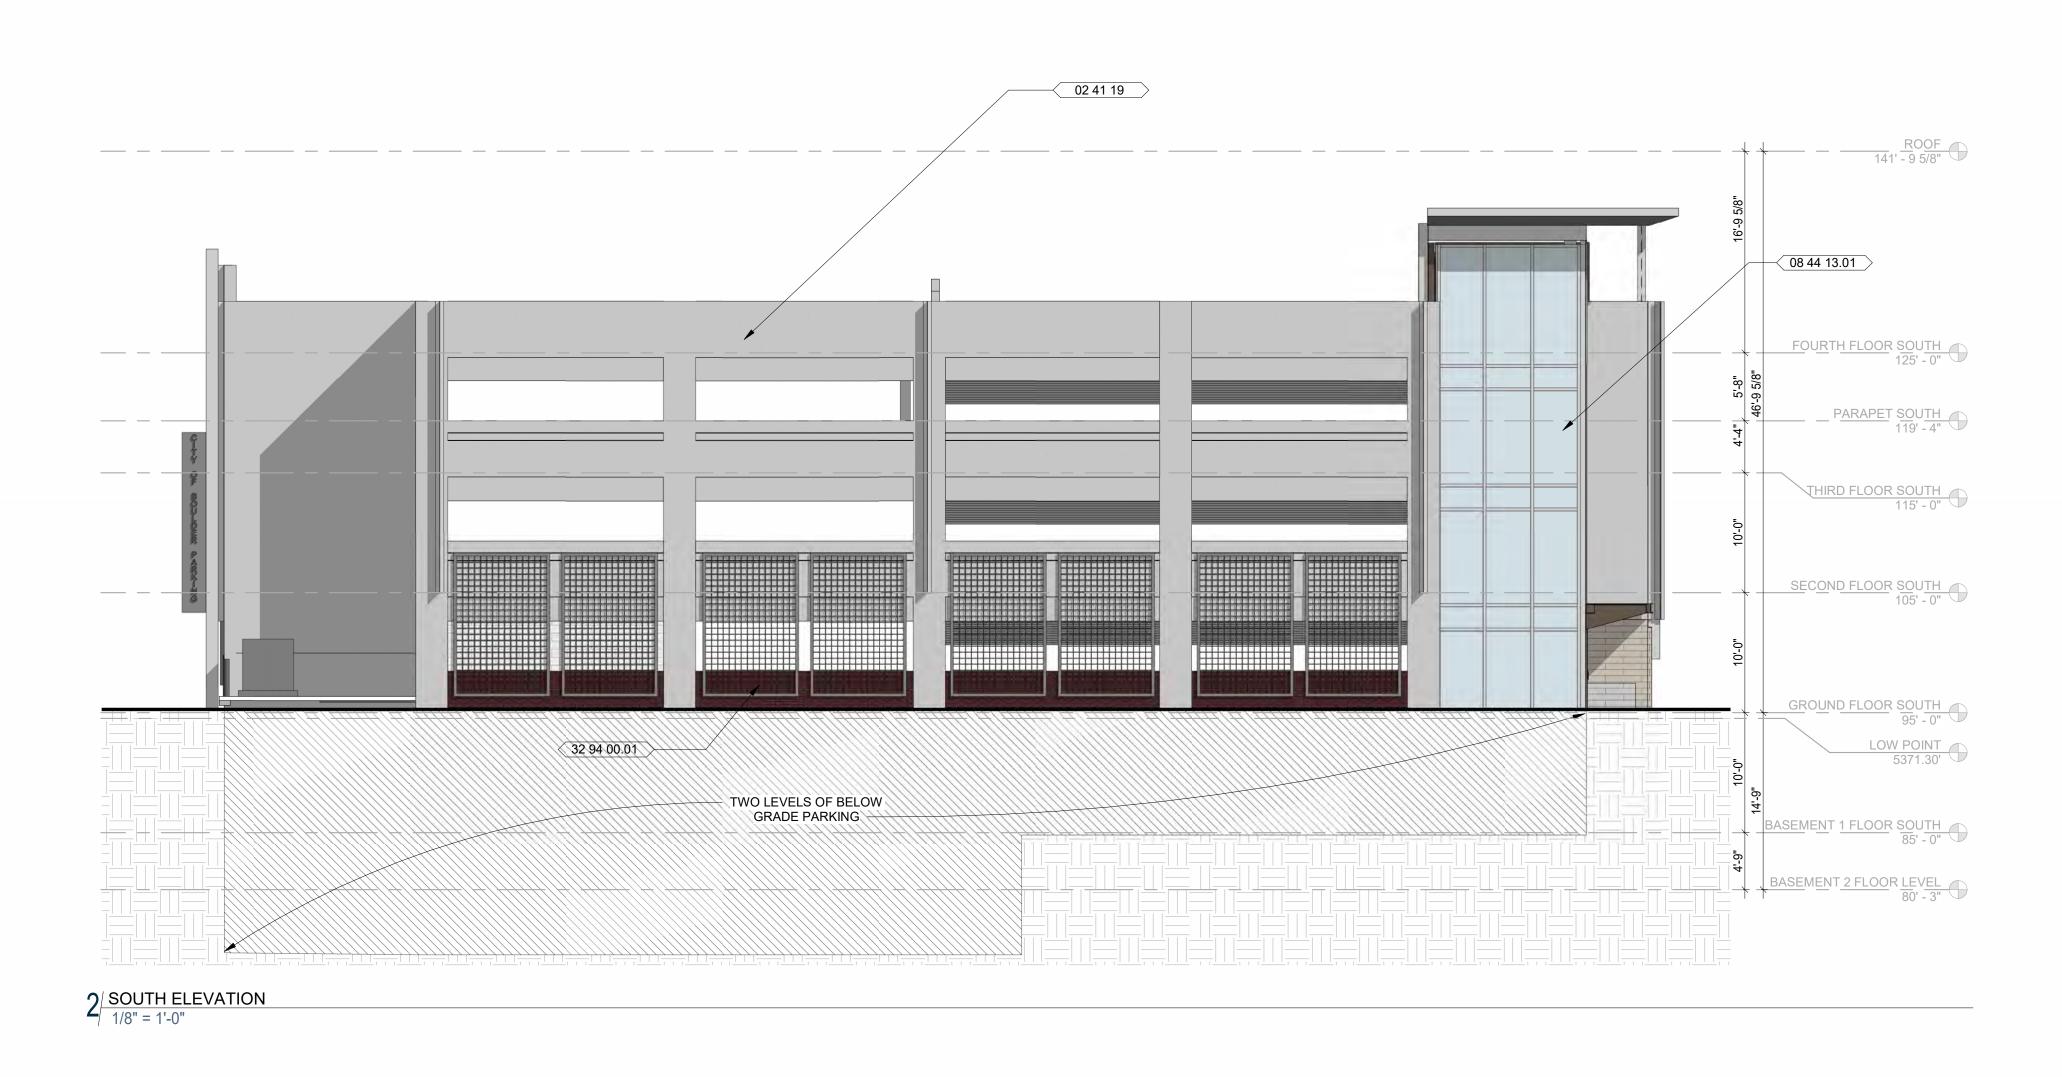
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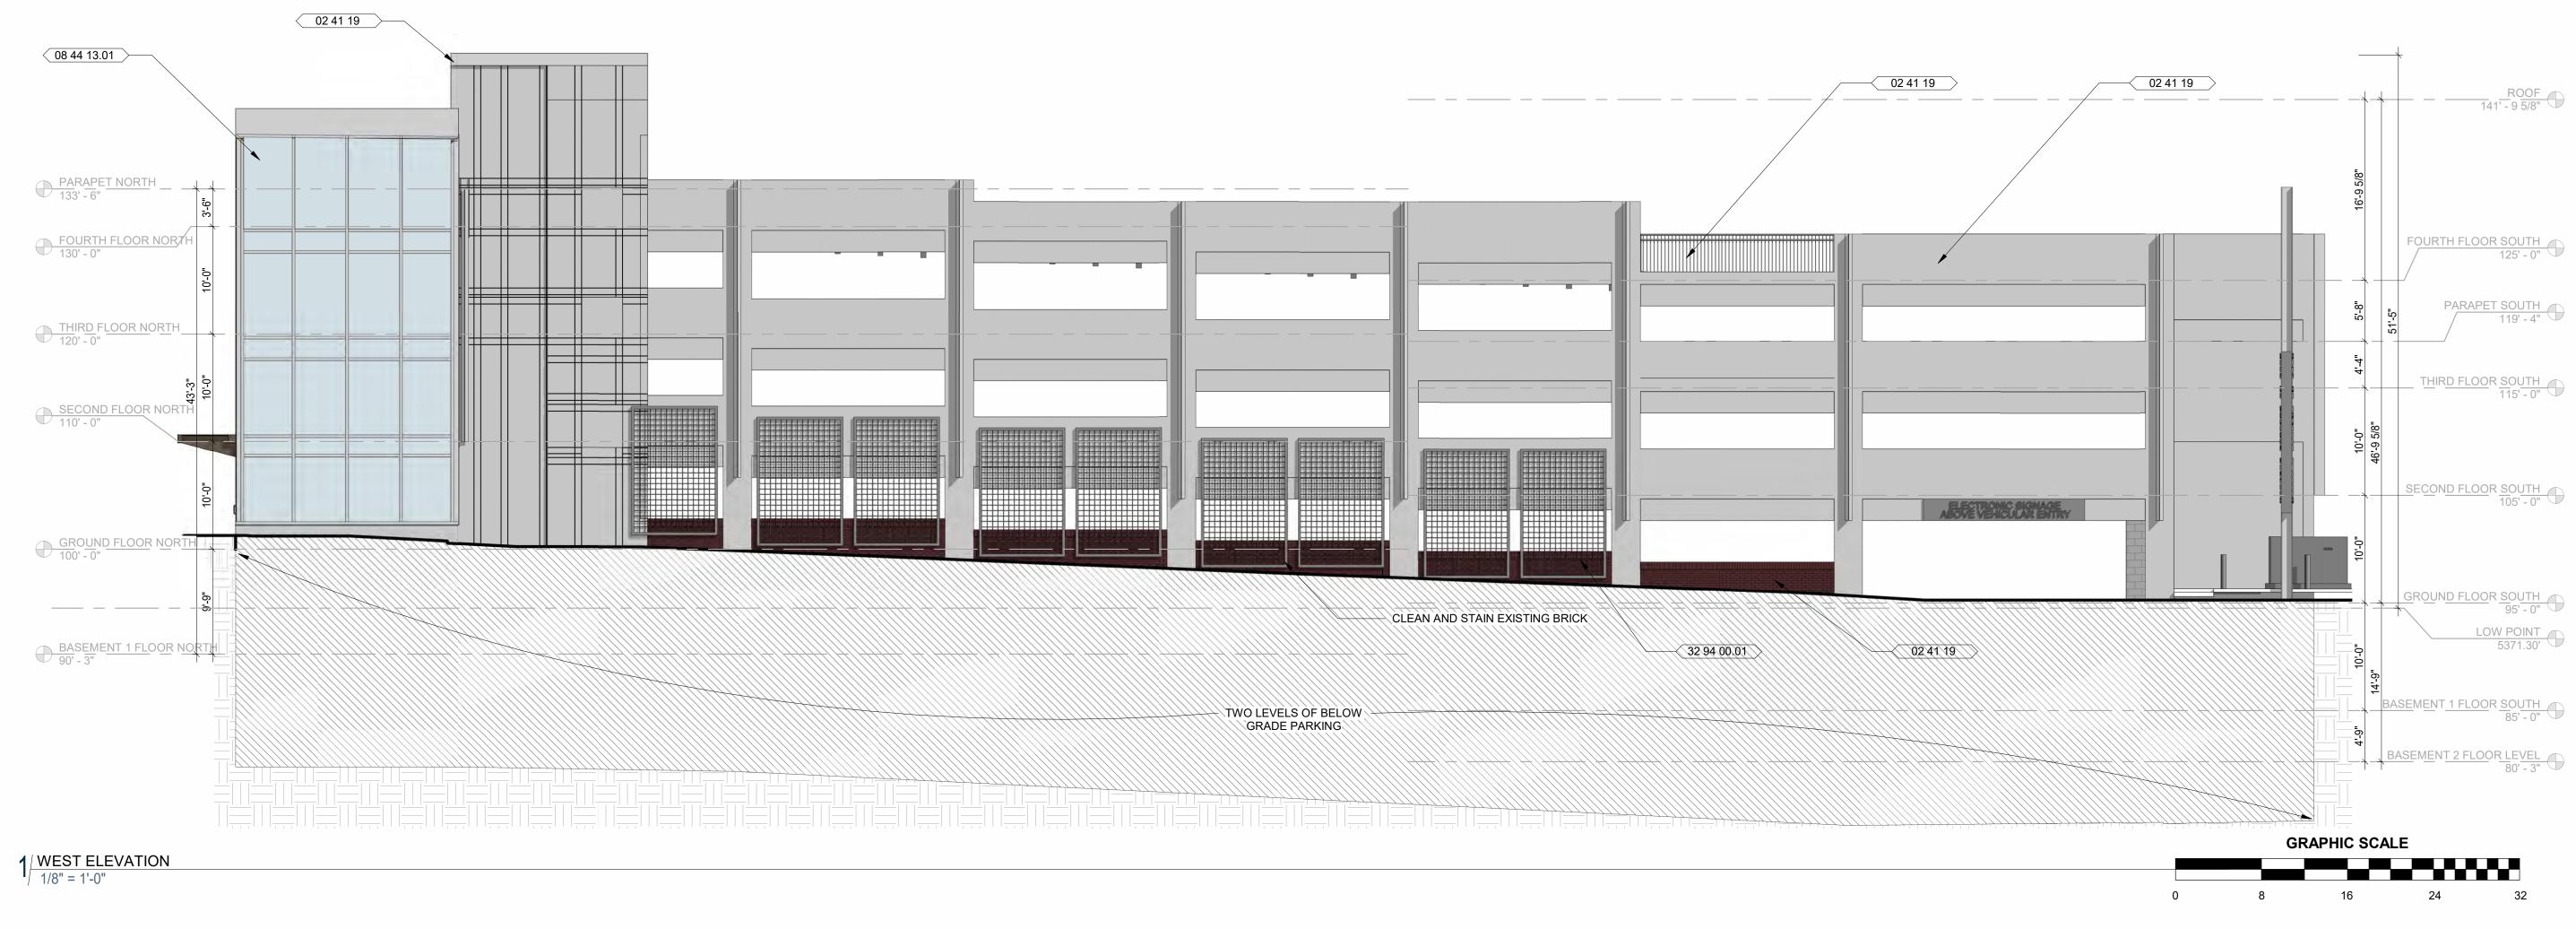
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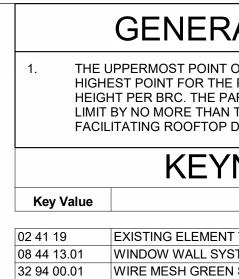


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Full Design Team Roster on Sheet A0.02

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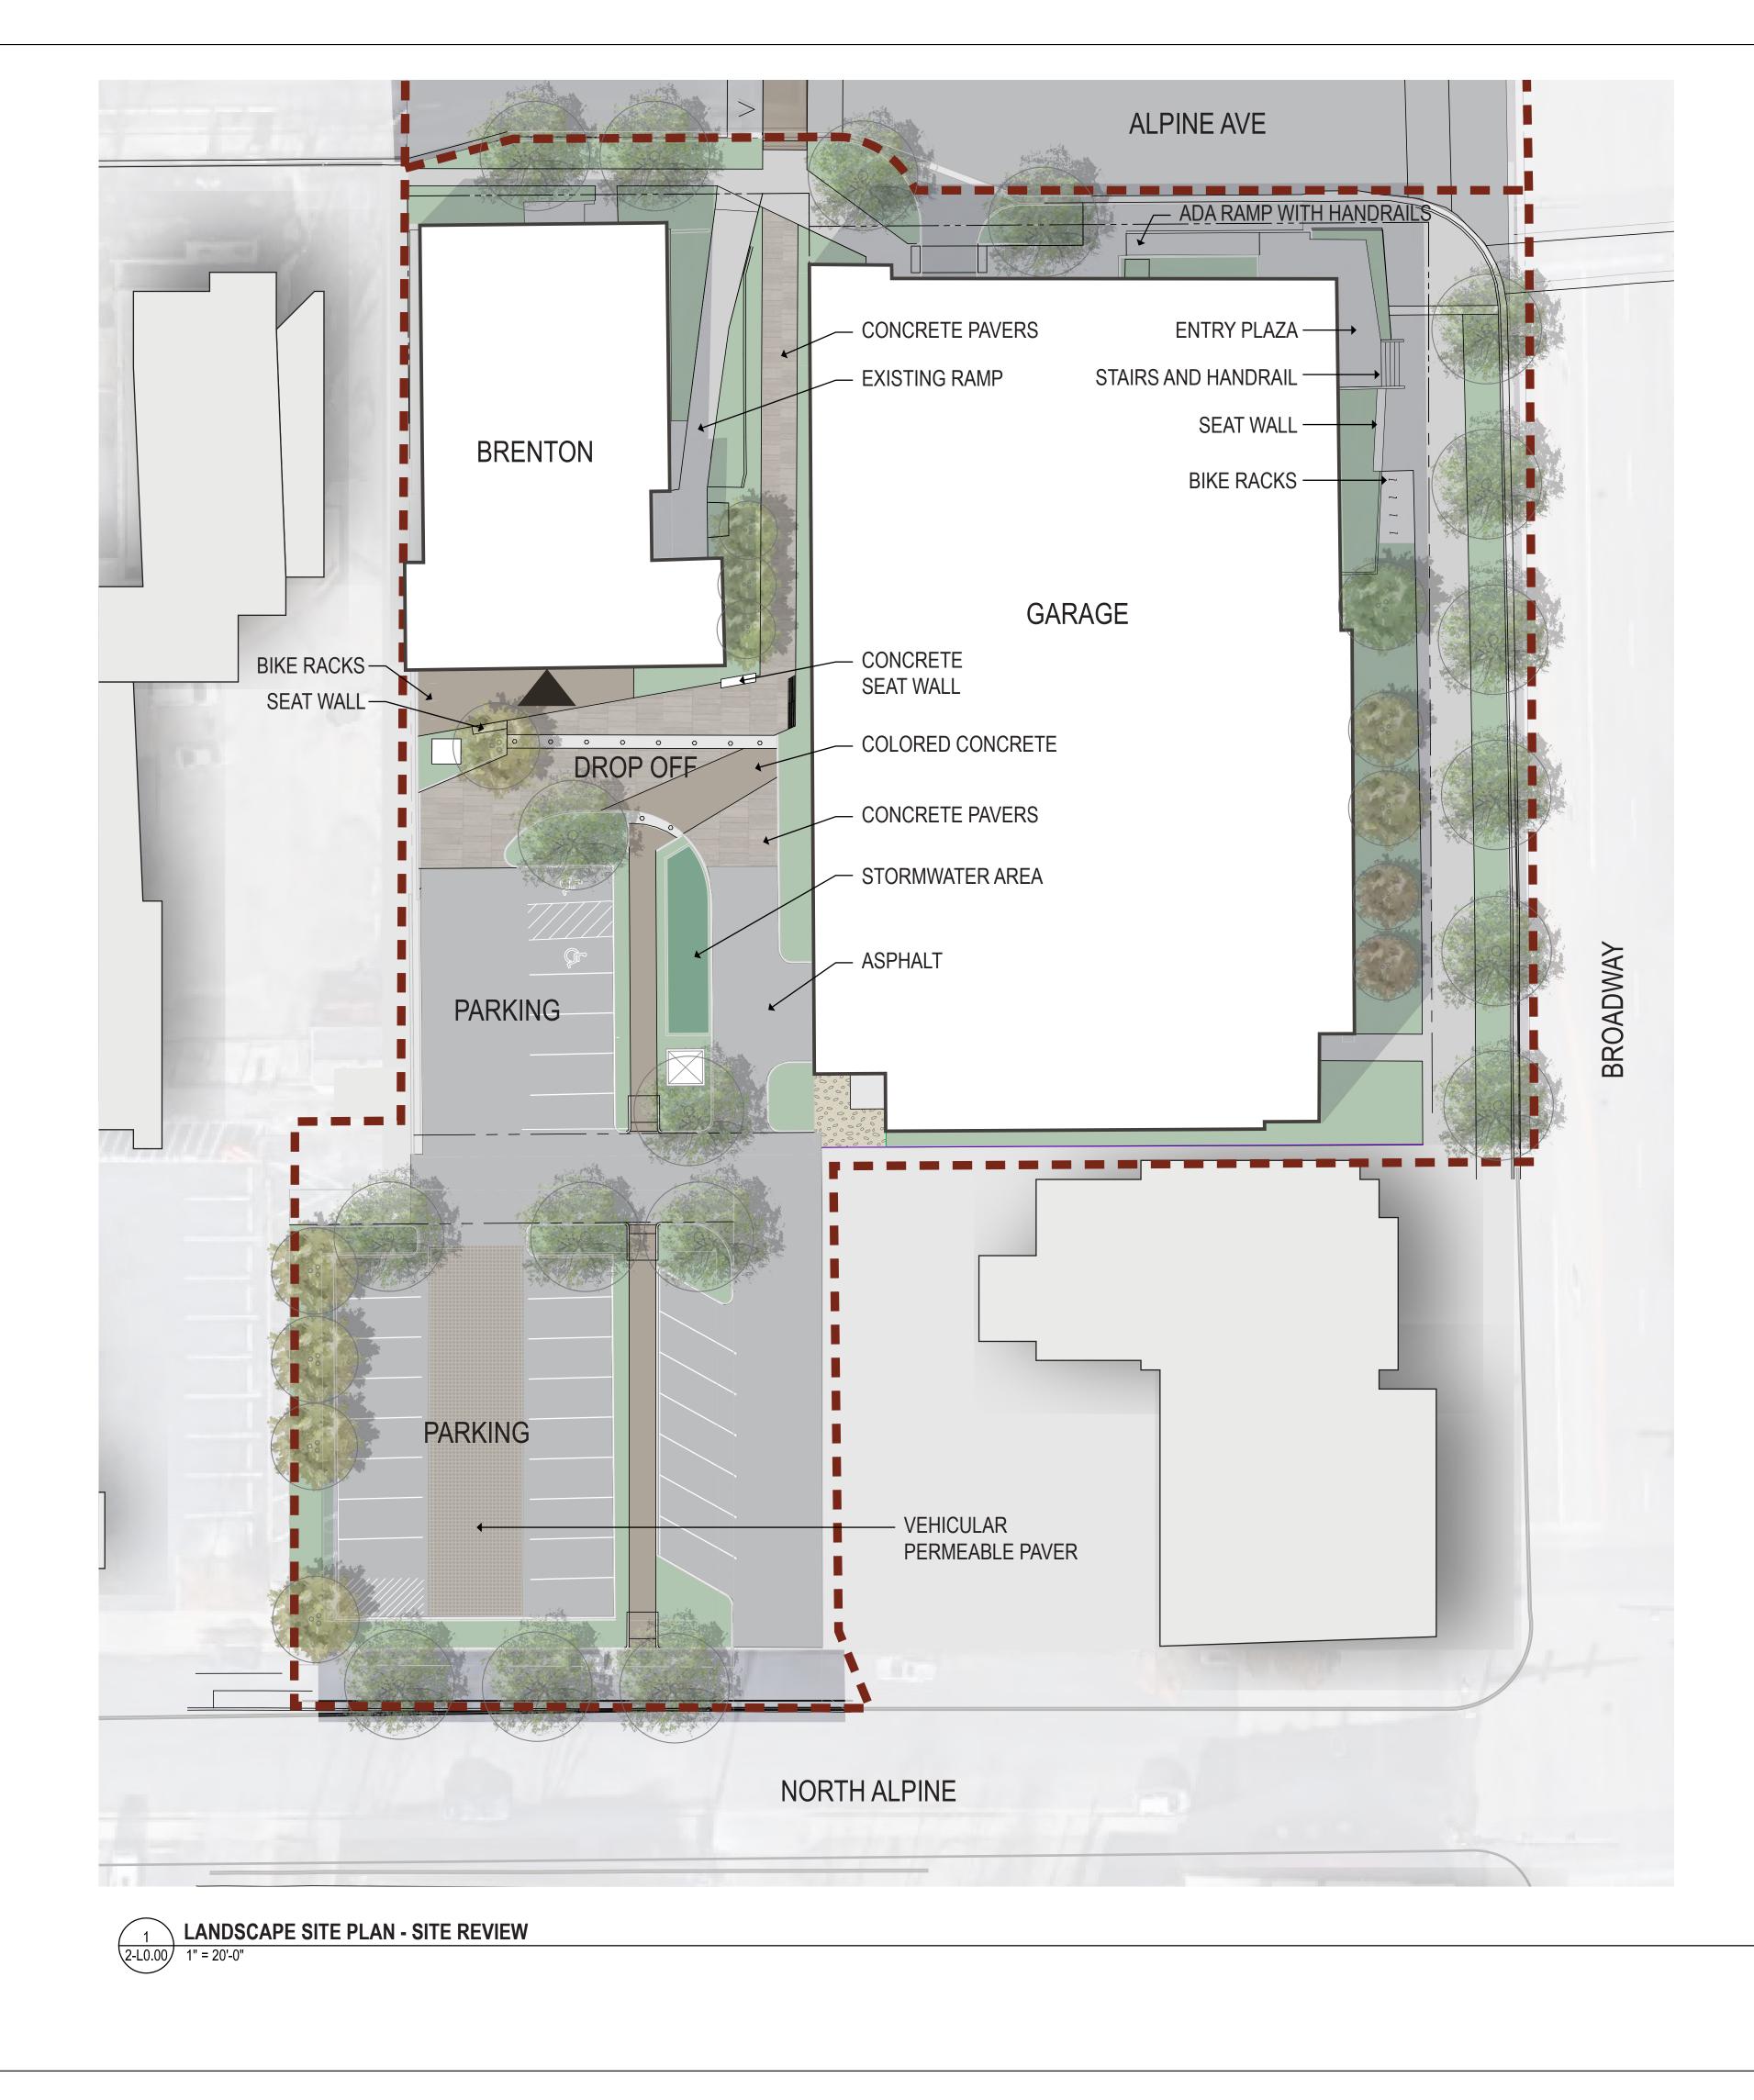


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CIVIL THE SANITAS GROUP 901 FRONT STREET, SUITE 350 LOUISVILLE, CO 80027 T 303 481 2710

ENTITLEMENTS STUDIO ARCHITECTURE 2995 55TH STREET, #17983 BOULDER, CO 80301 T 720 491 1167 LANDSCAPE

STUDIO TERRA INC. 758 CLUB CIRCLE LOUISVILLE, CO 80027 T 303 494 9138

STRUCTURAL ANTHEM STRUCTURAL ENGINEERS FLATIRON OFFICE PARK 2213 CENTRAL AVENUE BOULDER, CO 80301 T 303 848 8497 MEP

**BRANCH PATTERN** 3344 WALNUT STREET DENVER, CO 80205 T 303 382 1920

LIGHTING AE DESIGN 1900 WAZEE STREET, #205 DENVER, CO 80202 T 303 296 3034

AV/TECHNOLOGY/SECURITY SALAS O'BRIEN 4900 NAUTILUS CT. N. SUITE 200 BOULDER, CO 80301 T 303 865 5500

Full Design Team Roster on Sheet 1-G0.01 Client and Project Information



Boulder Western City Campus - Volume 2 Garage & Brenton 2655 BROADWAY Boulder, CO 80302

Original Issue

Key Plan and Orientation

Revisions

Sheet Status NOT FOR CONSTRUCTION


Sheet Title

OVERALL SITE PLAN -SITE REVIEW

Sheet Number




Current Issue SITE REVIEW

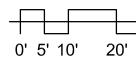









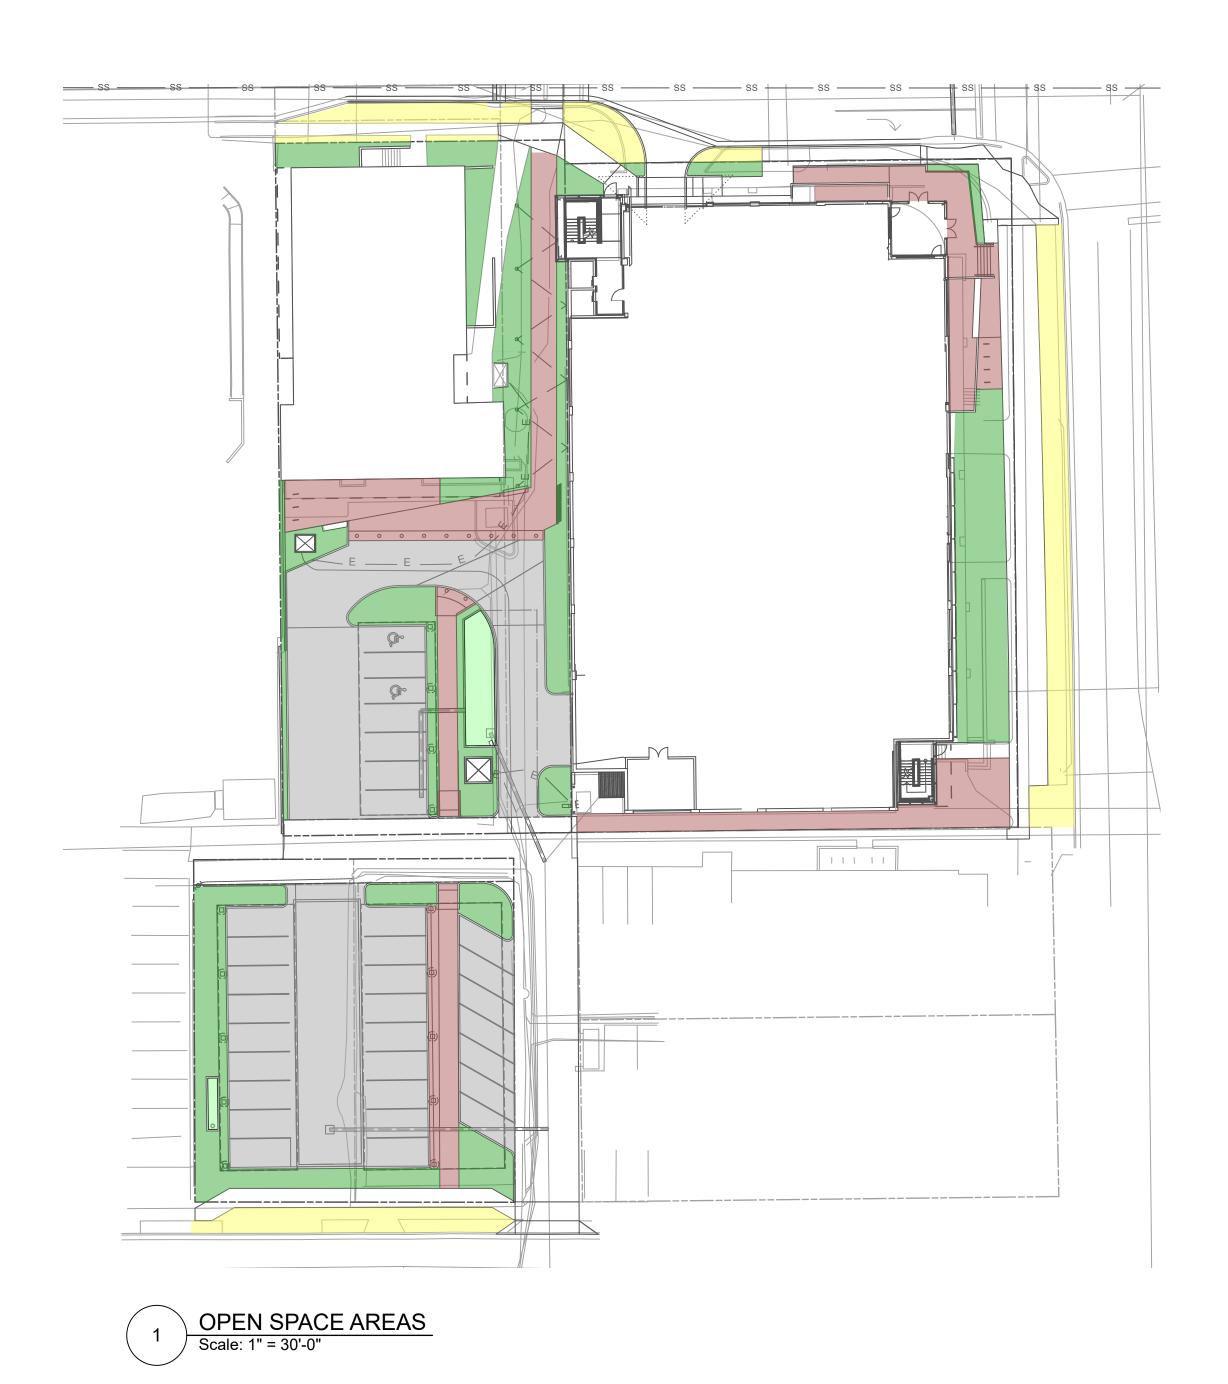

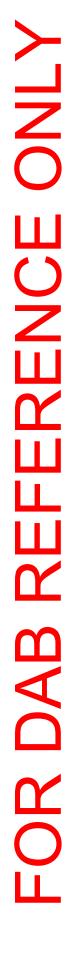



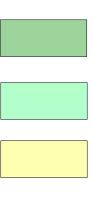

LANDSCAPE

LANDSCAPE - WATER QUALITY PLANTER

ROW LANDSCAPE - NOT INCLUDED IN OS CALC

HARDSCAPE - ENHANCED PAVING

Western City Campus **Open Space Calculation - South of Alpine** 10/1/23

PUBLIC ZONE CALCULATION

20% of Total Land Area

**Open Space** 

Total Land Area = 58,208 SFInterior ground floor OS can count up to 50% of required**11,642 SF required (20%)13,949 SF provided (24%)** 

### Actual Can Count

1	Landscape				
	Site Landscape	5,990	5,990	SF	
	Rain Gardens (WQ Features)	362	362	SF	
2	Hardscape				
	Enhanced paving	7,597	7,597	SF	
		13,949	13,949	SF	

Α

Landscape Requirements

1 Tree/5 Shrubs for each 1,500 SF not covered by building or parking

Trees	12	12	
	Required	Provided	
Remaining	18,208	SF	
Total Parking Coverage	11,715	SF	
Total Building Coverage	28,285	SF	
Total Site	58,208	SF	

B Sod Quantity - no sod anticipated on this project.

### Street trees - one tree every 40 LF

Street Frontage			Required	Provided
Alpine Ave	214	LF	5	4
Broadway	188	LF	5	6
North Street	99	LF	2	3

### D

С

### Parking Lot Landscape

5% required of 10,645 SF	Required		Provided	
Interior Prkg Lot Landscape	532	SF	1,122	SF
Interior Trees 1/200 SF	3	EA	3	EA
Parking Lot Screening Trees	4	EA	4	EA
Parking Lot Screening	42" screen		42" screen	

ub beds provided

4 More trees not possible due to narrow width of ROW/Sidewalk at Broadway intersection. Extra trees on Broadway and North provided.

# STUDIO ARCHITECTURE 3575 Ringsby Ct, Suite 300A Denver, CO 80216 theSTUDIOarchitecture.com 866.529.9130

### Consultant

CIVIL THE SANITAS GROUP 901 FRONT STREET, SUITE 350 LOUISVILLE, CO 80027 T 303 481 2710

STUDIO

ENTITLEMENTS STUDIO ARCHITECTURE 2995 55TH STREET, #17983 BOULDER, CO 80301 T 720 491 1167

LANDSCAPE STUDIO TERRA INC. 758 CLUB CIRCLE LOUISVILLE, CO 80027 T 303 494 9138


STRUCTURAL ANTHEM STRUCTURAL ENGINEERS FLATIRON OFFICE PARK 2213 CENTRAL AVENUE BOULDER, CO 80301 T 303 848 8497

MEP BRANCH PATTERN 3344 WALNUT STREET DENVER, CO 80205 T 303 382 1920

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AV/TECHNOLOGY/SECURITY SALAS O'BRIEN

4900 NAUTILUS CT. N. SUITE 200 BOULDER, CO 80301 T 303 865 5500 Full Design Team Roster on Sheet 1-G0.01

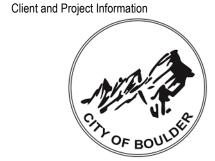

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Original Issue

Key Plan and Orientation

## Revisions

Sheet Status NOT FOR CONSTRUCTION

Sheet Title

SITE REVIEW LANDSCAPE COMPLIANCE




Current Issue

11/03/2023

Current Issue Date



RENDERING - NORTH PARKING GARAGE ENTRANCE AND SOUTH PASEO

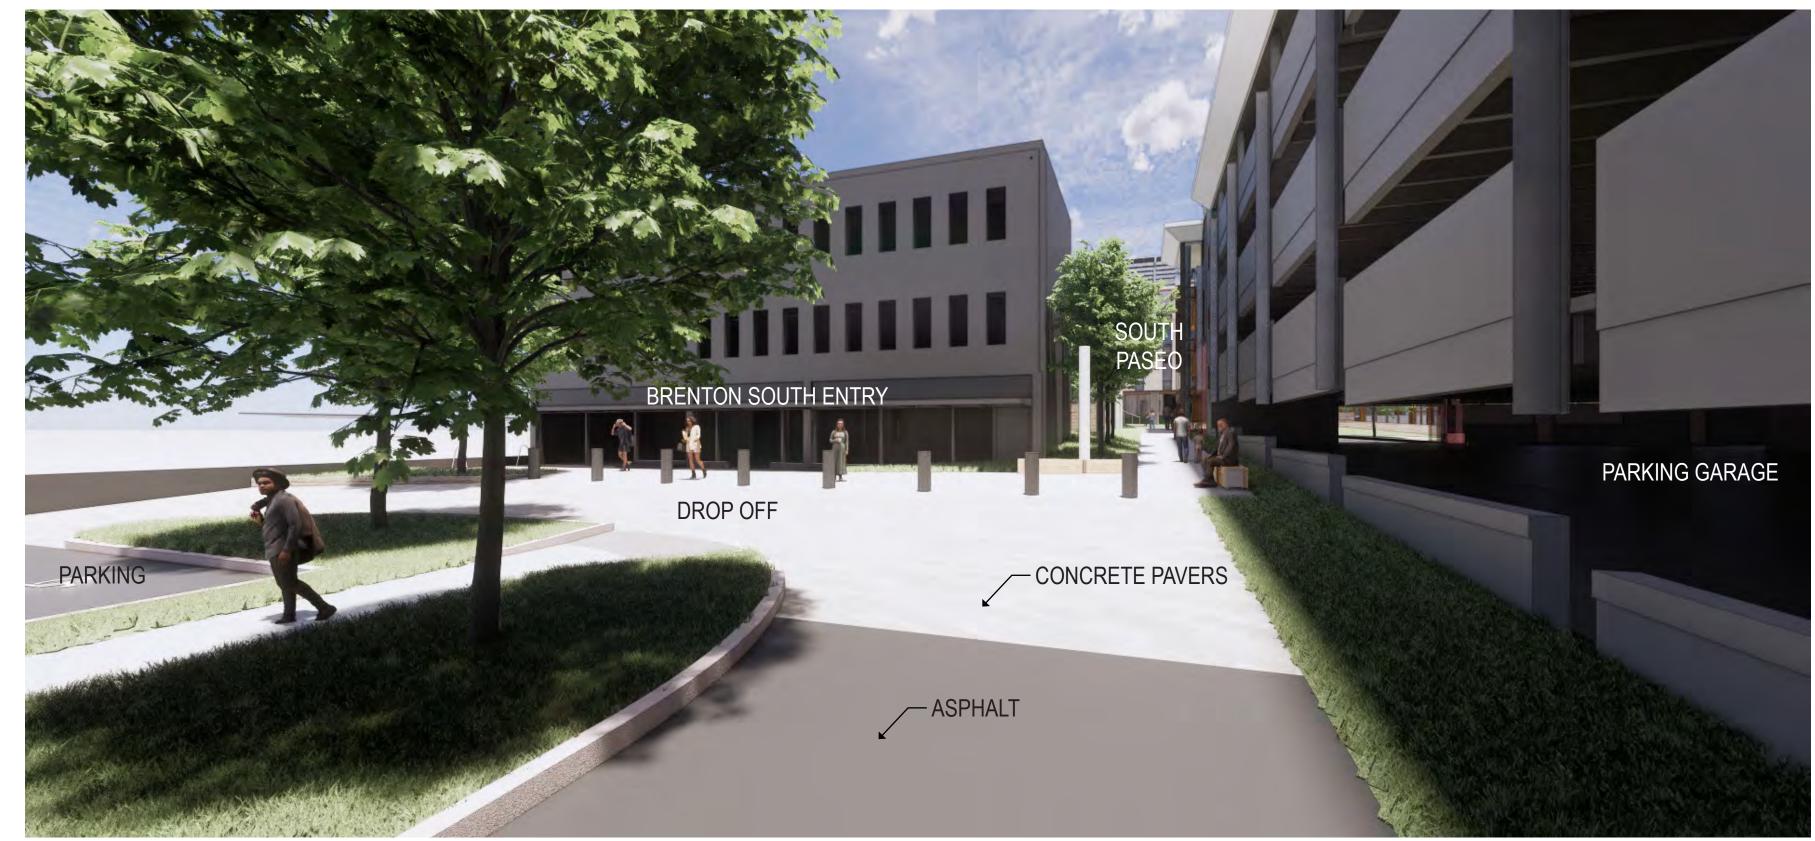

RENDERING - BRENTON SOUTH ENTRANCE AND DROP-OFF ZONE

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# STUDIO Consultant

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<sup>Sheet Status</sup> NOT FOR CONSTRUCTION

Sheet Title

3D VIEWS - SOUTH PASEO

Sheet Number



Current Issue SITE REVIEW

### CITY OF BOULDER **DESIGN AND CONSTRUCTION STANDARDS 3.05 Tree Protection for Construction Sites**

(A) Tree Protection Required (1) An applicant for construction approval shall protect trees and plants in the public right-of-way and on any project or construction site where public improvements are proposed.

(2) An applicant for construction approval shall submit a landscaping plan incorporating proposed tree protection measures for any existing trees located in the public right-of-way and on site at any project or construction site where public improvements are proposed in compliance with these Standards.

(3) The landscaping plan shall identify any potential detrimental effects to existing trees that might result from proposed construction activities within 20 feet of the dripline of any existing trees located on site or in the adjacent public right-of-way. The plan shall include the species, size, and location of all existing trees that are 1-inch or larger caliper size. If no existing trees are present that require protection, this shall be noted on the plan. Existing trees approved to be removed or relocated shall be clearly identified on the landscaping plan. (4) The applicant for construction approval shall notify the City within 24-hours of any suspected damage to trees resulting from construction activities. If damage occurs during construction, the applicant shall have the damaged tree restored immediately by a qualified

arborist. (B) Tree Protection Procedures

(1) Protective Maintenance: An applicant for construction approval shall provide maintenance and care for existing trees required to be protected on site and in the public right-of-way adjacent to any project or construction site during construction activities and the public improvement warranty period to ensure that existing trees survive and are not damaged. (2) Soil Compaction Prevention

(a) To prevent soil compaction, designated routes for equipment and foot traffic by work crews shall be determined prior to commencing construction activities and indicated in the landscaping tree protection plan.

(b) These planned routes shall be marked at the site before construction commences with durable fencing material that is at least 4 feet high. Flagging tape or any other material that may be torn down, moved, or evaded is not acceptable.

(c) The contractor shall inform all construction crew members on the site of access routes and will ensure that only these routes are used.

(d) To prevent tree root smothering, no soil stockpiles, supplies, equipment, or any other material shall be placed or stored within a tree dripline or within 15 feet of the tree trunk for column-shaped trees, whichever distance is greater(e) Soil around a tree dripline may be required to be aerated during and after

construction activities. This is necessary even when compaction results from heavy foot traffic. A professional arborist shall do the vertical aeration or soil fracturing. Oil fracturing techniques comparable to using a "growgun" with Isolite material are acceptable. Conventional turf aeration is not acceptable

(f) When foot traffic or equipment use is unavoidable within the dripline, the area within the dripline shall be mulched with wood chips to a depth of 6 inches before construction activity begins. A 6-inch mulch depth shall be maintained for the

duration of the project, then removed when construction activities are completed. (3) Root Protection

(a) Tree roots shall not be cut unless cutting is unavoidable.

(b) When root cutting is unavoidable, a clean, sharp cut shall be made to avoid shredding or smashing. Root cuts should be made back to a lateral root.

(c) Whenever possible, tree roots should be cut between late fall and bud opening, when root energy supplies are high and conditions are least favorable for disease causing agents.

d) The City shall be notified of any cutting of the following roots:

Two roots having a diameter of more than 3 inches, or ) Four roots having diameters between 2 and 3 inches.

(e) Trenches shall be hand-dug within the dripline in areas where roots 2 inches and larger in diameter are present, and when low branches which may be damaged by equipment are present.

(f) Whenever possible, roots 2 inches or larger in diameter shall be tunneled or bored under and shall be covered to prevent dehydration. Exposed roots shall be covered immediately with soil or burlap and kept moist.

(g) Power tools shall not be used to prune roots, with the exception of arboriculturally approved root-cutting equipment used under the supervision of the City. Only the following approved tools shall be acceptable: scissors-type hand pruners and loppers, except anvil-types, and arborist-type pruning saws.

(h) When more than one root 2 inches or larger in diameter on any public tree is cut, supplemental watering shall be provided if the tree lacks an operational sprinkler system. The applicant or abutting landowner shall provide the watering.

(i) Sidewalk and paving surfaces shall be sufficiently contoured to avoid cutting surface tree roots. Whenever possible, tree roots should be bridged or floated over with walks.

(j) To allow maximum aeration and water penetration to roots, walk materials other than concrete may be selected (e.g., brick, flagstone, honeycomb block, chips, gravel) subject to City approval. Under no circumstances shall impervious material make contact with or completely encircle a tree trunk.

(k) Auger tunneling, not trenching, shall be used where possible for utility placement within the dripline of a tree.

(I) If roots are cut between March and August, trees may need supplemental deep root watering once per week for at least 2 months after the roots are cut. When rootsare cut between September 1 and October 15, trees may need supplemental watering once per week until at least October 31

(m) Tree roots shall not be fertilized for a period of 1 year following the cessation of construction activities. Thereafter, for the next 2 years, a light annual fertilization using a slow release nitrogen source is acceptable. (4) Tree Fencing

(a) Fencing material shall encircle any tree whose outer dripline edge is within 20 feet of any construction activities.

(b) Fencing material shall be a bright, contrasting color, durable, and at least 4 feet high. Fence posts shall be comparable to metal T-posts or heavier posts and placed at least 2 feet below ground.

(c) Fencing material shall be placed at the dripline or at least 15 feet from any tree trunk, whichever distance is greater, and maintained in an upright position throughout the duration of construction activities.

(d) The applicant for construction approval shall indicate fencing locations on the landscaping tree protection plan.

(e) Heavy objects, such as wood pallets or metal railings, shall not lean against or come into contact with any tree trunk.

(5) Grade Changes: Grade changes, such as removing topsoil or adding fill material, shall not occur within the dripline of any existing tree. If necessary as part of project or site development, retaining walls and tree wells to maintain the existing grade within the dripline of any tree may be acceptable when constructed prior to site grading changes near the tree.

A landscaping plan containing an illustrated design scheme of the tree protection improvement shall be approved by the City prior to initiating any grade changes near existing trees.


(6) Transplanting: Any proposed or required transplanting shall conform with the requirements in Section 3.04(D), "Tree Relocation (Transplanting)." (7) Chemical/Foreign Material Disposal


(a) Disposing of chemicals or foreign material anywhere on site or in the public

right-of-way is prohibited. This shall include, but is not limited to: paint, stain, solvents, concrete or any construction material onsite, and rinse water from any cans or tools containing chemicals.

(b) Soil samples may be taken to determine the presence of chemicals or foreign

materials for any planter containing proposed or existing plant material. (8) Pruning: Pruning shall not occur during construction activities or the public improvement warranty period, except to remove dead or damaged branches or to prevent branch damage that could occur during construction, without the prior approval of the City. Pruning of healthy branches shall be delayed for a period of 2 years after construction activities are completed

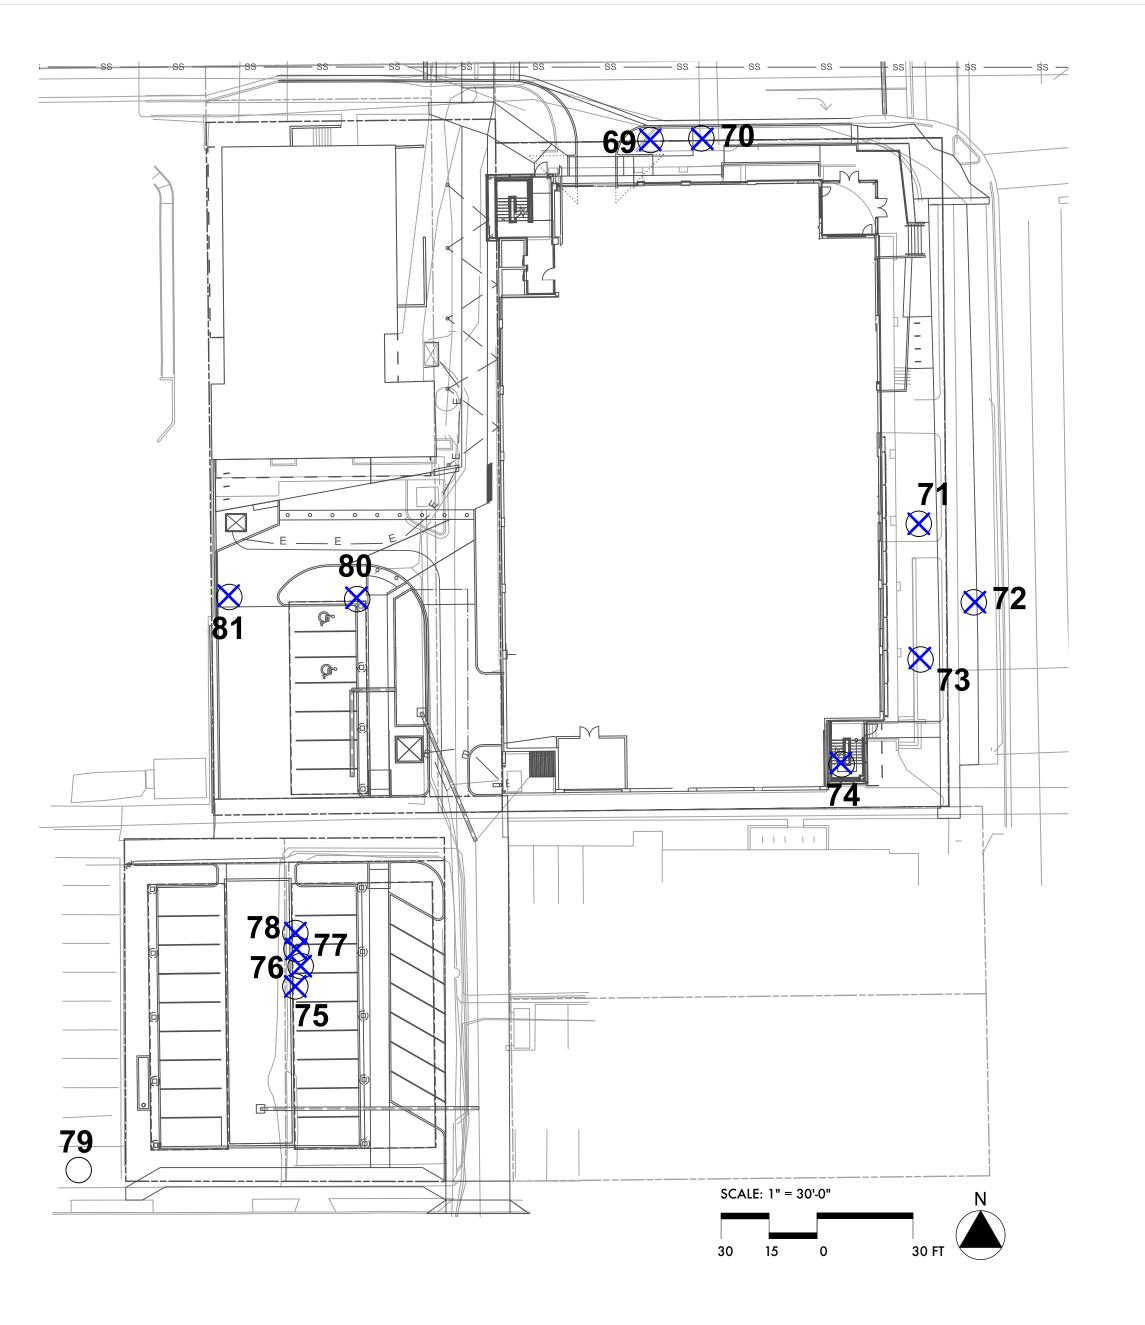

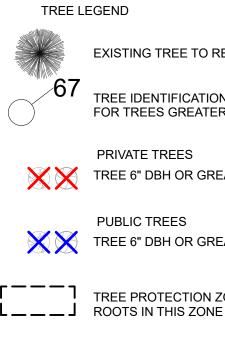

All tree protection standards of Ch. 3 and 10 of the Design and Construction Standards shall be met with particular attention given to grading impacts, limitations of stockpiling, soil compaction prevention and vehicular routes. Tree protection fencing shall be installed prior to any site disturbance and remain in place for the duration of the project. Only hand digging may occur within the dripline of any tree to be preserved. Provide sufficient irrigation throughout construction to maintain the long term health of the tree(s).

ID#	Common Name
35	Austrian pine
36	Austrian pine
37	Crabapple
38	Hawthorn
39	Hawthorn
40	Hawthorn
41	Austrian pine
42	Austrian pine
43	Austrian pine
44	Red oak
45	Hawthorn
46	Hawthorn
47	Hawthorn
<b>48</b>	Hawthorn
<b>49</b>	Red oak
50	Red oak
51	Hawthorn
52	Hawthorn
53	Hawthorn
54	Austrian pine
55	Austrian pine
56	Quaking aspen
69	Norway maple
70	Norway maple
71	Amur maple
72	Norway maple
73	Swamp white oak
74	Tree of heaven
75	Tree of heaven
76	Tree of heaven
77	Tree of heaven
<b>78</b>	Tree of heaven
<b>79</b>	Red oak
80	Honey locust
81	Honey locust
82	Siberian elm
83	Siberian elm
84	Plains cottonwood
85	Plains cottonwood
86	Plains cottonwood
~ -	D1 1 1

**87** Plains cottonwood

**ERC** 


EXISTING TREE TO REMAIN

TREE IDENTIFICATION CIRCLE/NUMBER FOR TREES GREATER THAN 6" DBH

TREE 6" DBH OR GREATER TO BE REMOVED

TREE 6" DBH OR GREATER TO BE REMOVED

TREE PROTECTION ZONE. PROTECT ALL

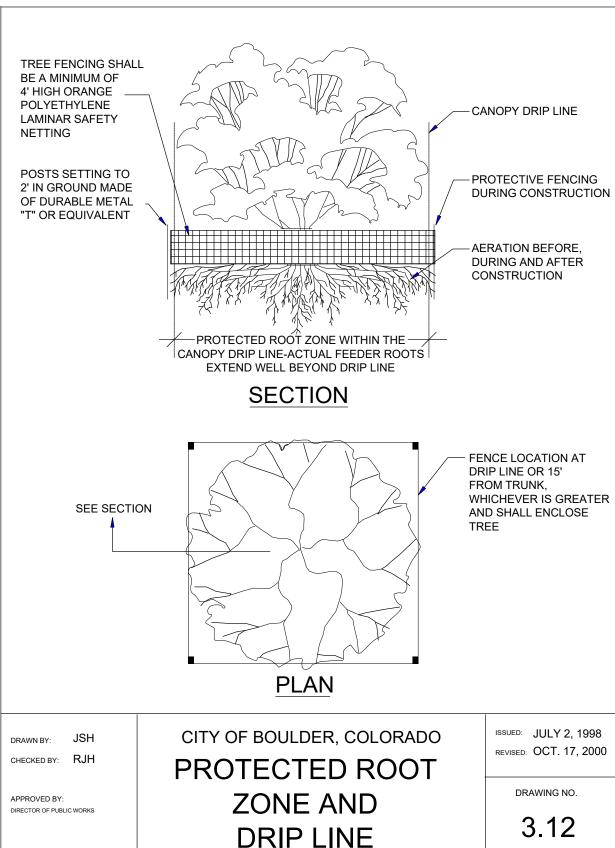

### West City Campus Site Tree Inventory

Scientific Name	DBH	Condition	Comments
	(in)	Rating	
Pinus nigra	13.0	Good	Remove
Pinus nigra	13.5	Good	Remove
Malus sp.	38.0	Good	Remove
Crataegus sp.	6.0	Good	Remove
Crataegus sp.	7.0	Good	Remove
Crataegus sp.	8.0	Good	Remove
Pinus nigra	15.5	Good	Try to keep
Pinus nigra	17.0	Good	Try to keep
Pinus nigra	16.0	Good	Try to keep
Quercus rubra	7.5	Fair	Remove
Crataegus sp.	6.0	Good	Remove
Crataegus sp.	6.0	Good	Remove
Crataegus sp.	6.0	Good	Remove
Crataegus sp.	6.0	Good	Remove
Quercus rubra	8.5	Fair	Remove
Quercus rubra	7.5	Fair	Remove
Crataegus sp.	6.0	Good	Remove
Crataegus sp.	6.0	Good	Remove
Crataegus sp.	6.0	Good	Remove
Pinus nigra	16.0	Good	Remove
Pinus nigra	17.0	Good	Remove
Populus tremuloides	12.0	Very Poor	Remove
Acer platanoides	6.0	Good	Remove
Acer platanoides	9.0	Good	Remove
Acer ginnala	8.0	Good	Remove
Acer platanoides	8.0	Good	Remove
Quercus bicolor	8.5	Good	Remove
Ailanthus altissima	11.0	Good	Remove
Ailanthus altissima	8.0	Poor	Remove
Ailanthus altissima	8.0	Poor	Remove
Ailanthus altissima	9.0	Poor	Remove
Ailanthus altissima	12.0	Poor	Remove
Quercus rubra	6.0	Good	Off property
Gleditsia triacanthos	9.0	Fair	Remove
Gleditsia triacanthos	8.0	Good	Remove
Ulmus pumila	14.5	Good	Remove
Ulmus pumila	19.5	Good	Remove
Populus deltoides ssp. monilifera	24.0	Good	Remove
Populus deltoides ssp. monilifera	15.0	Poor	Remove
Populus deltoides ssp. monilifera	19.0	Fair	Remove
Populus deltoides ssp. monilifera	20.0	Fair	Remove

PRICING NOTE:

CITY FORESTOR WILL ASSESS MITIGATION FEE FOR ALL HEALTHY PUBLIC TREES TO BE REMOVED. NEW TREES PLANTED CAN OFFSET THIS FEE.



758 Club Circle Louisville. Colorado 80027 303.494.9138 www.studioterra.net



### STUDIC Consultant

CIVII THE SANITAS GROUP 901 FRONT STREET, SUITE 350 LOUISVILLE, CO 80027 T 303 481 2710 ENTITLEMENTS

STUDIO ARCHITECTUR 2995 55TH STREET, #17983 BOULDER, CO 80301 T 720 491 1167

LANDSCAPE STUDIO TERRA IN 758 CLUB CIRCLE LOUISVILLE, CO 8002 T 303 494 9138

STRUCTURAL ANTHEM STRUCTURAL ENGINEERS FLATIRON OFFICE PARI 2213 CENTRAL AVENUE BOULDER, CO 8030 T 303 848 8497

MFP **BRANCH PATTER** 3344 WALNUT STREE DENVER, CO 80205 T 303 382 1920

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AV/TECHNOLOGY/SECURITY SALAS O'BRIEN

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TREE REMOVAL PLAN



Current Issue SITE REVIEW

### PLANT SCHEDULE

KEY	SIZE	QUANTITY	BOTANICAL NAME		HEIGHT	SPREAD	WATER USE	EXPOSURE	FLOWER COLOR	SEASON
ЛТС		TBD	ACHILLEA MILLEFOLIUM 'TERRA COTTA'	TERRA COTTA YARROW	18-24"	18-24"	LOW	SUN	PEACH	SUMMER
RU		TBD	AGASTACHE RUPESTRIS	SUNSET HYSSOP	18-24 2-3'	2-3'	LOW	SUN	ORANGE PINK	SUMMER TO FALL
MMG	-	TBD	ALYSSUM MONTANUM 'MOUNTAIN GOLD'	MOUNTAIN BASKET OF GOLD	6-12"	12-18"	LOW	SUN	MUSTARD YELLOW	MID-SPRING
COE	-	TBD	AQUILEGIA COERULEA	ROCKY MOUNTAIN COLUMBINE	18-24"	12-18"	MEDIUM		BLUE WITH WHITE CENTER	LATE SPRING TO EARLY SUMME
XCC	1 GAL	TBD	ARCTOSTAPHYLOS X COLORADOENSIS CHIEFTAN	CHIEFTAN MANZANITA	3-4'	5-6;	LOW	SUN TO FILTERED SHADE	SOFT PINK	LATE WINTER TO EARLY SPRING
PL	1 GAL	TBD	CERATOSTIGMA PLUMBAGINOIDES	PLUMBAGO	8-12"	18-24"	LOW	ADAPTABLE	BLUE	MID TO LATE SUMMER
٧Z	1 GAL	TBD	COREOPSIS VERTICILLATA 'ZAGREB'	ZAGREB COREOPSIS	12-18"	12-18"	LOW	SUN	GOLD	MID-SUMMER TO FALL
FC	1 GAL		EUONUMUS FORTUNEI 'COLORATUS'	PURPLELEAF WINTERCREEPER	12-18"	3-6'	LOW	ADAPTABLE	INSIGNIFICANT	EARLY SUMMER
VI		TBD	GERANIUM VISCOSISSIMUM	STICKY GERANIUM	1-3'	18-24"	LOW	ADAPTABLE	ROSE-PURPLE	LATE SPRING TO SUMMER
1FM		TBD	MONARDA FISTULOSA MENTHIFOLIA	NATIVE LAVENDER BEE-BALM	2-3'	18-24"	LOW	SUN	LAVENDER	MID-SUMMER
MC	1 GAL		PENSTEMON X MEXICALI 'CAROLYN'S HOPE'	CAROLYN'S HOPE PINK PENSTEMON	12-15"	8-12"	LOW	SUN	PINK	SPRING TO SUMMER
ATR		TBD	PEROVSKIA ATRIPLICIFOLIA	RUSSIAN SAGE	3-4' 6-8"	3-4'	VERY LOW	SUN	BLUE	MID TO LATE SUMMER
GG	1 GAL	IBD	ZINNIA GRANDLIFLORA 'GOLD ON BLUE'	GOLD ON BLUE ROCKY MOUNTAIN ZINNIA	0-8	8-12"	VERY LOW	SUN	GOLDEN YELLOW	MID TO LATE SUMMER
RNAM	ENTAL GR	RASSES								
Y	SIZE	QUANTITY	BOTANICAL NAME	COMMON NAME		SPREAD	WATER USE	EXPOSURE	FLOWER COLOR	SEASON
2		TBD	ACHNATHERUM CALAMAGROSTIS	UNDAUNTED APLINE PLUME GRASS	2-3'	2-3'	LOW	SUN	TAN	
GW		TBD	ANDROPOGON GERARDII WINDWALKER	WINDWALKER BIG BLUESTEM GRASS	4-6'	2-3'	LOW	SUN	PURPLE	
5	1 GAL			KOREAN FEATHER REED GRASS	3-4' 15 20"	2-3' 19 24"	LOW	SUN TO FILTERED SHADE	PINKISH-TAN	LATE SUMMER
R		TBD TBD	MUHLENBERGIA REVERCHONII UNDAUNTED SCHIZACHYRIUM SCOPARIUM 'STANDING OVATIOI	UNDAUNTED RUBY MUHLY GRASS	15-30" \\$ 3-4'	18-24" 12-18"	LOW LOW	SUN SUN	RUBY-PINK SILVER	FALL LATE SUMMER
SS NT	1 GAL 1 GAL		SORGHASTRUM NUTANS 'THIN MAN'	THIN MAN INDIAN GRASS	45 3-4 5-7'	12-18 2-3'	LOW	SUN	YELLOW	SUMMER
•	TOAL				57	2 3				JUIMALEIN
	OUS SHRI	-							1	
1	<b>SIZE</b> 5 GAL		BOTANICAL NAME AMORPHA NANA	COMMON NAME       DWARF FALSE INDIGO	HEIGHT 1-2'	SPREAD 1-2'	VERY LOW	SUN	PURPLE	SEASON SUMMER
l 1L		TBD	ARONIA MELANOCARPA LOW SCAPE MOUND	LOW SCAPE MOUND BLACK CHOKEBERRY	1-2 1-2'	1-2 18-24"	LOW	ADAPTABLE	WHITE	LATE SPRING
BC		TBD	BUDDLEJA 'BLUE CHIP'	DWARF PURPLE-BLUE BUTTERFLY BUSH	1-2 24-30"	10-24 2-4'	MEDIUM	SUN	PURPLE-BLUE	SUMMER TO FALL
HM		TBD	CHAMAEBATIARIA MILLEFOLIUM	FERNBUSH	24 50 3-5'	3-6'	VERY LOW	SUN	WHITE	MID TO LATE SPRING
BC	5 GAL		DAPHNE X BURKWOODII 'CAROL MACKIE'	CAROL MACKIE DAPHNE	3-5'	3-5'	MEDIUM	FILTERED SHADE TO SHADE		SPRING
ΞE		TBD	EUONYMUS FORTUNEI 'EMERALD GAIETY'	EMERALD GAIETY EUONYMUS	18-24"	3-4'	MEDIUM	FILTERED SHADE TO SHADE	N/A	EARLY SUMMER
D	5 GAL	TBD	FALLUGIA PARADOXA	APACHE PLUME	3-6'	3-6'	VERY LOW	SUN	WHITE	SUMMER
Þ	5 GAL		HESPERALOE PARVIFLORA	RED FALSE YUCCA	3-4'	3-4'	VERY LOW	SUN	RED TO ORANGE-RED	SUMMER
PΥ	5 GAL	TBD	HESPERALOE PARVIFLORA 'YELLOW'	YELLOW FALSE YUCCA	3-4'	3-4'	VERY LOW	SUN	YELLOW	SUMMER
/L	5 GAL	TBD	LIGUSTRUM VULGARE 'LODENSE'	LODENSE PRIVET	2-3'	3-4'	LOW	SUN TO FILTERED SHADE	WHITE	EARLY SUMMER
5	5 GAL		PHILADELPHUS X 'SNOWBELLE'	SNOWBELLE MOCKORANGE	3-4'	3-4'	LOW	SUN	WHITE	LATE SPRING TO EARLY SUMME
NC		TBD	PHYSOCARPUS OPULIFOLIUS 'NANUS'	DWARF NINEBARK	4-5'	4-5'	LOW	SUN TO FILTERED SHADE	WHITE	LATE SPRING
BPB	5 GAL		PRUNUS BESSEYI PAWNEE BUTTES	CREEPING WESTER SAND CHEERY	15-30"	4-6'	LOW	SUN	WHITE	SPRING
AG	5 GAL		RHUS AROMATICA 'GRO-LOW'	DWARF FRAGRANT SUMAC	2-3'	6-8'	LOW	SUN	YELLOW	EARLY SPRING
۹ • (		TBD			3-6'	3-6'	LOW	SUN TO FILTERED SHADE	YELLOWISH-GREEN	
N	5 GAL	IRD	ROSA WOODSII	WOODS' ROSE	3-6'	3-6'	LOW	SUN	PINK	EARLY SUMMER
	EEN SHRU	1								
Y		-				SPREAD	WATER USE	EXPOSURE		SEASON
G		TBD	JUNIPERUS COMMUNIS 'GREEN CARPET'	GREEN CARPET JUNIPER	8-10"	2-3'	LOW	SUN	N/A	N/A
		TBD	JUNIPERUS HORIZONTALIS ICEE BLUE		2-4"	6-8'	LOW		N/A	N/A
	5 GAL		JUNIPERUS SABINA CALGARY CARPET	CALGARY CARPET JUNIPER	12-18" 2 2'	6-8' 2 2'	LOW	SUN TO FILTERED SHADE	N/A	
AC	5 GAL 5 GAL	TBD TBD	MAHONIA AQUIFOLIUM 'COMPACTA' PINUS MUGO 'WHITE BUD'	COMPACT OREGON GRAPE HOLLY WHITE BUD MUGO PINE	2-3' 2-3'	2-3' 3-4'	LOW LOW	SHADE SUN TO FILTERED SHADE	YELLOW N/A	MID-SPRING N/A
VIW		TBD	PINUS MUGO WHITE BOD PINUS SYLVESTRIS 'ALBYN PROSTRATA'	SPREADING SCOTS PINE	2-3 2'	5 <del>-</del> 8'	LOW	SUN TO FILTERED SHADE	N/A N/A	N/A
	D GAI				_	-			···	
	J GAL									
A RNAM	ENTAL TR	-			HEIGHT			EXDOCUDE		SEACON
A RNAM	ENTAL TR	QUANTITY	BOTANICAL NAME GLEDITSIA TRIACANTHOS STREET KEEPER	COMMON NAME STREET KEEPER HONEYLOCUST		<b>SPREAD</b> 15-20'	WATER USE	EXPOSURE SUN	COLOR N/A	SEASON N/A
SA RNAM EY TS	ENTAL TR	QUANTITY 4	BOTANICAL NAME GLEDITSIA TRIACANTHOS STREET KEEPER PRUNUS PADUS 'MERLOT'	COMMON NAME STREET KEEPER HONEYLOCUST PURPLE LEAF MAYDAY TREE	HEIGHT 30-45' 15-20'	<b>SPREAD</b> 15-20' 15-20'	WATER USE LOW MEDIUM	EXPOSURE SUN ADAPTABLE	COLOR N/A WHITE	SEASON N/A SPRING
SA RNAM EY TS PM	ENTAL TR SIZE 2.0" CAI	QUANTITY 4	GLEDITSIA TRIACANTHOS STREET KEEPER	STREET KEEPER HONEYLOCUST	30-45'	15-20'	LOW	SUN	N/A	N/A
SA RNAM SY TS PM CR	ENTAL TR SIZE 2.0" CAI 2.0" CAI	QUANTITY 4 3 1	GLEDITSIA TRIACANTHOS STREET KEEPER PRUNUS PADUS 'MERLOT'	STREET KEEPER HONEYLOCUST PURPLE LEAF MAYDAY TREE	30-45' 15-20'	15-20' 15-20'	LOW MEDIUM	SUN ADAPTABLE	N/A WHITE	N/A SPRING
SA RNAM SY TS PM CR S	ENTAL TR SIZE 2.0" CAI 2.0" CAI 2.0" CAI 2.0" CAI	QUANTITY 4 3 1	GLEDITSIA TRIACANTHOS STREET KEEPER PRUNUS PADUS 'MERLOT' PYRUS CALLERYANA 'REDSPIRE'	STREET KEEPER HONEYLOCUST PURPLE LEAF MAYDAY TREE REDSPIRE PEAR	30-45' 15-20' 30-35'	15-20' 15-20' 20-25'	LOW MEDIUM MEDIUM	SUN ADAPTABLE SUN	N/A WHITE WHITE	N/A SPRING SPRING
SA RNAM SY TS PM CR S HADE 1	ENTAL TR SIZE 2.0" CAI 2.0" CAI 2.0" CAI 2.0" CAI 2.0" CAI	QUANTITY 4 3 1 1 9	GLEDITSIA TRIACANTHOS STREET KEEPER PRUNUS PADUS 'MERLOT' PYRUS CALLERYANA 'REDSPIRE' XANTHOCERAS SORBIFOLIA	STREET KEEPER HONEYLOCUST PURPLE LEAF MAYDAY TREE REDSPIRE PEAR YELLOWHORN	30-45' 15-20' 30-35' 8-25'	15-20' 15-20' 20-25' 10-25'	LOW MEDIUM MEDIUM MEDIUM	SUN ADAPTABLE SUN SUN	N/A WHITE WHITE WHITE W/ RED OR YELLOW	N/A SPRING SPRING SPRING
RNAM EY TS PM CR FADE 1	ENTAL TR SIZE 2.0" CAI 2.0" CAI 2.0" CAI 2.0" CAI 2.0" CAI SIZE	QUANTITY 4 3 1 1 9 <b>QUANTITY</b>	GLEDITSIA TRIACANTHOS STREET KEEPER PRUNUS PADUS 'MERLOT' PYRUS CALLERYANA 'REDSPIRE' XANTHOCERAS SORBIFOLIA BOTANICAL NAME	STREET KEEPER HONEYLOCUST PURPLE LEAF MAYDAY TREE REDSPIRE PEAR	30-45' 15-20' 30-35' 8-25' HEIGHT	15-20' 15-20' 20-25' 10-25' SPREAD	LOW MEDIUM MEDIUM MEDIUM	SUN ADAPTABLE SUN SUN	N/A WHITE WHITE WHITE W/ RED OR YELLOW	N/A SPRING SPRING SPRING SEASON
SA RNAM EY TS PM CR S HADE 1 EY C	ENTAL TR SIZE 2.0" CAI 2.0" CAI 2.0" CAI 2.0" CAI 2.0" CAI	QUANTITY 4 3 1 1 9 <b>QUANTITY</b> 6	GLEDITSIA TRIACANTHOS STREET KEEPER PRUNUS PADUS 'MERLOT' PYRUS CALLERYANA 'REDSPIRE' XANTHOCERAS SORBIFOLIA	STREET KEEPER HONEYLOCUST PURPLE LEAF MAYDAY TREE REDSPIRE PEAR YELLOWHORN	30-45' 15-20' 30-35' 8-25'	15-20' 15-20' 20-25' 10-25'	LOW MEDIUM MEDIUM MEDIUM	SUN ADAPTABLE SUN SUN	N/A WHITE WHITE WHITE W/ RED OR YELLOW	N/A SPRING SPRING SPRING
SA RNAM EY TS PM CR CR CR EY C DE	ENTAL TR SIZE 2.0" CAI 2.0" CAI 2.0" CAI 2.0" CAI 2.0" CAI SIZE 2.5" CAI	QUANTITY 4 3 1 1 9 <b>QUANTITY</b> 6	GLEDITSIA TRIACANTHOS STREET KEEPER PRUNUS PADUS 'MERLOT' PYRUS CALLERYANA 'REDSPIRE' XANTHOCERAS SORBIFOLIA BOTANICAL NAME CORYLUS COLURNA	STREET KEEPER HONEYLOCUST PURPLE LEAF MAYDAY TREE REDSPIRE PEAR YELLOWHORN COMMON NAME TURKISH FILBERT	30-45' 15-20' 30-35' 8-25' <b>HEIGHT</b> 30-45'	15-20' 15-20' 20-25' 10-25' <b>SPREAD</b> 25-30'	LOW MEDIUM MEDIUM MEDIUM WATER USE LOW	SUN ADAPTABLE SUN SUN EXPOSURE SUN	N/A WHITE WHITE WHITE W/ RED OR YELLOW COLOR N/A	N/A SPRING SPRING SPRING SEASON N/A
SA RNAM EY TS PM CR CR S HADE 1 EY C DE B	ENTAL TR SIZE 2.0" CAI 2.0" CAI 2.0" CAI 2.0" CAI 2.0" CAI 5.12 2.5" CAI 2.5" CAI 2.5" CAI	QUANTITY 4 3 1 1 9 <b>QUANTITY</b> 6 1 2	GLEDITSIA TRIACANTHOS STREET KEEPER PRUNUS PADUS 'MERLOT' PYRUS CALLERYANA 'REDSPIRE' XANTHOCERAS SORBIFOLIA BOTANICAL NAME CORYLUS COLURNA GYMNOCLADUS DIOICUS 'ESPRESSO'	STREET KEEPER HONEYLOCUST PURPLE LEAF MAYDAY TREE REDSPIRE PEAR YELLOWHORN COMMON NAME TURKISH FILBERT SEEDLESS KENTUCKY COFFEETREE	30-45' 15-20' 30-35' 8-25' <b>HEIGHT</b> 30-45' 50-60'	15-20' 15-20' 20-25' 10-25' <b>SPREAD</b> 25-30' 40-50'	LOW MEDIUM MEDIUM MEDIUM WATER USE LOW LOW	SUN ADAPTABLE SUN SUN EXPOSURE SUN SUN	N/A WHITE WHITE WHITE W/ RED OR YELLOW <b>COLOR</b> N/A YELLOW-GREEN	N/A SPRING SPRING SPRING SEASON N/A SPRING
A RNAM Y TS PM CR CR CR CR CR CR CR CR CR CR	ENTAL TR SIZE 2.0" CAI 2.0" CAI 2.0" CAI 2.0" CAI 2.0" CAI 2.5" CAI 2.5" CAI 2.5" CAI 2.5" CAI	QUANTITY 4 3 1 1 9 <b>QUANTITY</b> 6 1 2 2 2	GLEDITSIA TRIACANTHOS STREET KEEPER PRUNUS PADUS 'MERLOT' PYRUS CALLERYANA 'REDSPIRE' XANTHOCERAS SORBIFOLIA BOTANICAL NAME CORYLUS COLURNA GYMNOCLADUS DIOICUS 'ESPRESSO' QUERCUS BICOLOR	STREET KEEPER HONEYLOCUST PURPLE LEAF MAYDAY TREE REDSPIRE PEAR YELLOWHORN COMMON NAME TURKISH FILBERT SEEDLESS KENTUCKY COFFEETREE SWAMP WHITE OAK	30-45' 15-20' 30-35' 8-25' <b>HEIGHT</b> 30-45' 50-60' 40-60'	15-20' 15-20' 20-25' 10-25' <b>SPREAD</b> 25-30' 40-50' 40-60'	LOW MEDIUM MEDIUM MEDIUM <b>WATER USE</b> LOW LOW LOW	SUN ADAPTABLE SUN SUN <b>EXPOSURE</b> SUN SUN SUN TO FILTERED SHADE	N/A WHITE WHITE WHITE W/ RED OR YELLOW <b>COLOR</b> N/A YELLOW-GREEN N/A	N/A SPRING SPRING SPRING <b>SEASON</b> N/A SPRING N/A
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A RNAM Y S M R IADE 1 Y DE S M MU (T	ENTAL TR SIZE 2.0" CAI 2.0" CAI 2.0" CAI 2.0" CAI 2.0" CAI 2.5" CAI 2.5" CAI 2.5" CAI 2.5" CAI 2.5" CAI 2.5" CAI	QUANTITY 4 4 3 1 9 0 0 0 0 0 0 0 0 0 0 0 0 0 0 0 0 0 0	GLEDITSIA TRIACANTHOS STREET KEEPER PRUNUS PADUS 'MERLOT' PYRUS CALLERYANA 'REDSPIRE' XANTHOCERAS SORBIFOLIA BOTANICAL NAME CORYLUS COLURNA GYMNOCLADUS DIOICUS 'ESPRESSO' QUERCUS BICOLOR QUERCUS MACROCARPA QUERCUS MUEHLENBERGII ULMUS X TRIUMPH ZELKOVA SERRATA 'GREEN VASE'	STREET KEEPER HONEYLOCUST PURPLE LEAF MAYDAY TREE REDSPIRE PEAR YELLOWHORN COMMON NAME TURKISH FILBERT SEEDLESS KENTUCKY COFFEETREE SWAMP WHITE OAK BUR OAK CHINKAPIN OAK	30-45' 15-20' 30-35' 8-25' <b>HEIGHT</b> 30-45' 50-60' 40-60' 50-80' 35-50'	15-20' 15-20' 20-25' 10-25' <b>SPREAD</b> 25-30' 40-50' 40-60' 50-80' 35-50'	LOW MEDIUM MEDIUM MEDIUM MEDIUM LOW LOW LOW LOW LOW	SUN ADAPTABLE SUN SUN SUN SUN SUN SUN TO FILTERED SHADE SUN SUN	N/A WHITE WHITE WHITE W/ RED OR YELLOW <b>COLOR</b> N/A YELLOW-GREEN N/A N/A N/A	N/A SPRING SPRING SPRING N/A SPRING N/A N/A N/A
A RNAM TS TS TM CR TADE 1 TOE S VI VIU CT	ENTAL TR SIZE 2.0" CAI 2.0" CAI 2.0" CAI 2.0" CAI 2.0" CAI 2.5" CAI 2.5" CAI 2.5" CAI 2.5" CAI 2.5" CAI 2.5" CAI 2.5" CAI 2.5" CAI 2.5" CAI	QUANTITY 4 3 1 1 2 1 9 <b>QUANTITY</b> 2 4 2 4 2 4 3 1 1 3 3 18	GLEDITSIA TRIACANTHOS STREET KEEPER PRUNUS PADUS 'MERLOT' PYRUS CALLERYANA 'REDSPIRE' XANTHOCERAS SORBIFOLIA BOTANICAL NAME CORYLUS COLURNA GYMNOCLADUS DIOICUS 'ESPRESSO' QUERCUS BICOLOR QUERCUS MACROCARPA QUERCUS MUEHLENBERGII ULMUS X TRIUMPH ZELKOVA SERRATA 'GREEN VASE'	STREET KEEPER HONEYLOCUST PURPLE LEAF MAYDAY TREE REDSPIRE PEAR YELLOWHORN COMMON NAME TURKISH FILBERT SEEDLESS KENTUCKY COFFEETREE SWAMP WHITE OAK BUR OAK CHINKAPIN OAK TRIUMPH ELM	30-45' 15-20' 30-35' 8-25' <b>HEIGHT</b> 30-45' 50-60' 40-60' 50-80' 35-50' 50-60'	15-20' 15-20' 20-25' 10-25' <b>SPREAD</b> 25-30' 40-50' 40-60' 50-80' 35-50' 40-50'	LOW MEDIUM MEDIUM MEDIUM MEDIUM LOW LOW LOW LOW LOW LOW	SUN ADAPTABLE SUN SUN SUN SUN SUN SUN TO FILTERED SHADE SUN SUN SUN	N/A WHITE WHITE WHITE W/ RED OR YELLOW <b>COLOR</b> N/A YELLOW-GREEN N/A N/A N/A N/A	N/A SPRING SPRING SPRING N/A SPRING N/A N/A N/A N/A
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EY TS PM CR S HADE 1 EY C DE B M M MU XT S	ENTAL TR SIZE 2.0" CAI 2.0" CAI 2.0" CAI 2.0" CAI 2.0" CAI 2.0" CAI 2.5" CAI	QUANTITY 4 3 1 1 9 <b>QUANTITY</b> 6 1 1 2 2 1 2 1 3 1 1 3 3 1 8 5 <b>QUANTITY</b>	GLEDITSIA TRIACANTHOS STREET KEEPER PRUNUS PADUS 'MERLOT' PYRUS CALLERYANA 'REDSPIRE' XANTHOCERAS SORBIFOLIA BOTANICAL NAME CORYLUS COLURNA GYMNOCLADUS DIOICUS 'ESPRESSO' QUERCUS BICOLOR QUERCUS MACROCARPA QUERCUS MUEHLENBERGII ULMUS X TRIUMPH ZELKOVA SERRATA 'GREEN VASE'	STREET KEEPER HONEYLOCUST PURPLE LEAF MAYDAY TREE REDSPIRE PEAR YELLOWHORN COMMON NAME TURKISH FILBERT SEEDLESS KENTUCKY COFFEETREE SWAMP WHITE OAK BUR OAK CHINKAPIN OAK TRIUMPH ELM GREEN VASE ZELKOVA	30-45' 15-20' 30-35' 8-25' <b>HEIGHT</b> 30-45' 50-60' 40-60' 50-80' 35-50' 50-60' 40-60'	15-20' 15-20' 20-25' 10-25' <b>SPREAD</b> 25-30' 40-50' 40-60' 50-80' 35-50' 40-50'	LOW MEDIUM MEDIUM MEDIUM MEDIUM LOW LOW LOW LOW LOW MEDIUM MEDIUM	SUN ADAPTABLE SUN SUN SUN SUN SUN SUN TO FILTERED SHADE SUN SUN SUN SUN	N/A WHITE WHITE WHITE W/ RED OR YELLOW <b>COLOR</b> N/A YELLOW-GREEN N/A N/A N/A N/A	N/A SPRING SPRING SPRING N/A SPRING N/A N/A N/A N/A N/A N/A

4.

EXPOSED MULCH.

# **OTHER LANDSCAPE NOTES:**

ROOT BALL OF THE PLANT PRIOR TO PLANTING. WITHIN PUBLIC AREAS. REQUIREMENTS.

### CITY OF BOULDER LANDSCAPE NOTES:

LANDSCAPING SCHEDULE: (A) NOTHING SHALL BE PLANTED BETWEEN OCTOBER 15 AND MARCH 1 WITHOUT PRIOR WRITTEN APPROVAL OF THE CITY. STOCK, OTHER THAN CONTAINER-GROWN STOCK, SHALL NOT BE PLANTED BETWEEN JUNE 1 AND SEPTEMBER 1 WITHOUT PRIOR WRITTEN APPROVAL OF THE CITY. BARE ROOT STOCK SHALL NOT BE PLANTED AFTER APRIL 30 OR IF PLANTS HAVE BEGUN TO LEAF OUT. (B) NOTHING SHALL BE PLANTED DURING FREEZING OR EXCESSIVELY WINDY, HOT, OR WET WEATHER OR WHEN THE GROUND

CONDITIONS CANNOT BE PROPERLY WORKED FOR DIGGING, MIXING, RAKING, OR GRADING. (C) NOTHING SHALL BE PLANTED UNTIL THE ADJACENT SITE IMPROVEMENTS, PAVEMENTS, IRRIGATION INSTALLATION AND FINISH GRADING IS COMPLETED. THE CONTRACTOR SHALL TEST THE IRRIGATION SYSTEM IN THE PRESENCE OF THE DIRECTOR. THE IRRIGATION SYSTEM SHALL BE IN APPROVED, OPERATING CONDITION PRIOR TO ANY PLANTING. 2. SITE PREPARATION AND ALL PLANTING SHALL BE COMPLETED, AT A MINIMUM, IN ACCORDANCE WITH THE CITY OF BOULDER DESIGN AND CONSTRUCTION STANDARDS. SITE PREPARATION SHALL INCLUDE TILLING THE SOIL TO A MINIMUM DEPTH OF SIX INCHES BELOW THE FINISHED GRADE, TOGETHER WITH SOIL AMENDMENTS THAT ARE APPROPRIATE TO ENSURE THE HEALTH AND SUSTAINABILITY OF THE LANDSCAPING TO BE PLANTED. 3. TURF GRASS SHALL BE LIMITED TO A MAXIMUM OF 25 PERCENT OF ALL LANDSCAPE AREAS ON THE SITE. ALL PLANTING BEDS AND A 3-FOOT DIAMETER RING AT THE BASE OF EACH TREE WITHIN SOD OR SEEDED AREAS SHALL BE MULCHED WITH ORGANIC MULCH AT LEAST 4" DEEP.

5. GRAVEL, ROCK MULCH, OR CRUSHER FINES SHALL NOT BE USED UNDER TREES OR ANY PLANTING AREAS. ROCK OR GRAVEL MAY ONLY BE USED AS A SPECIFIC ORNAMENTAL FEATURE IN LIMITED AREAS (SUCH AS AT THE BOTTOM OF A DRAINAGE SWALE OR DRY RIVER BED) OR AS A PEDESTRIAN PATH OR PATIO.

6. WEED BARRIER FABRIC SHALL NOT TO BE USED IN ANY PLANTING AREAS.

ALL PLANTS SHALL BE GROUPED BY WATER NEEDS. A MINIMUM OF 75 PERCENT OF ALL LANDSCAPED AREAS (INCLUDING ANY TURF GRASS) MUST USE LOW TO MODERATE WATER DEMAND PLANTS. THE LANDSCAPE SHALL BE DESIGNED SO THAT, AT MATURITY, NOT MORE THAN 10 PERCENT OF THE LANDSCAPED AREA IS

8. ALL LANDSCAPE AREAS SHALL BE WATERED BY AN AUTOMATIC IRRIGATION SYSTEM. THE IRRIGATION SYSTEM MUST BE ZONED TO DELIVER DIFFERENT APPROPRIATE AMOUNTS OF WATER TO DIFFERENT PLANT ZONES. THE SITE SHOULD BE IRRIGATED WITH DRIP IRRIGATION, BUBBLER, OR MICRO-SPRAY SYSTEMS. ALL TREES WILL BE ZONED SEPARATELY FROM TURF GRASS. ALL IRRIGATION ZONES SHALL USE A SMART SYSTEM THAT ADJUSTS FOR RAINFALL, SOIL MOISTURE, AND OTHER WEATHER FACTORS.

9. PROTECTIVE MAINTENANCE: AN APPLICANT FOR CONSTRUCTION APPROVAL SHALL PROVIDE MAINTENANCE AND CARE FOR ALL EXISTING TREES REQUIRED TO BE PROTECTED IN THE PUBLIC RIGHT-OF-WAY ADJACENT TO ANY PROJECT OR CONSTRUCTION SITE DURING CONSTRUCTION ACTIVITIES AND THE PUBLIC IMPROVEMENT WARRANTY PERIOD TO ENSURE THAT EXISTING TREES SURVIVE AND ARE NOT DAMAGED. REFER TO CHAPTER 3 OF THE DESIGN AND CONSTRUCTION STANDARDS FOR ALL TREE PROTECTION REQUIREMENTS. (ONLY APPLICABLE TO EXISTING PUBLIC STREET TREES OR EXISTING PRIVATE TREES THAT WILL MEET THE STREET TREE REQUIREMENTS OF SECTION 9-9-13 BRC 1981)

10. ALL NEW TREES SHALL BE LOCATED A MINIMUM OF 10' FROM ANY EXISTING WATER OR SEWER UTILITY LINES OR FROM LIGHT POLES OR OVERHEAD UTILITY POLES. ALL NEW UTILITY LINES SHALL BE LOCATED A MINIMUM OF 10' FROM ANY EXISTING PUBLIC STREET TREE.

1. ALL PLANT MATERIAL SHALL MEET SPECIFICATIONS OF THE AMERICAN ASSOCIATION OF NURSERYMEN (AAN) FOR NUMBER ONE GRADE. ALL TREES SHALL BE BALLED AND BURLAPPED OR EQUIVALENT. ALL PLANT MATERIALS SHALL HAVE ALL WIRE, TWINE OR OTHER CONTAINMENT MATERIALS, EXCEPT FOR BURLAP, REMOVED FROM TRUNK AND

2. GRADES SHALL BE SET TO ALLOW FOR PROPER DRAINAGE AWAY FROM STRUCTURES. GRADES SHALL MAINTAIN SMOOTH PROFILES AND BE FREE OF SURFACE DEBRIS, BUMPS, AND DEPRESSIONS.

3. OWNERS SHALL ENSURE THAT THE LANDSCAPE PLAN IS COORDINATED WITH THE PLANS DONE BY OTHER CONSULTANTS SO THAT THE PROPOSED GRADING, STORM DRAINAGE, OR OTHER CONSTRUCTIONS DOES NOT CONFLICT NOR PRECLUDE INSTALLATION AND MAINTENANCE OF LANDSCAPE ELEMENTS ON THIS PLAN.

4. ALL SHRUB BEDS ADJACENT TO TURF AREAS SHALL BE EDGED WITH ROLLED TOP STEEL EDGER. 5. ALL SHRUB BED AREAS, PERENNIALS AND GROUNDCOVER SHALL BE MULCHED WITH A 4" LAYER OF GORILLA HAIR MULCH. DO NOT USE WEED BARRIER FABRIC IN ANY OF THE LANDSCAPE BEDS.

6. PRIOR TO INSTALLATION OF PLANT MATERIALS, AREAS THAT HAVE BEEN COMPACTED OR DISTURBED BY CONSTRUCTION ACTIVITY SHALL BE THOROUGHLY LOOSENED; ORGANIC SOIL AMENDMENTS SHALL BE INCORPORATED AT THE RATE OF AT LEAST FOUR (4) CUBIC YARDS PER 1000 SQUARE FEET OF LANDSCAPE AREA. 7. PROVIDE 12" OF TOPSOIL IN ALL PLANTING AREAS THAT WERE PREVIOUSLY HARDSCAPE.

8. PLANTS ARE GROUPED BY WATER USE ZONE TO CONSERVE WATER. 9. CONTRACTOR SHALL VERIFY ALL MATERIAL QUANTITIES PRIOR TO INSTALLATION. ACTUAL NUMBER OF PLANT

SYMBOLS SHALL HAVE PRIORITY OVER THE QUANTITY DESIGNATED. 10. REFER TO THE CITY OF BOULDER DESIGN AND CONSTRUCTION STREETSCAPING STANDARDS FOR ALL WORK

11. REFER TO THE CIVIL ENGINEER DRAWINGS FOR GRADING AND UTILITY INFORMATION. 12. REFER TO THE CITY OF BOULDER DESIGN AND CONSTRUCTION STANDARDS FOR TREE PROTECTION



758 Club Circle Louisville, Colorado 80027 303.494.9138 www.studioterra.net

CHITECT , Suite 300A 4 >00 DIO Du ST 357 Den theS

STUDIO Consultant

CIVII THE SANITAS GROUP 901 FRONT STREET, SUITE 350 LOUISVILLE, CO 80027 T 303 481 2710 ENTITLEMENTS

STUDIO ARCHITECTURE 2995 55TH STREET, #17983 BOULDER, CO 80301 T 720 491 1167

LANDSCAPE STUDIO TERRA INC 758 CLUB CIRCLE LOUISVILLE, CO 80027 T 303 494 9138

STRUCTURAL ANTHEM STRUCTURAL ENGINEERS FLATIRON OFFICE PARI 2213 CENTRAL AVENUE BOULDER, CO 80301 T 303 848 8497

MFP **BRANCH PATTERN** 3344 WALNUT STREET DENVER, CO 80205 T 303 382 1920

LIGHTING AE DESIGN 1900 WAZEE STREET, #205 DENVER, CO 80202 T 303 296 3034

AV/TECHNOLOGY/SECURITY SALAS O'BRIEN

4900 NAUTILUS CT. N. SUITE 200 BOULDER, CO 80301 T 303 865 5500

Full Design Team Roster on Sheet 1-G0.01 Client and Project Information



Boulder Western City Campus - Volume 2 Garage & Brenton 2655 BROADWAY Boulder, CO 80302

Original Issue

Key Plan and Orientation

Sheet Status NOT FOR CONSTRUCTION


Sheet Title

PLANT SCHEDULE



Current Issue SITE REVIEW



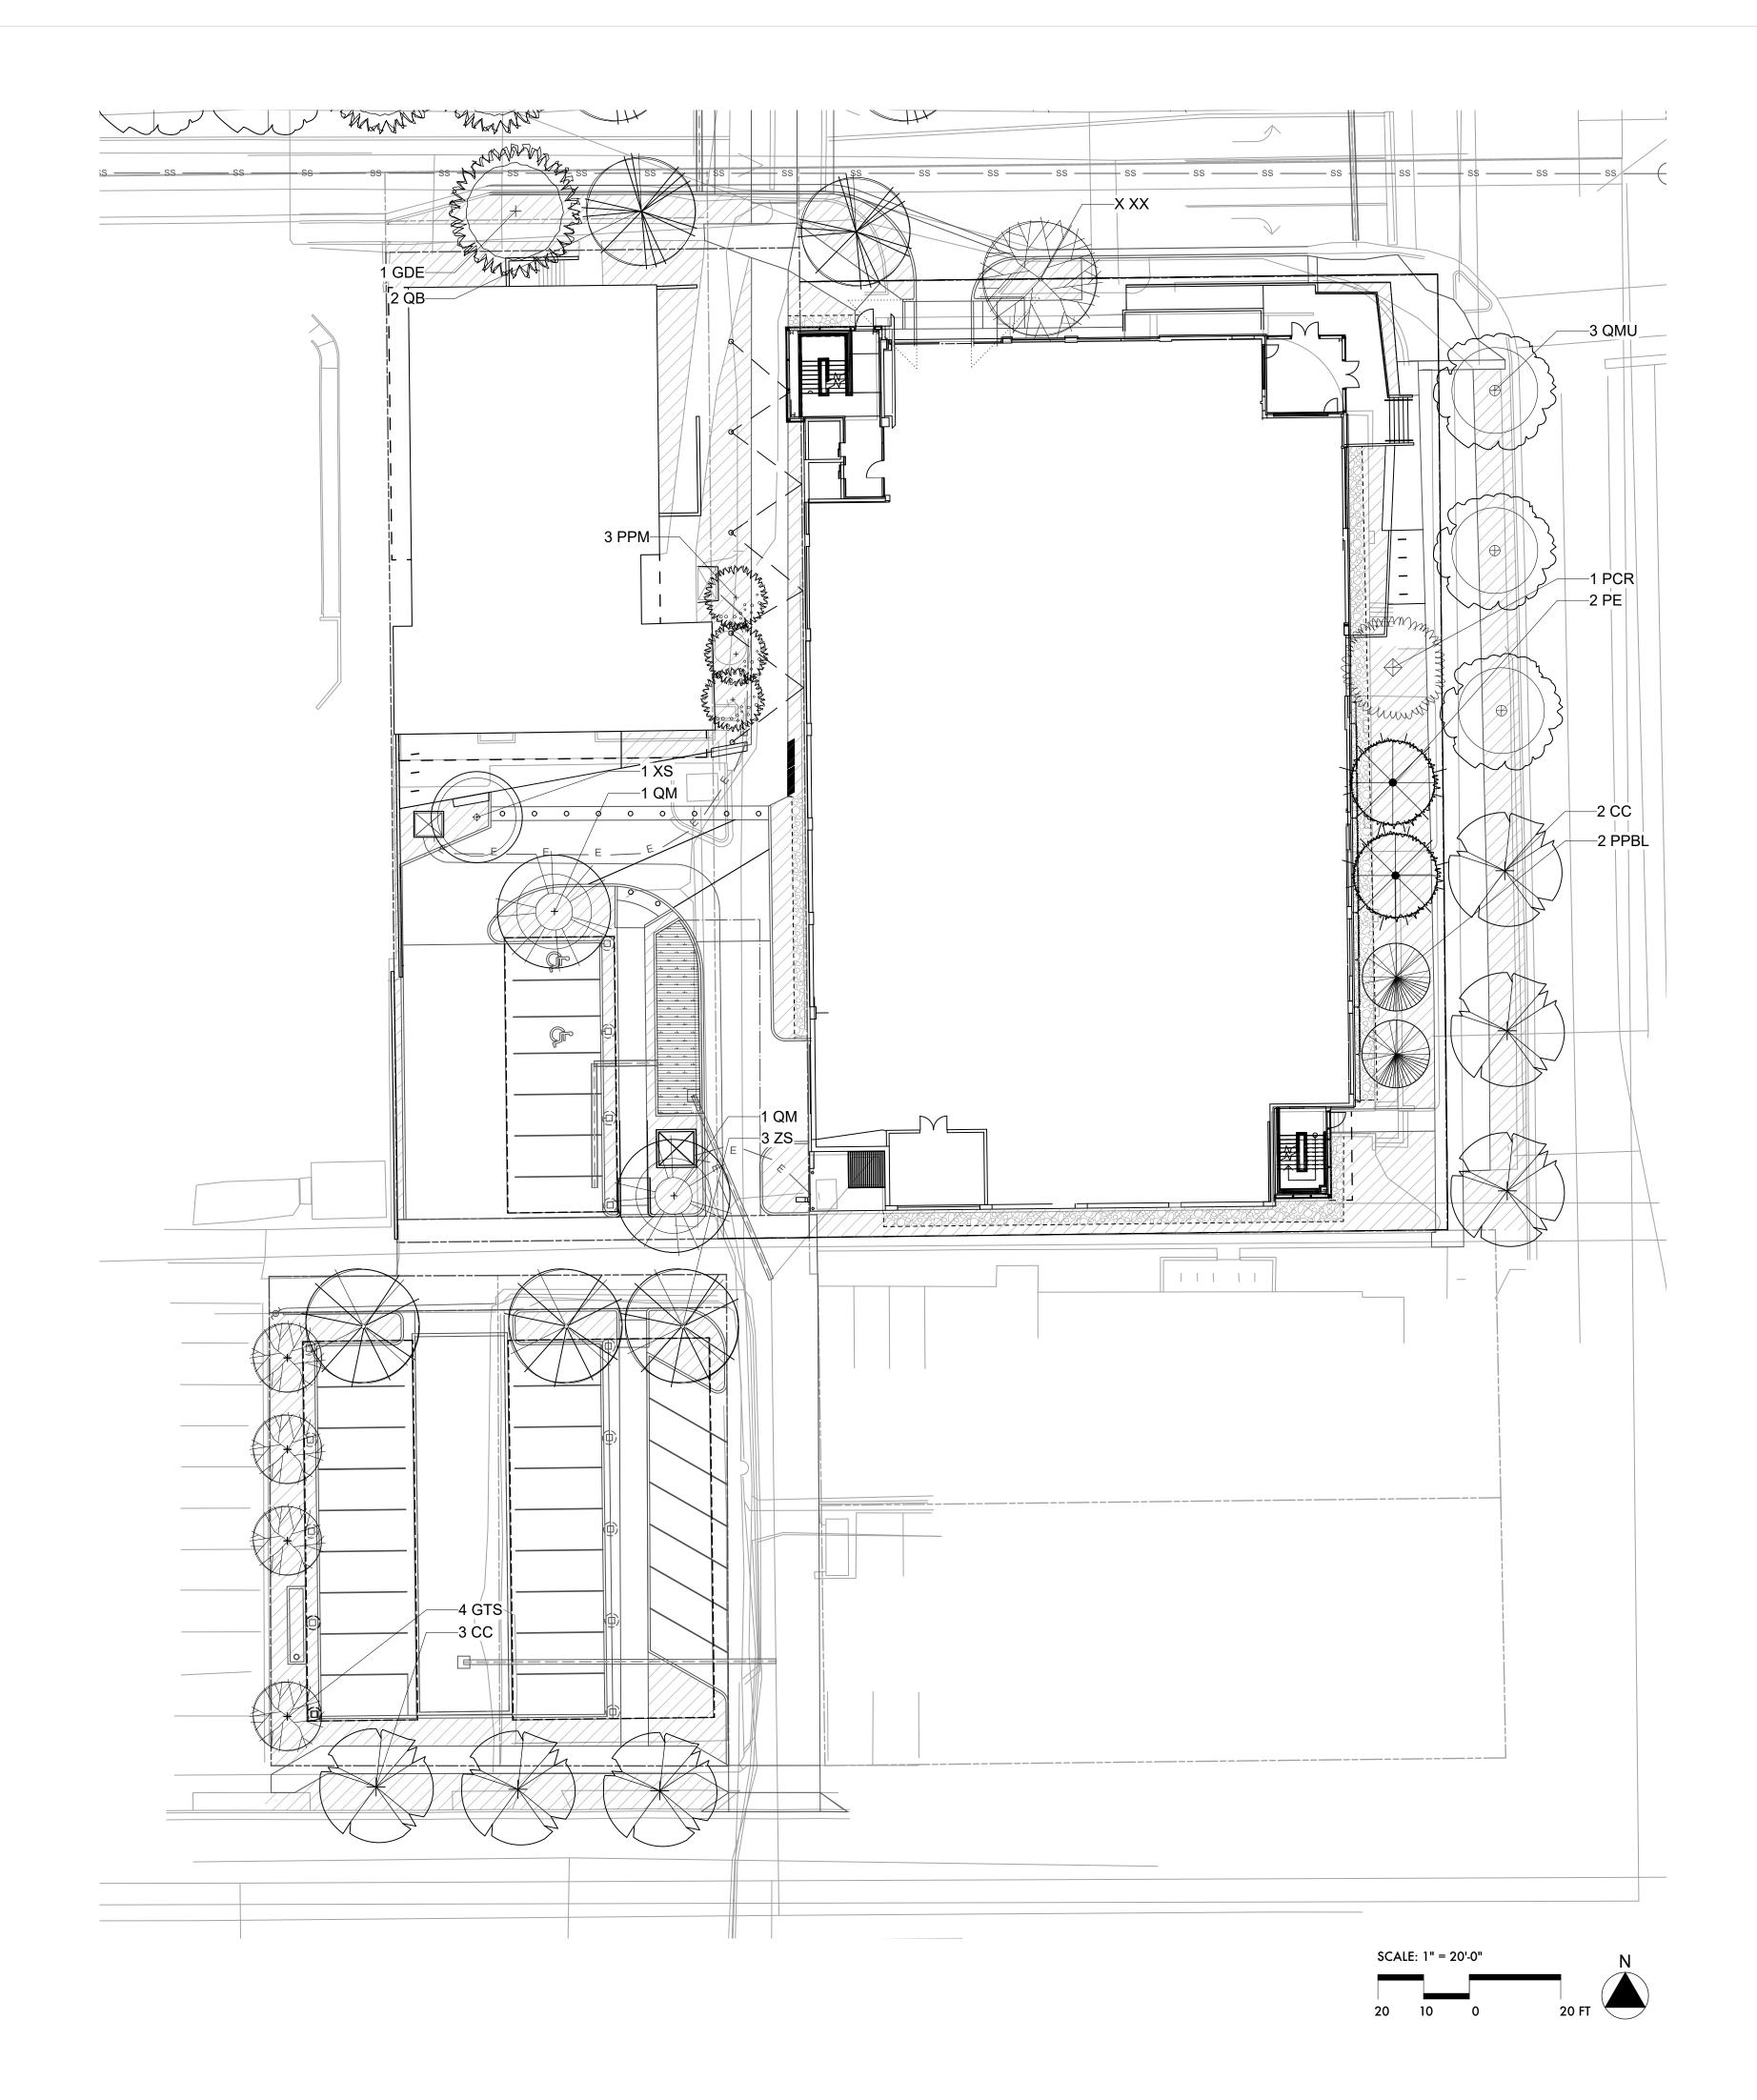

# TREE KEY


	MENTAL		
KEY	SIZE	BOTANICAL NAME	COMMON NAME
GTS	2.0" CAL	GLEDITSIA TRIACANTHOS STREET KEEPER	STREET KEEPER HONEYLOCUST
PPM	2.0" CAL	PRUNUS PADUS 'MERLOT'	PURPLE LEAF MAYDAY TREE
PCR	2.0" CAL	PYRUS CALLERYANA 'REDSPIRE'	REDSPIRE PEAR
XS	2.0" CAL	XANTHOCERAS SORBIFOLIA	YELLOWHORN
SHAD	E TREES		
-	-	BOTANICAL NAME	COMMON NAME
SHAD KEY CC	SIZE	BOTANICAL NAME CORYLUS COLURNA	COMMON NAME TURKISH FILBERT

KEY	SIZE
CC	2.5"
GDE	2.5"
QB	2.5'
QM	2.5"
QMU	2.5"
UXT	2.5"
ZS	2.5"

EVERG	GREE
KEY	SIZ
PPBL	6 F
PE	6 F

<b>SIGHT</b> PER BC OBSTRI	)
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SPECIE VISIBILI	
AREA.	

## LEGEND

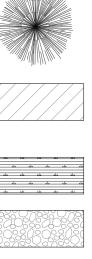

EXISTING TREE TO REMAIN

PLANTING BED - SHRUBS, ORN GRASSES, PERENNIALS -5 GAL SHRUBS, 1 GAL GRASSES AND PERENNIALS

PLANTING BED - WATER QUALITY PLANTINGS

ROCK MULCH

LANDSCAPE EDGER

" CAL GYMNOCLADUS DIOICUS 'ESPRESSO' " CAL QUERCUS BICOLOR

- " CAL QUERCUS MACROCARPA " CAL QUERCUS MUEHLENBERGII " CAL ULMUS X TRIUMPH
- " CAL ZELKOVA SERRATA 'GREEN VASE'

EN TREES **BOTANICAL NAME** 

T. PICEA PUNGENS 'BLUE TOTEM' FT. PINUS EDULIS

BUR OAK CHINKAPIN OAK TRIUMPH ELM GREEN VASE ZELKOVA COMMON NAME

SWAMP WHITE OAK

PINON PINE

FASTIGIATE SPRUCE

### TRIANGLE NOTES:

OULDER REVISED CODE 9-9-7(B):

UCTION PROHIBITED: NO PERSON SHALL PLACE OR MAINTAIN ANY TURES, FENCES, LANDSCAPING, OR ANY OTHER OBJECTS WITHIN ANY TRIANGLE AREA DESCRIBED IN SUBSECTION (C) OF THIS SECTION THAT UCTS OR OBSCURES SIGHT DISTANCE VISIBILITY THROUGH SUCH TURES, FENCING, LANDSCAPING, OR OTHER OBJECTS BY MORE THAN Y-FIVE PERCENT OF THE TOTAL VIEW IN THE VERTICAL PLANE ABOVE GHT TRIANGLE AREA BETWEEN A HEIGHT OF THIRTY INCHES AND -SIX INCHES ABOVE THE ROADWAY SURFACE, EXCEPT FOR THE WING:

LANDSCAPING, STRUCTURES, OR FENCES THAT PROTRUDE NO MORE THIRTY INCHES ABOVE THE ADJACENT ROADWAY SURFACE MAY BE TTED WITHIN THE SIGHT TRIANGLE AREA.

TREES MAY BE PLANTED AND MAINTAINED WITHIN THE SIGHT GLE AREA IF ALL BRANCHES ARE TRIMMED TO MAINTAIN A CLEAR VISION VERTICAL HEIGHT OF NINETY-SIX INCHES ABOVE THE ROADWAY CE AND THE LOCATION OF THE TREES PLANTED, BASED ON THE TREE S EXPECTED MATURE HEIGHT AND SIZE, DOES NOT OBSTRUCT SIGHT ITY BY MORE THAN TWENTY-FIVE PERCENT OF THE SIGHT TRIANGLE

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### Consultant CIVIL

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2995 55TH STREET, #17983 BOULDER, CO 80301 T 720 491 1167

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STRUCTURAL ANTHEM STRUCTURAL ENGINEERS FLATIRON OFFICE PARK 2213 CENTRAL AVENUE BOULDER, CO 80301 T 303 848 8497

MEP BRANCH PATTERN 3344 WALNUT STREET DENVER, CO 80205 T 303 382 1920

LIGHTING AE DESIGN 1900 WAZEE STREET, #205 DENVER, CO 80202 T 303 296 3034

AV/TECHNOLOGY/SECURITY SALAS O'BRIEN

4900 NAUTILUS CT. N. SUITE 200 BOULDER, CO 80301 T 303 865 5500

Full Design Team Roster on Sheet 1-G0.01 Client and Project Information



Boulder Western City Campus - Volume 2 Garage & Brenton 2655 BROADWAY Boulder, CO 80302

Original Issue

Key Plan and Orientation

Revision


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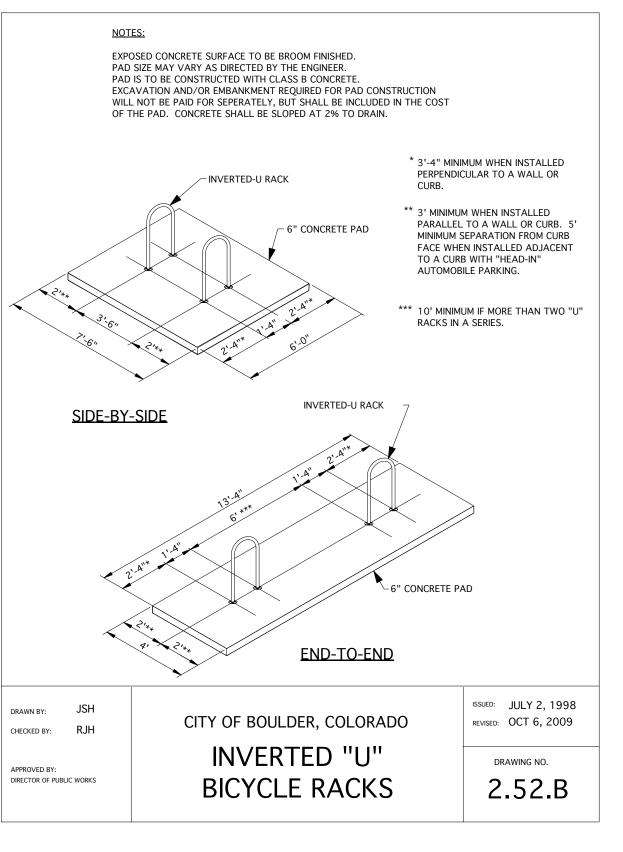
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LANDSCAPE PLAN



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Boulder Western City Campus - Volume 2 Garage & Brenton 2655 BROADWAY Boulder, CO 80302

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PLANTING DETAILS

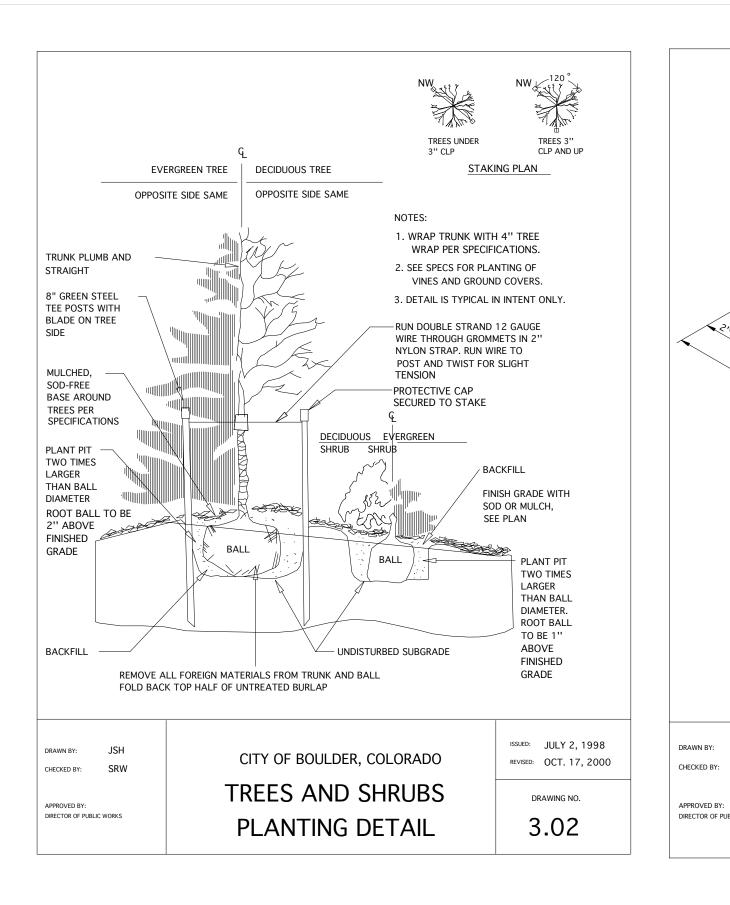


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T 303 865 5500

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DESCRIPTION DESIGN DEVELOPMENT ESTIMATE SET

Revisions

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Sheet Number
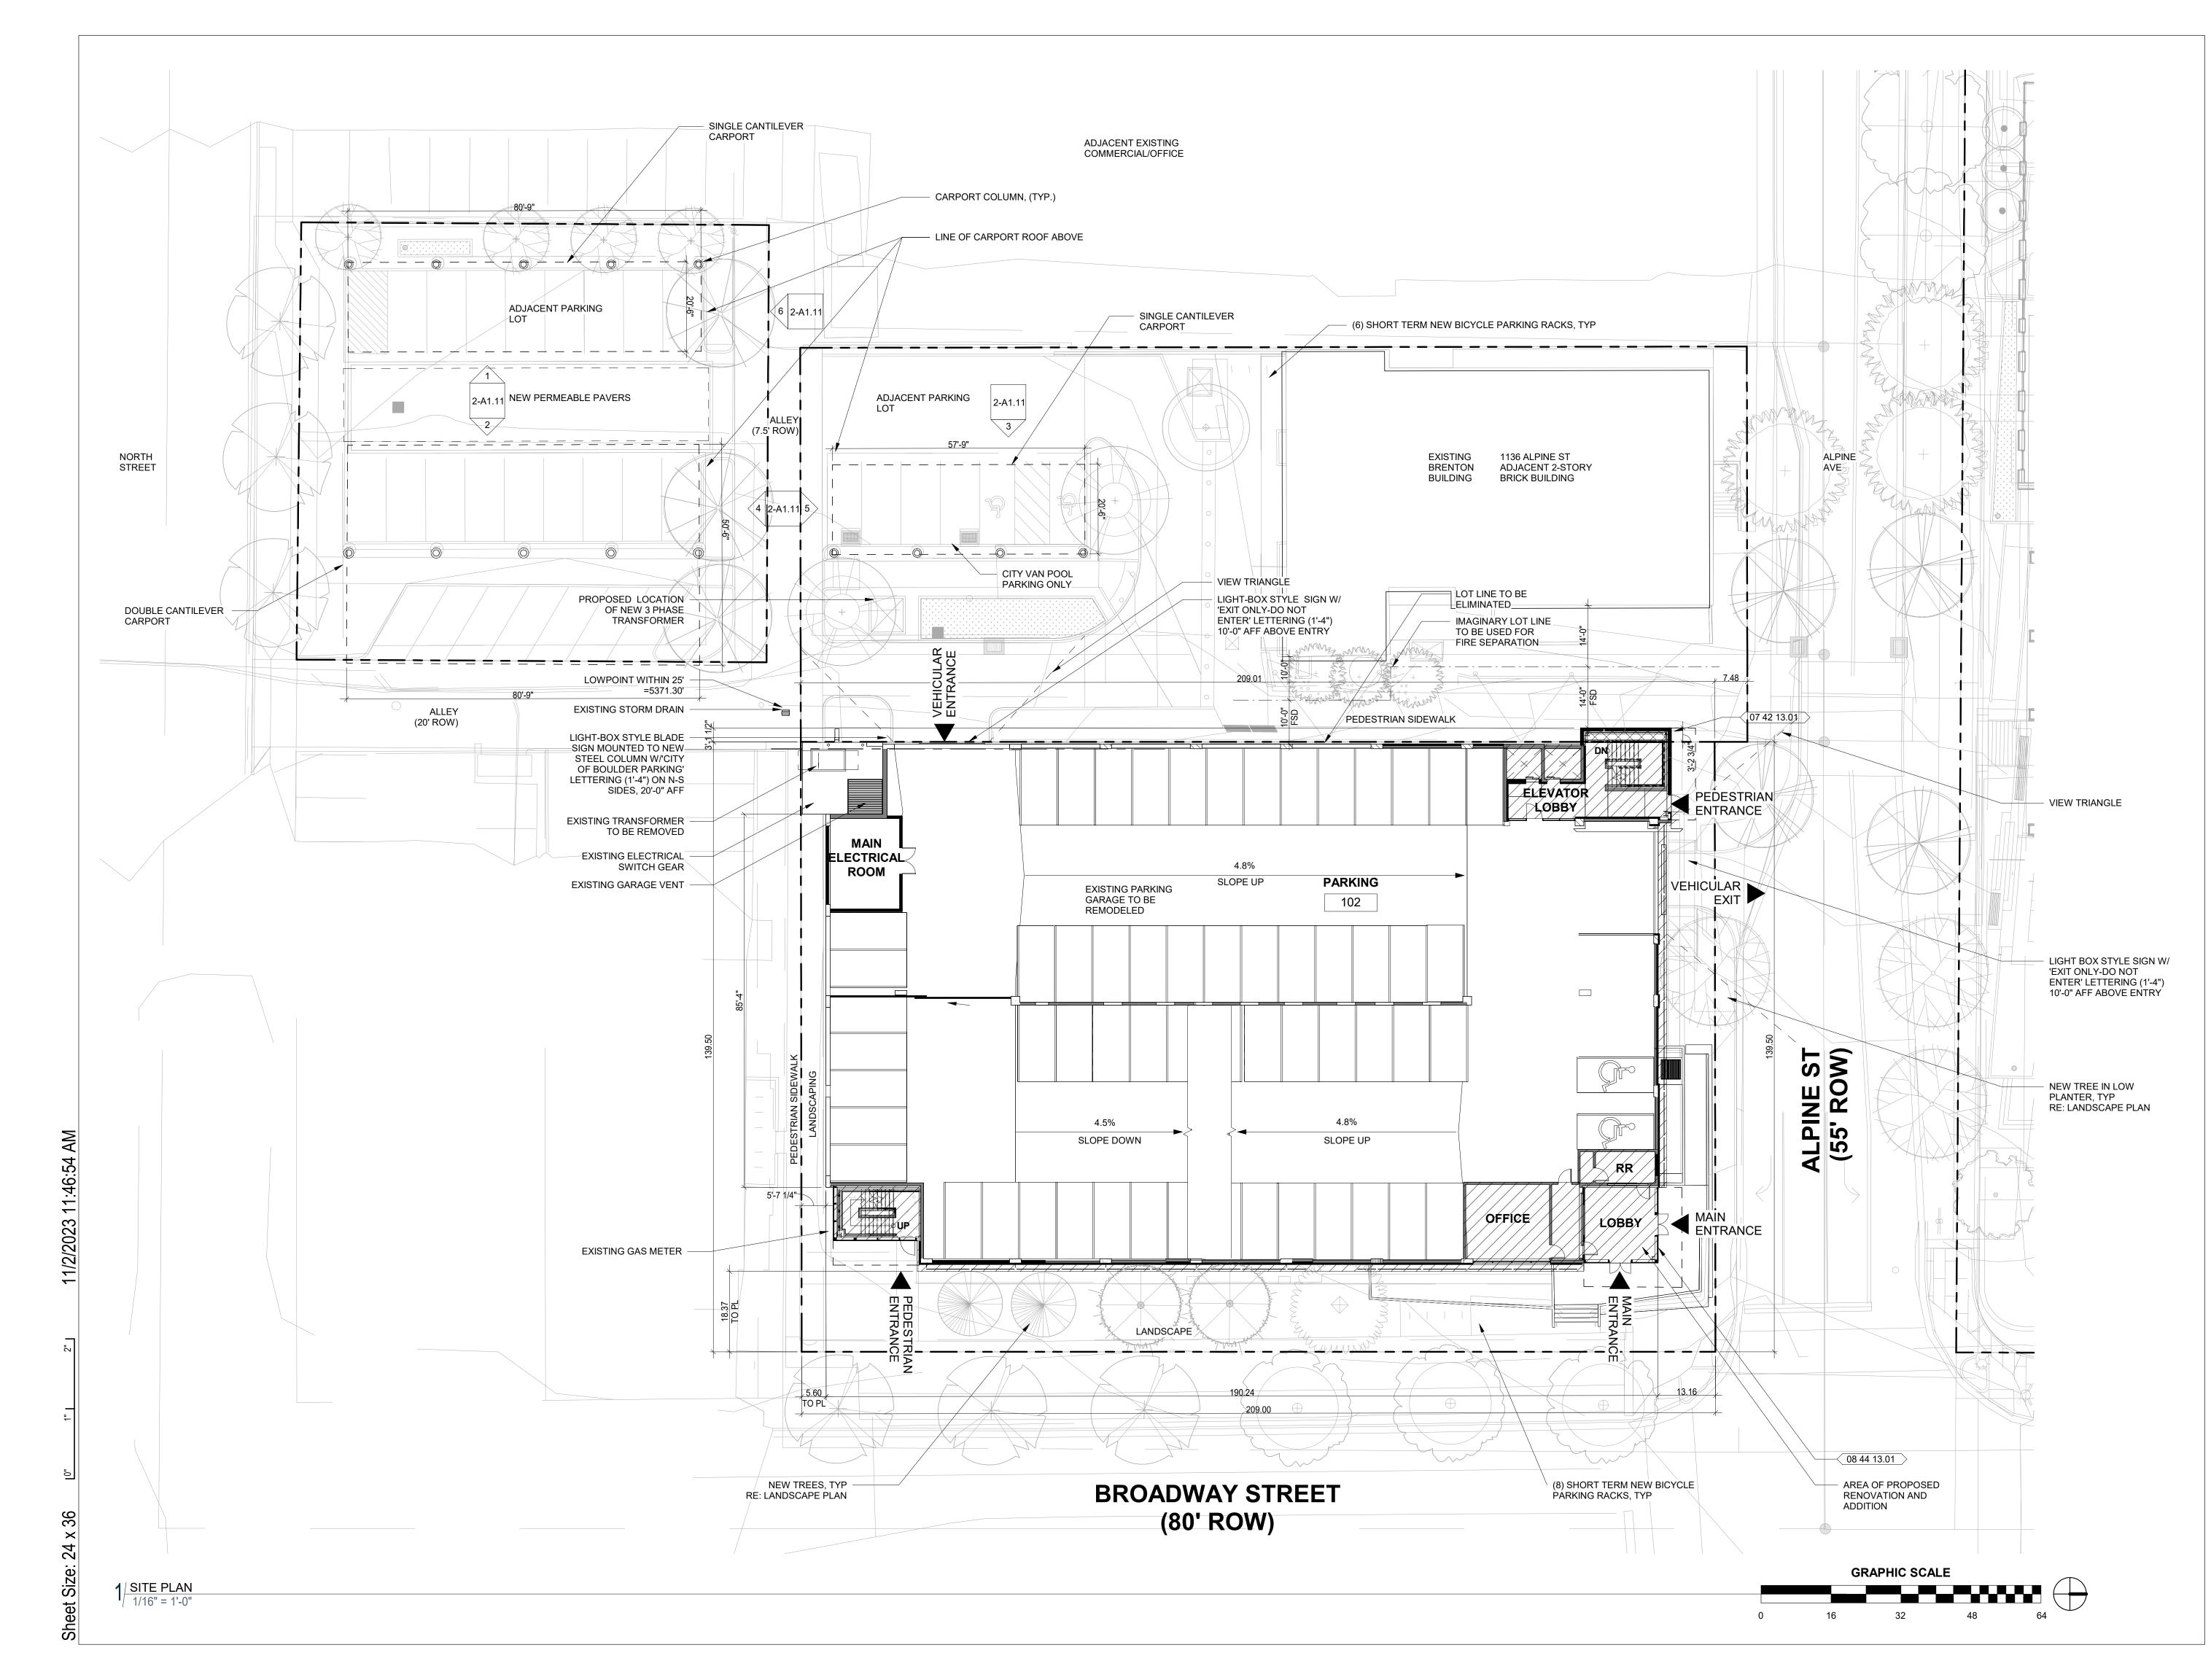
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ARCHITECTURAL SITE PLAN

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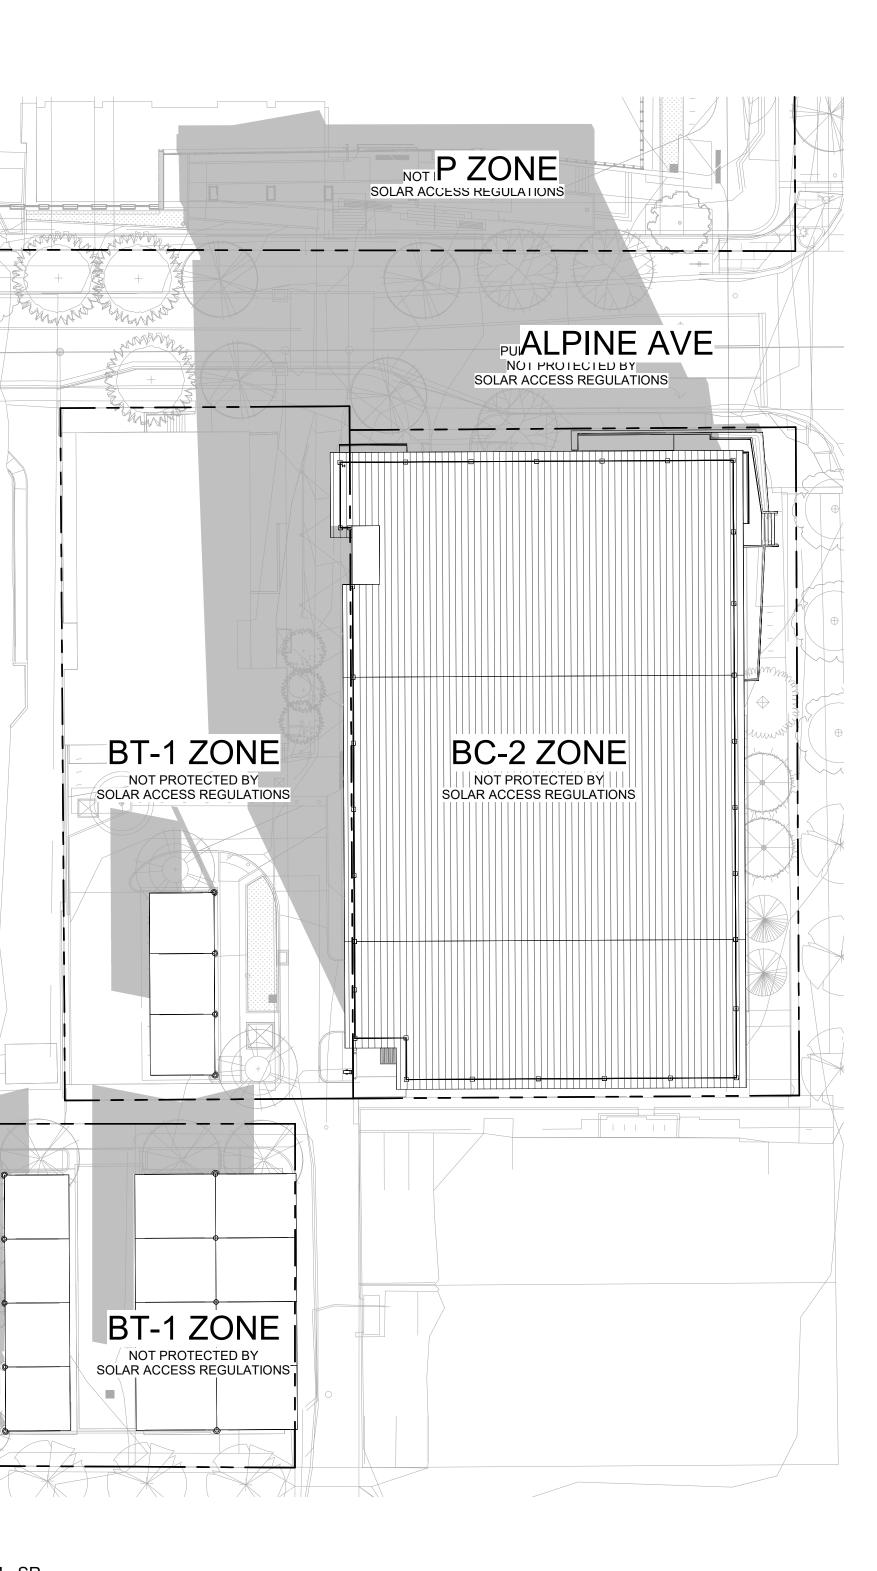
2/ SHADOW ANALYSIS - 10AM - SR 1" = 30'-0"


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1/ SHADOW ANALYSIS - 2PM - SR 1" = 30'-0"



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BOULDER, CO 80301 T 303 865 5500 Full Design Team Roster on Sheet 1-G0.0

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Revisions

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Sheet Title

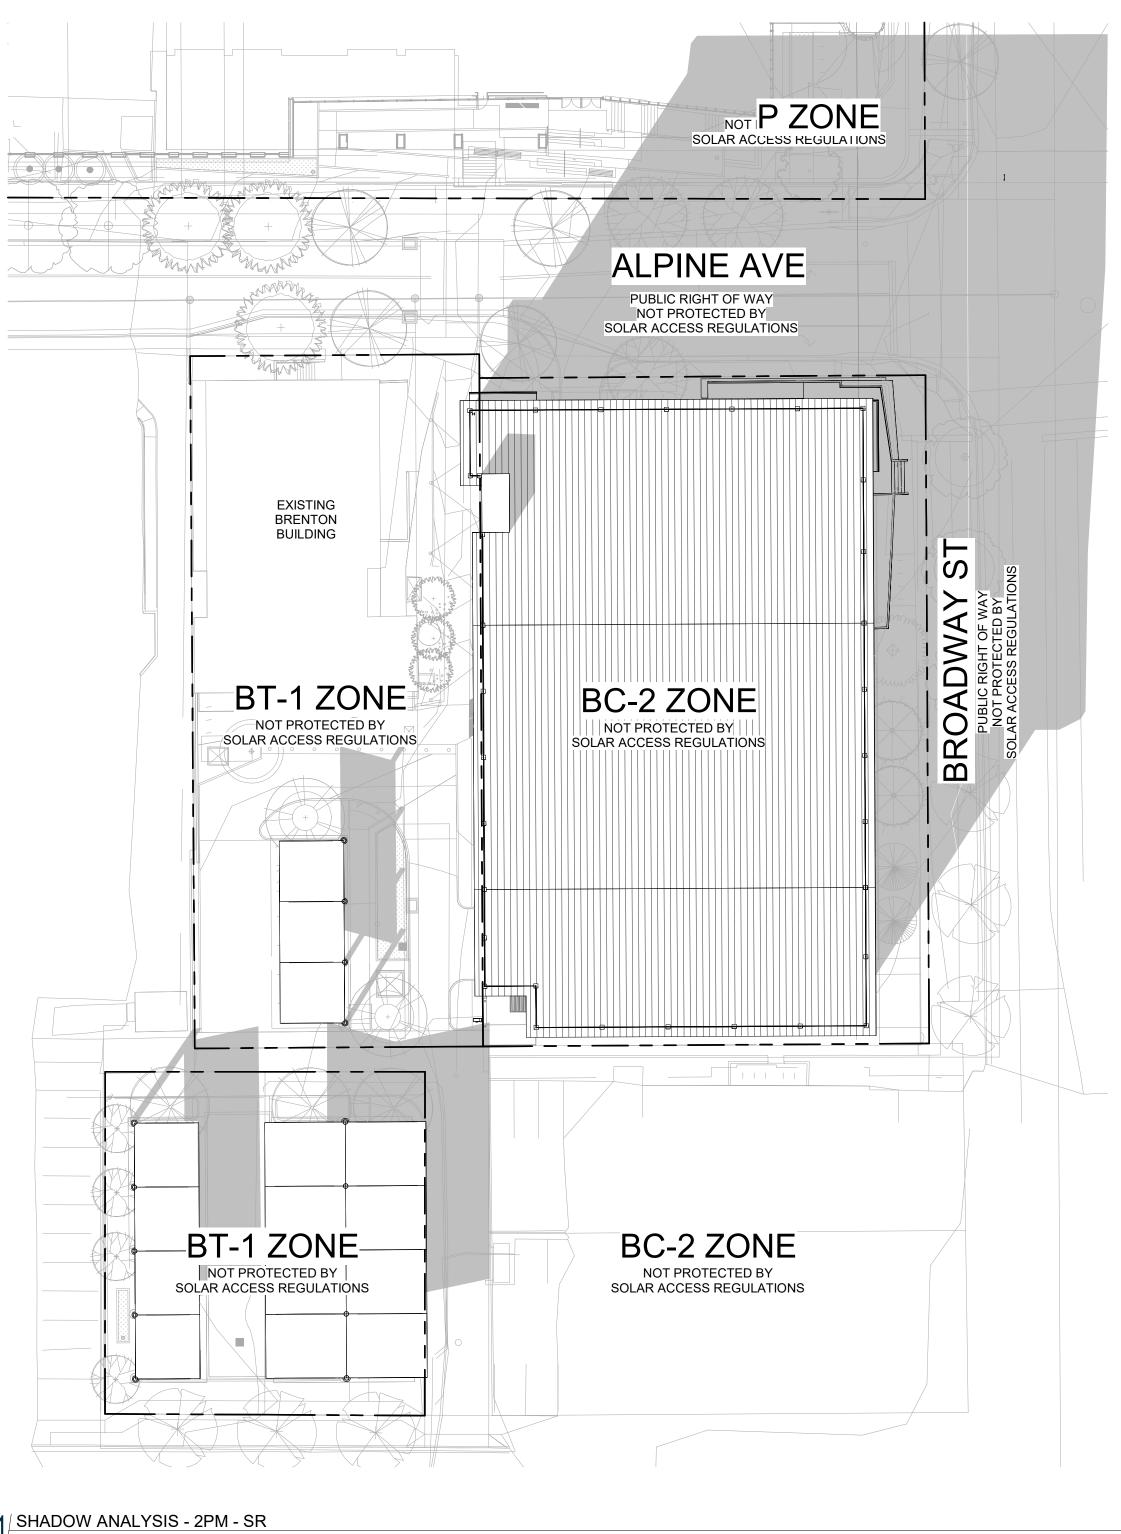Sheet Number

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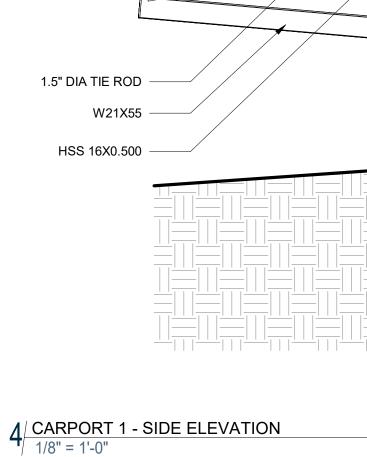
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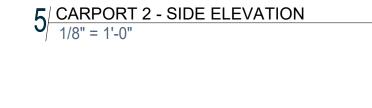
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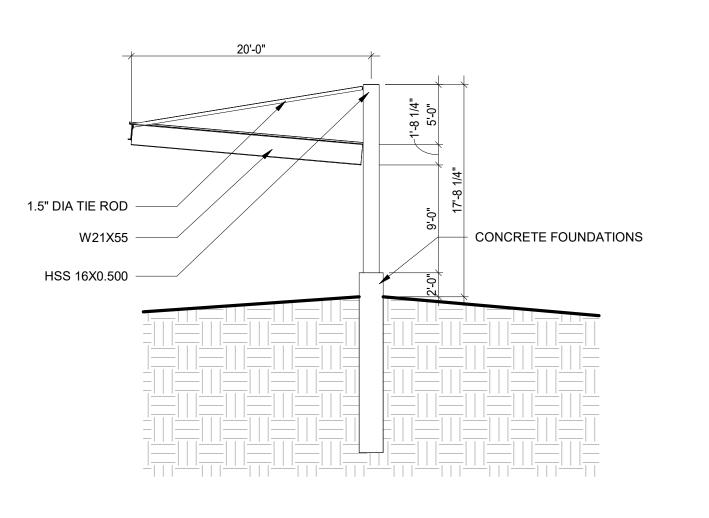
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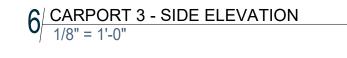
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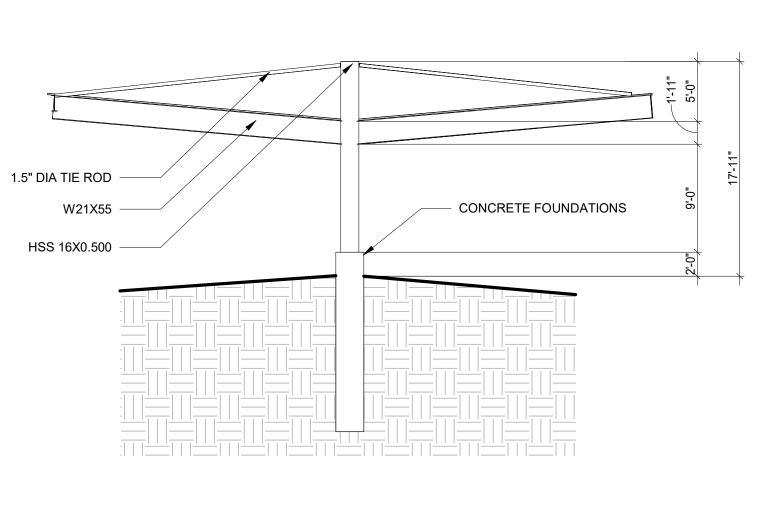


20'-0"















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Full Design Team Roster on Sheet 1-G0.01 Client and Project Information

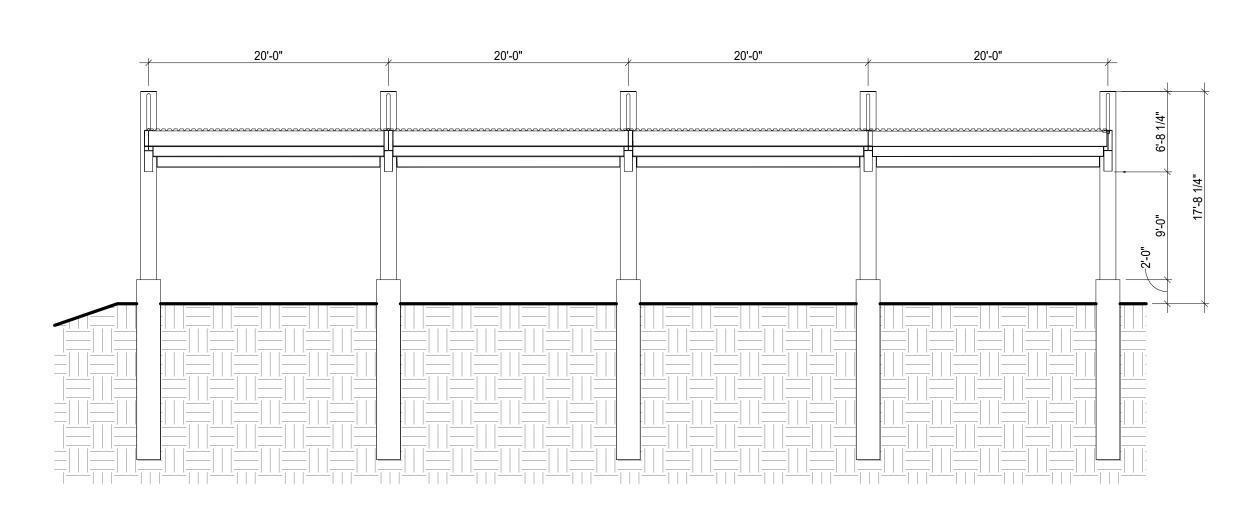

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DESCRIPTION

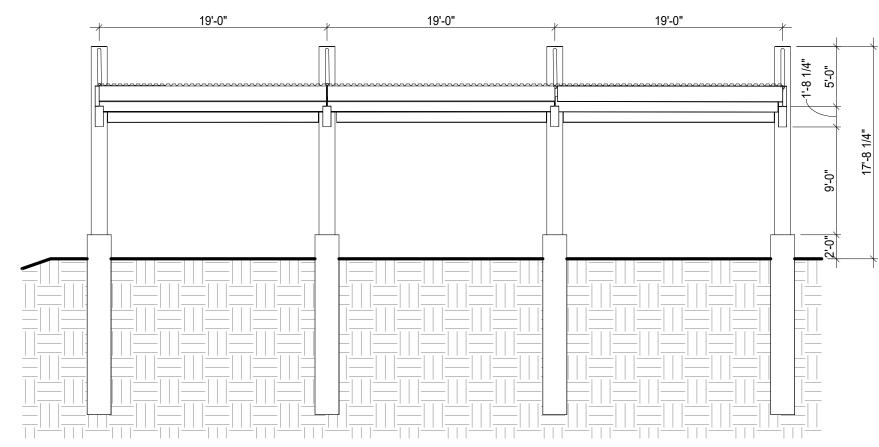
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Sheet Title SITE DETAILS

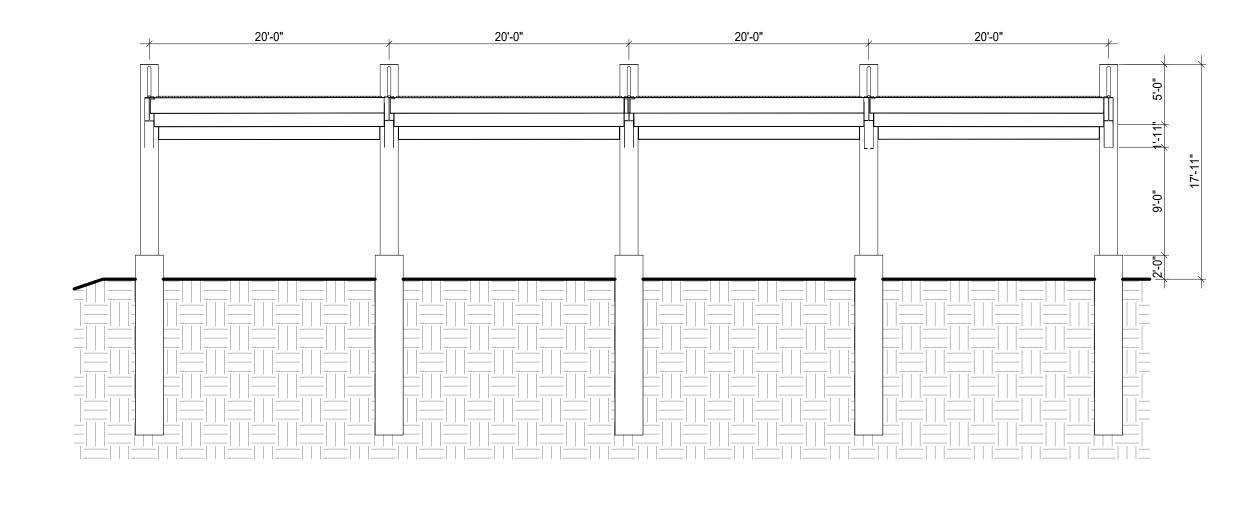Sheet Number

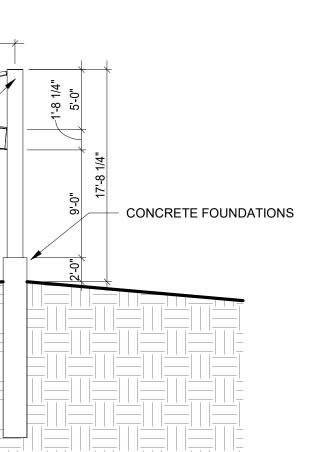Current Issue



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# PARKING SPACE COLOR LEGEND

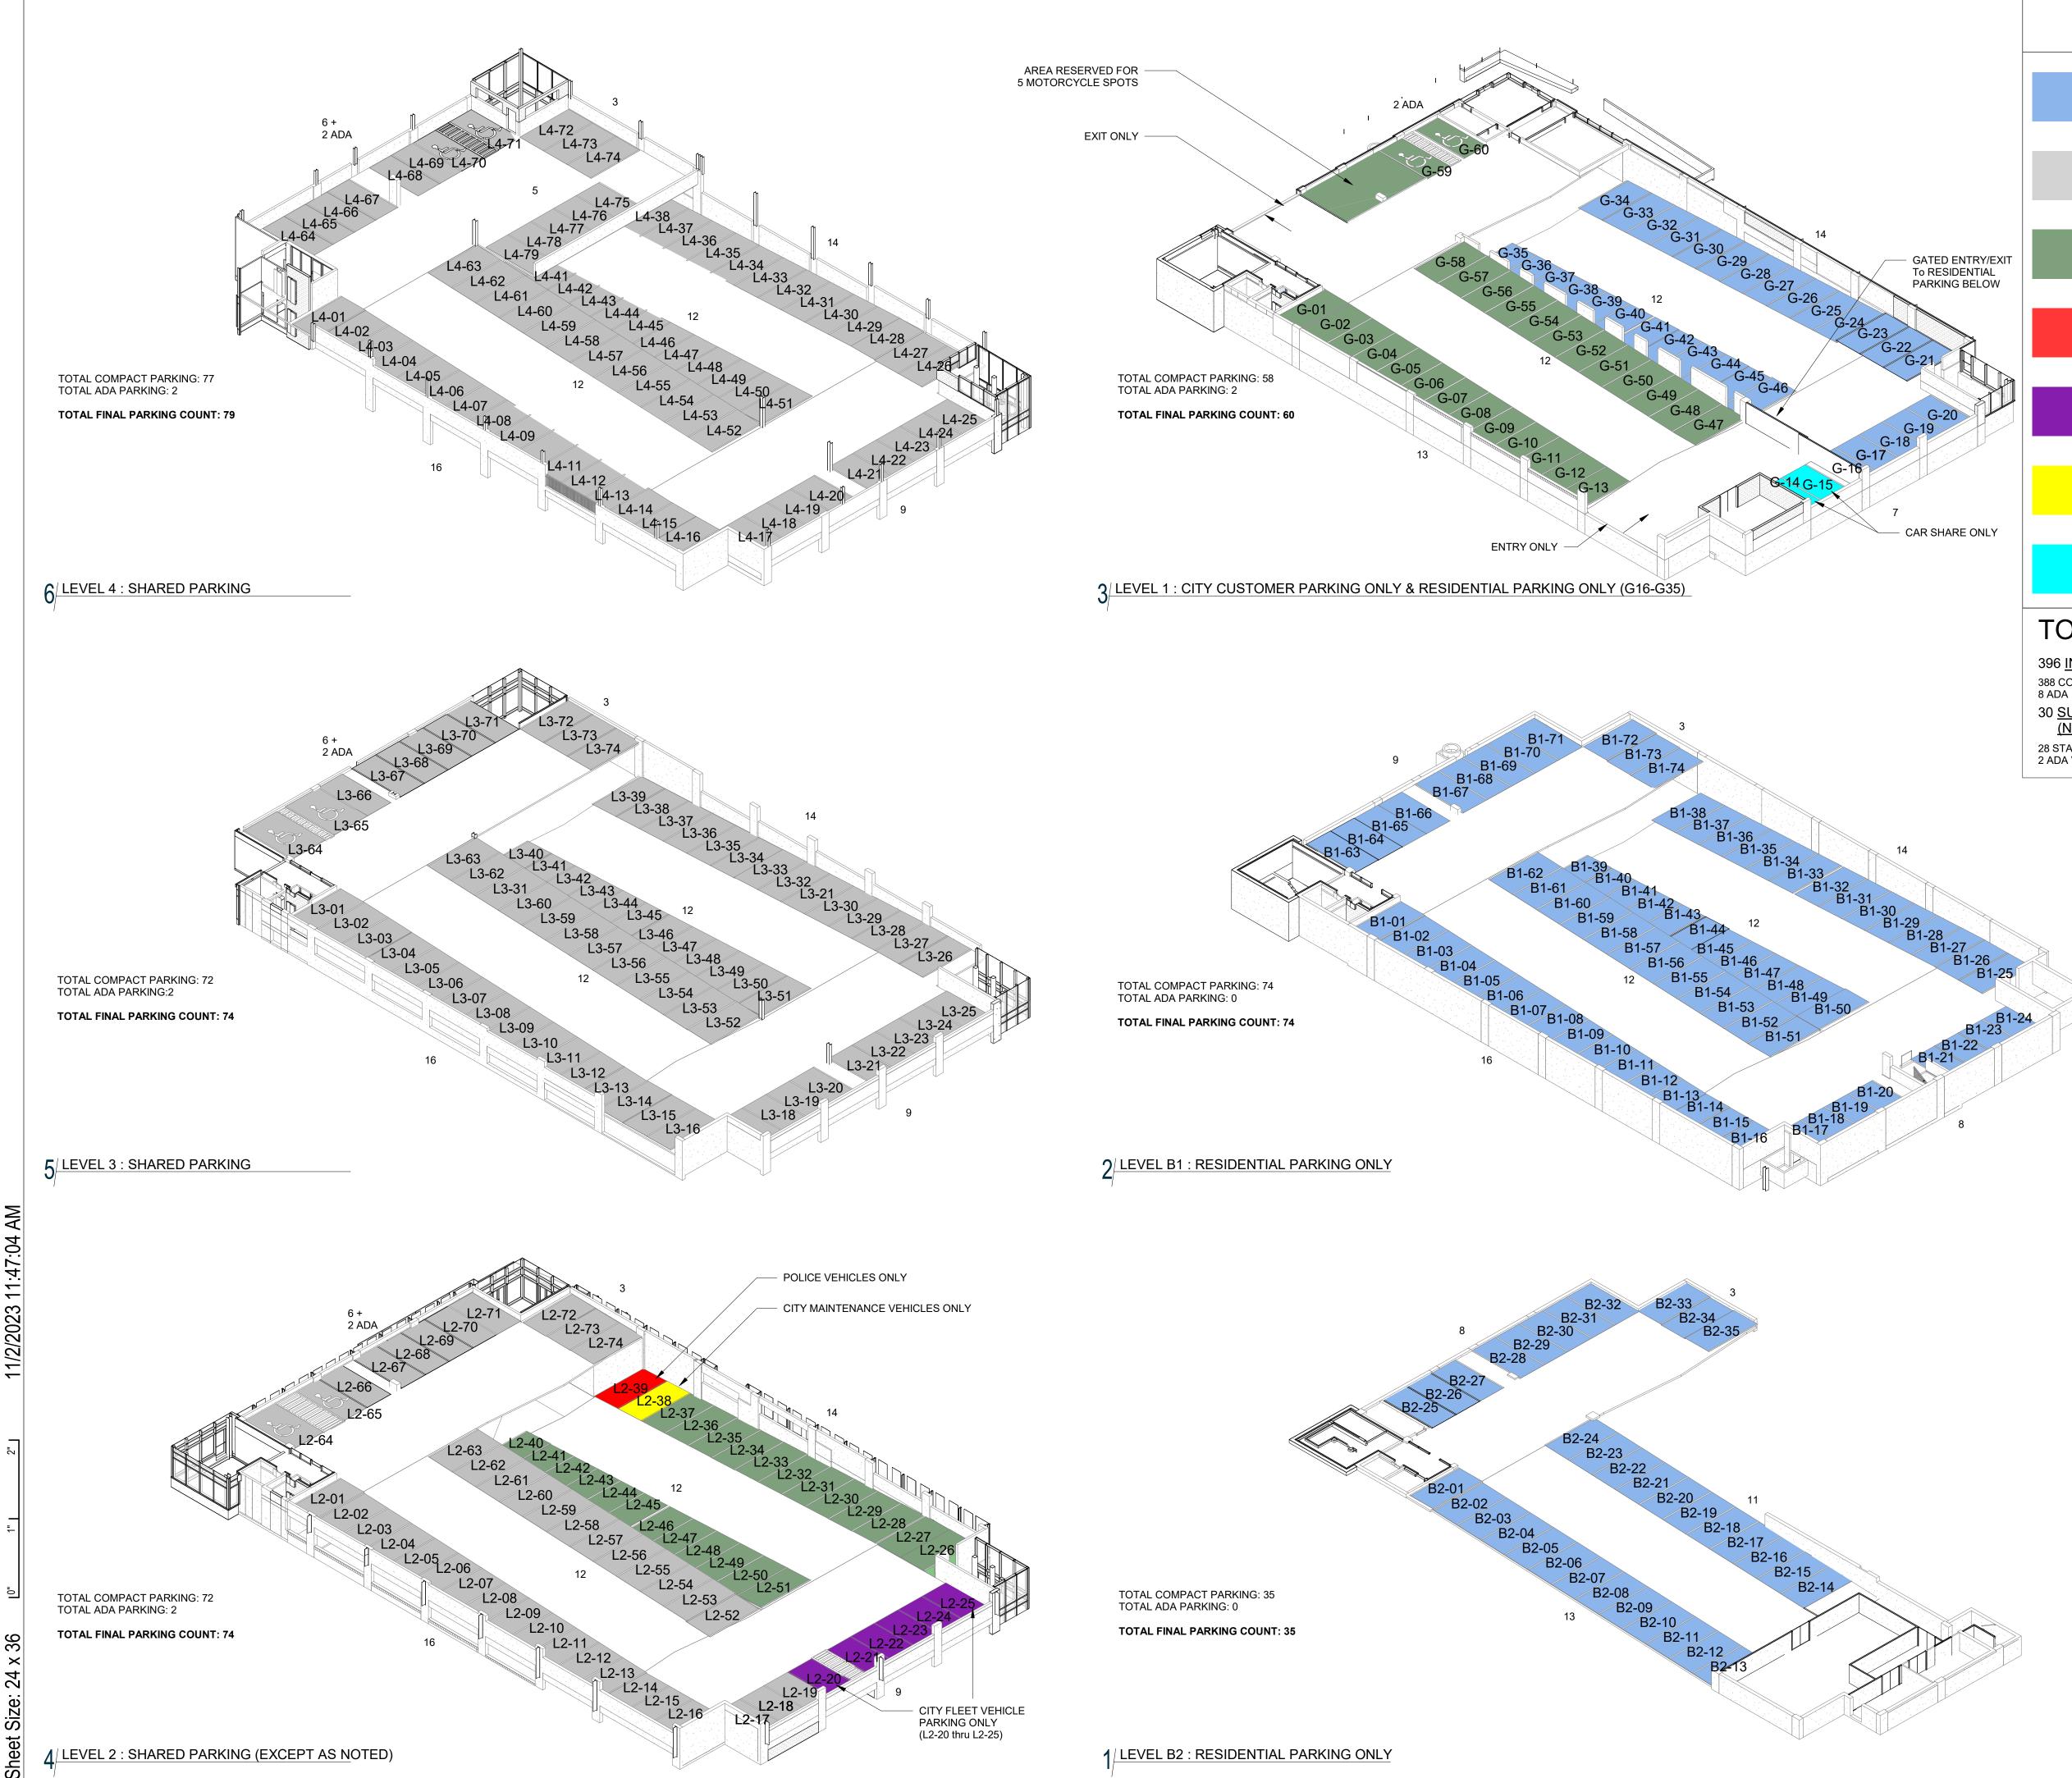**RESIDENTIAL PARKING SPACE** TOTAL PARKING SPACES: 140 REGULAR PARKING: 140 ADA PARKING: 0

SHARED PARKING SPACE TOTAL PARKING SPACES: 195 REGULAR PARKING: 189 ADA PARKING: 6

CITY CUSTOMER PARKING SPACE TOTAL PARKING SPACES: 51 REGULAR PARKING: 49 ADA PARKING: 2

POLICE PARKING SPACE **REGULAR PARKING: 1** 

CITY FLEET VEHICLE PARKING SPACE **REGULAR PARKING: 6** 

MAINTENANCE PARKING SPACE **REGULAR PARKING: 1** 

CAR SHARE PARKING SPACE **REGULAR PARKING: 2** 

# TOTAL PARKING = 426 CARS

396 IN PARKING STRUCTURE 388 COMPACT SPACES

30 SURFACE PARKING SPACES ON ADJACENT LOTS (NOT SHOWN. REFER TO SITE PLAN) **28 STANDARD SPACES** 

2 ADA VAN



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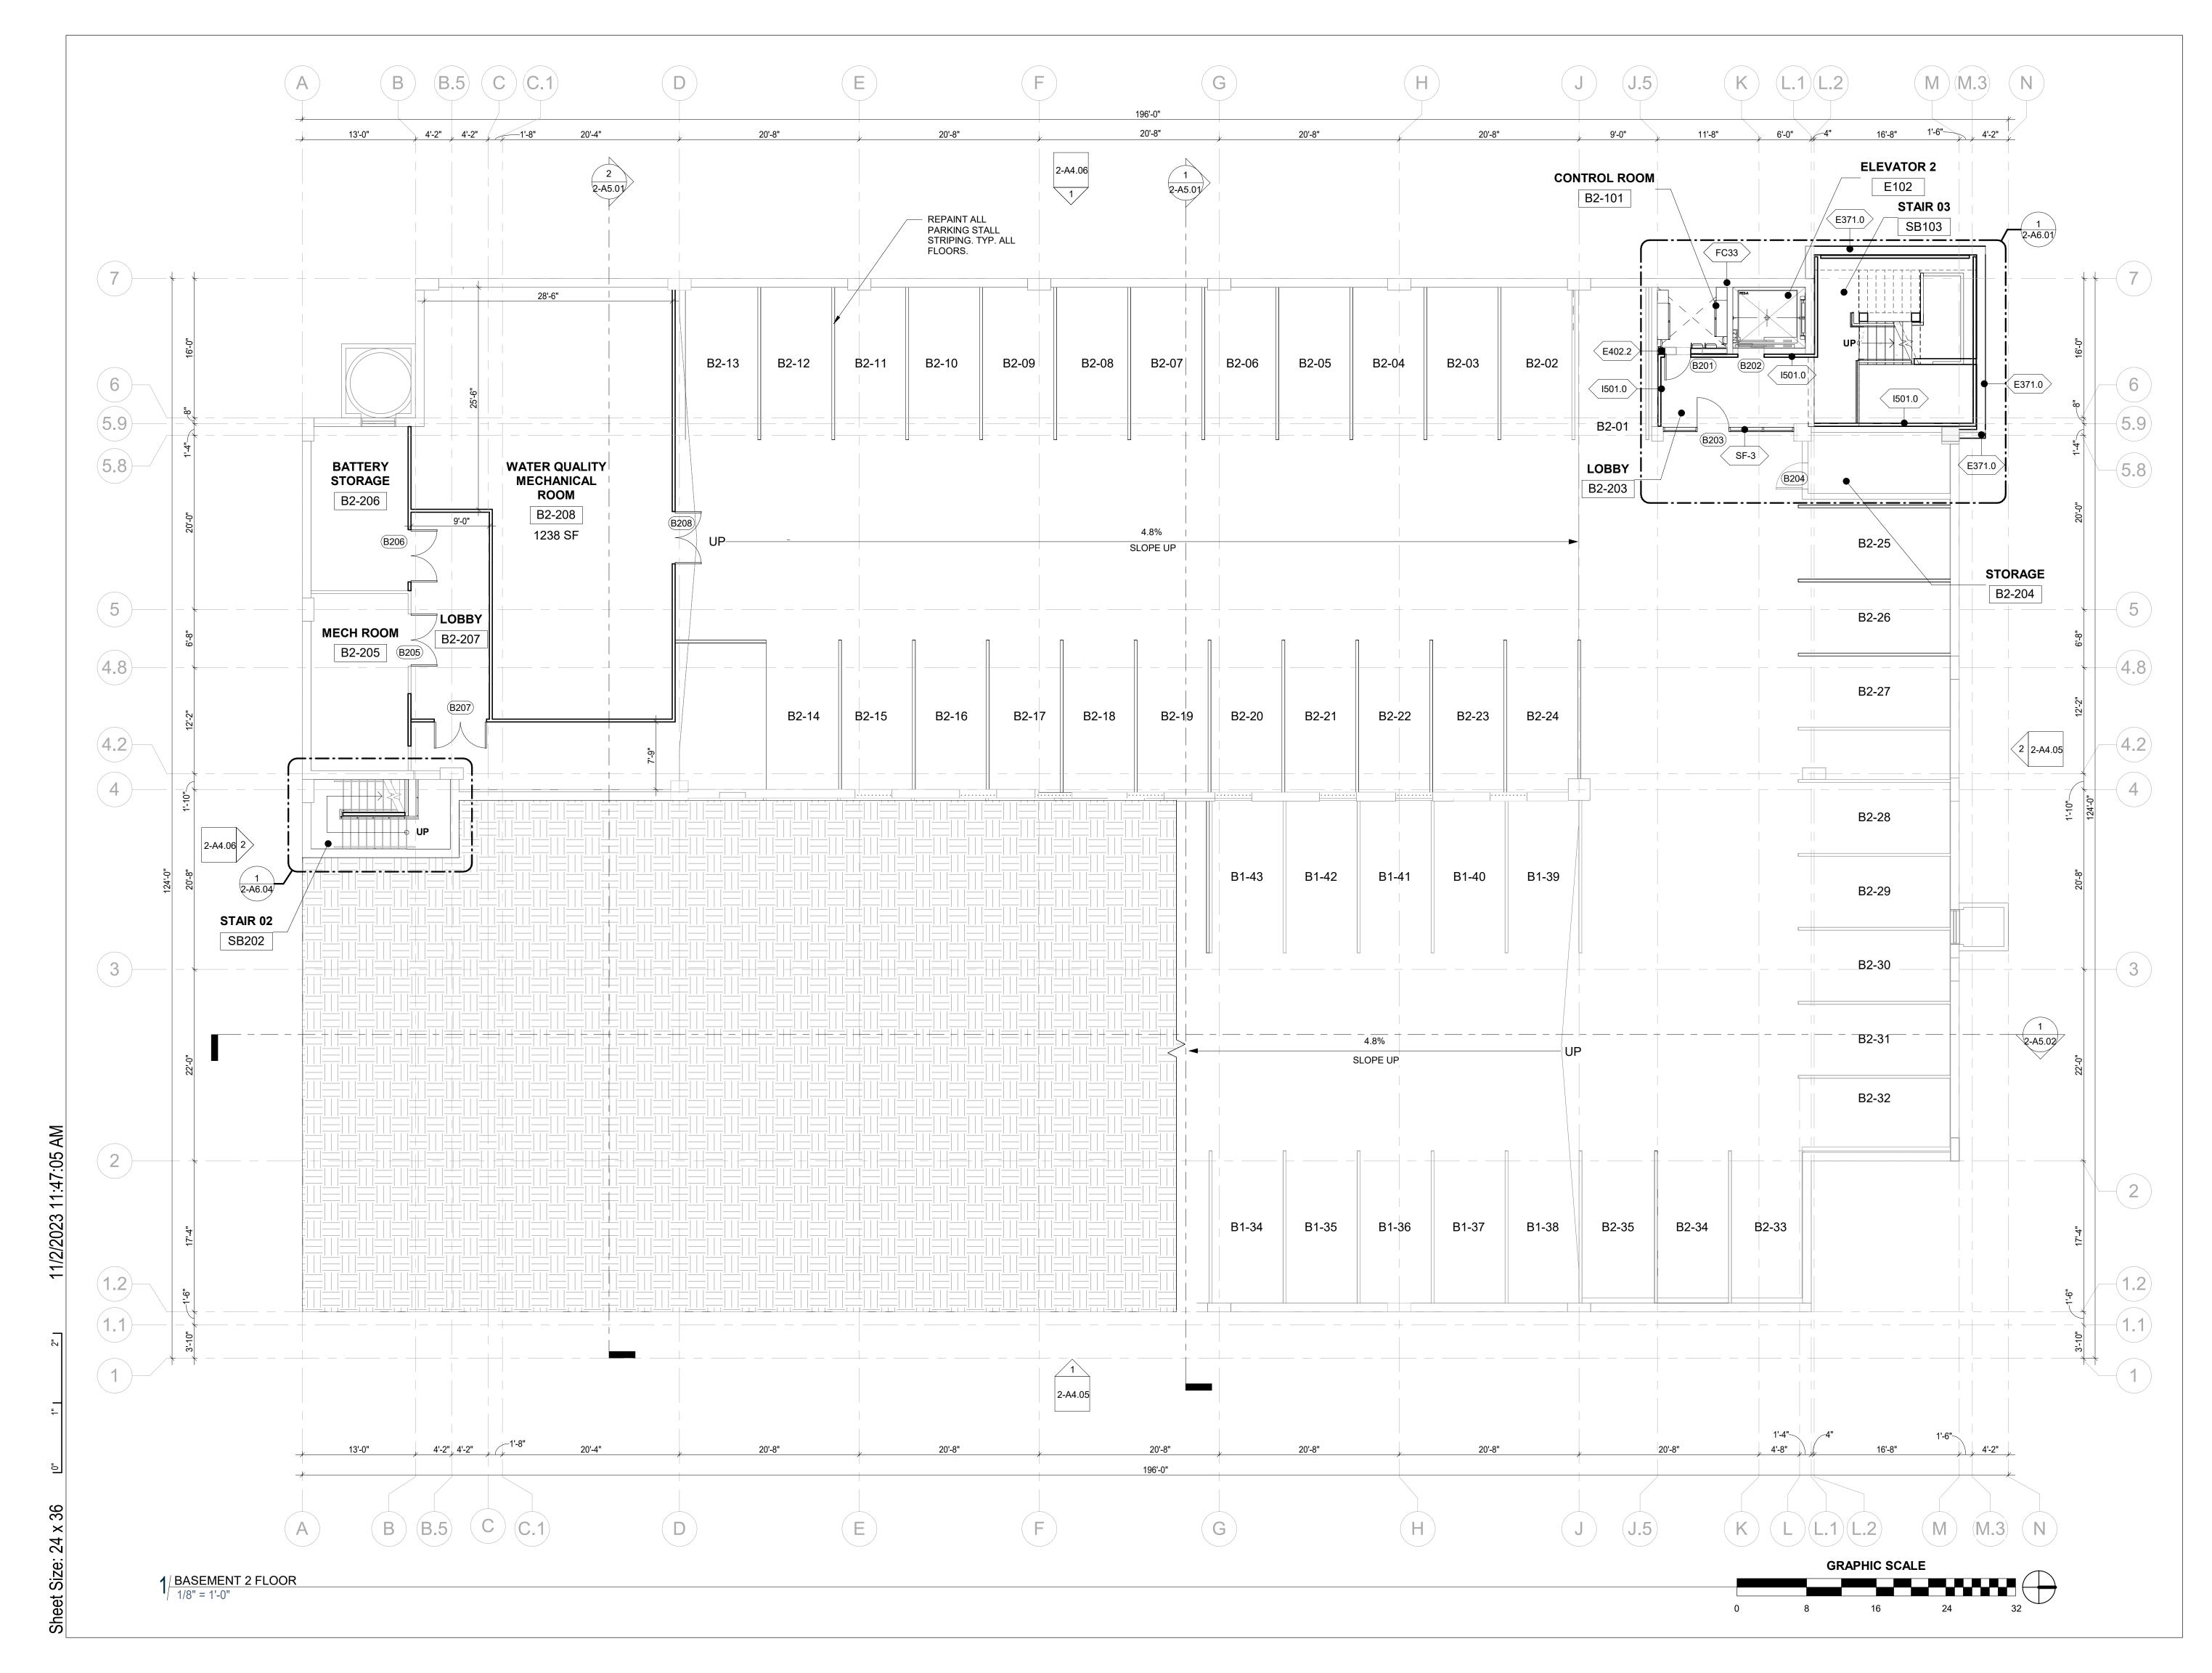
PARKING DIAGRAMS



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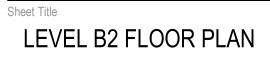
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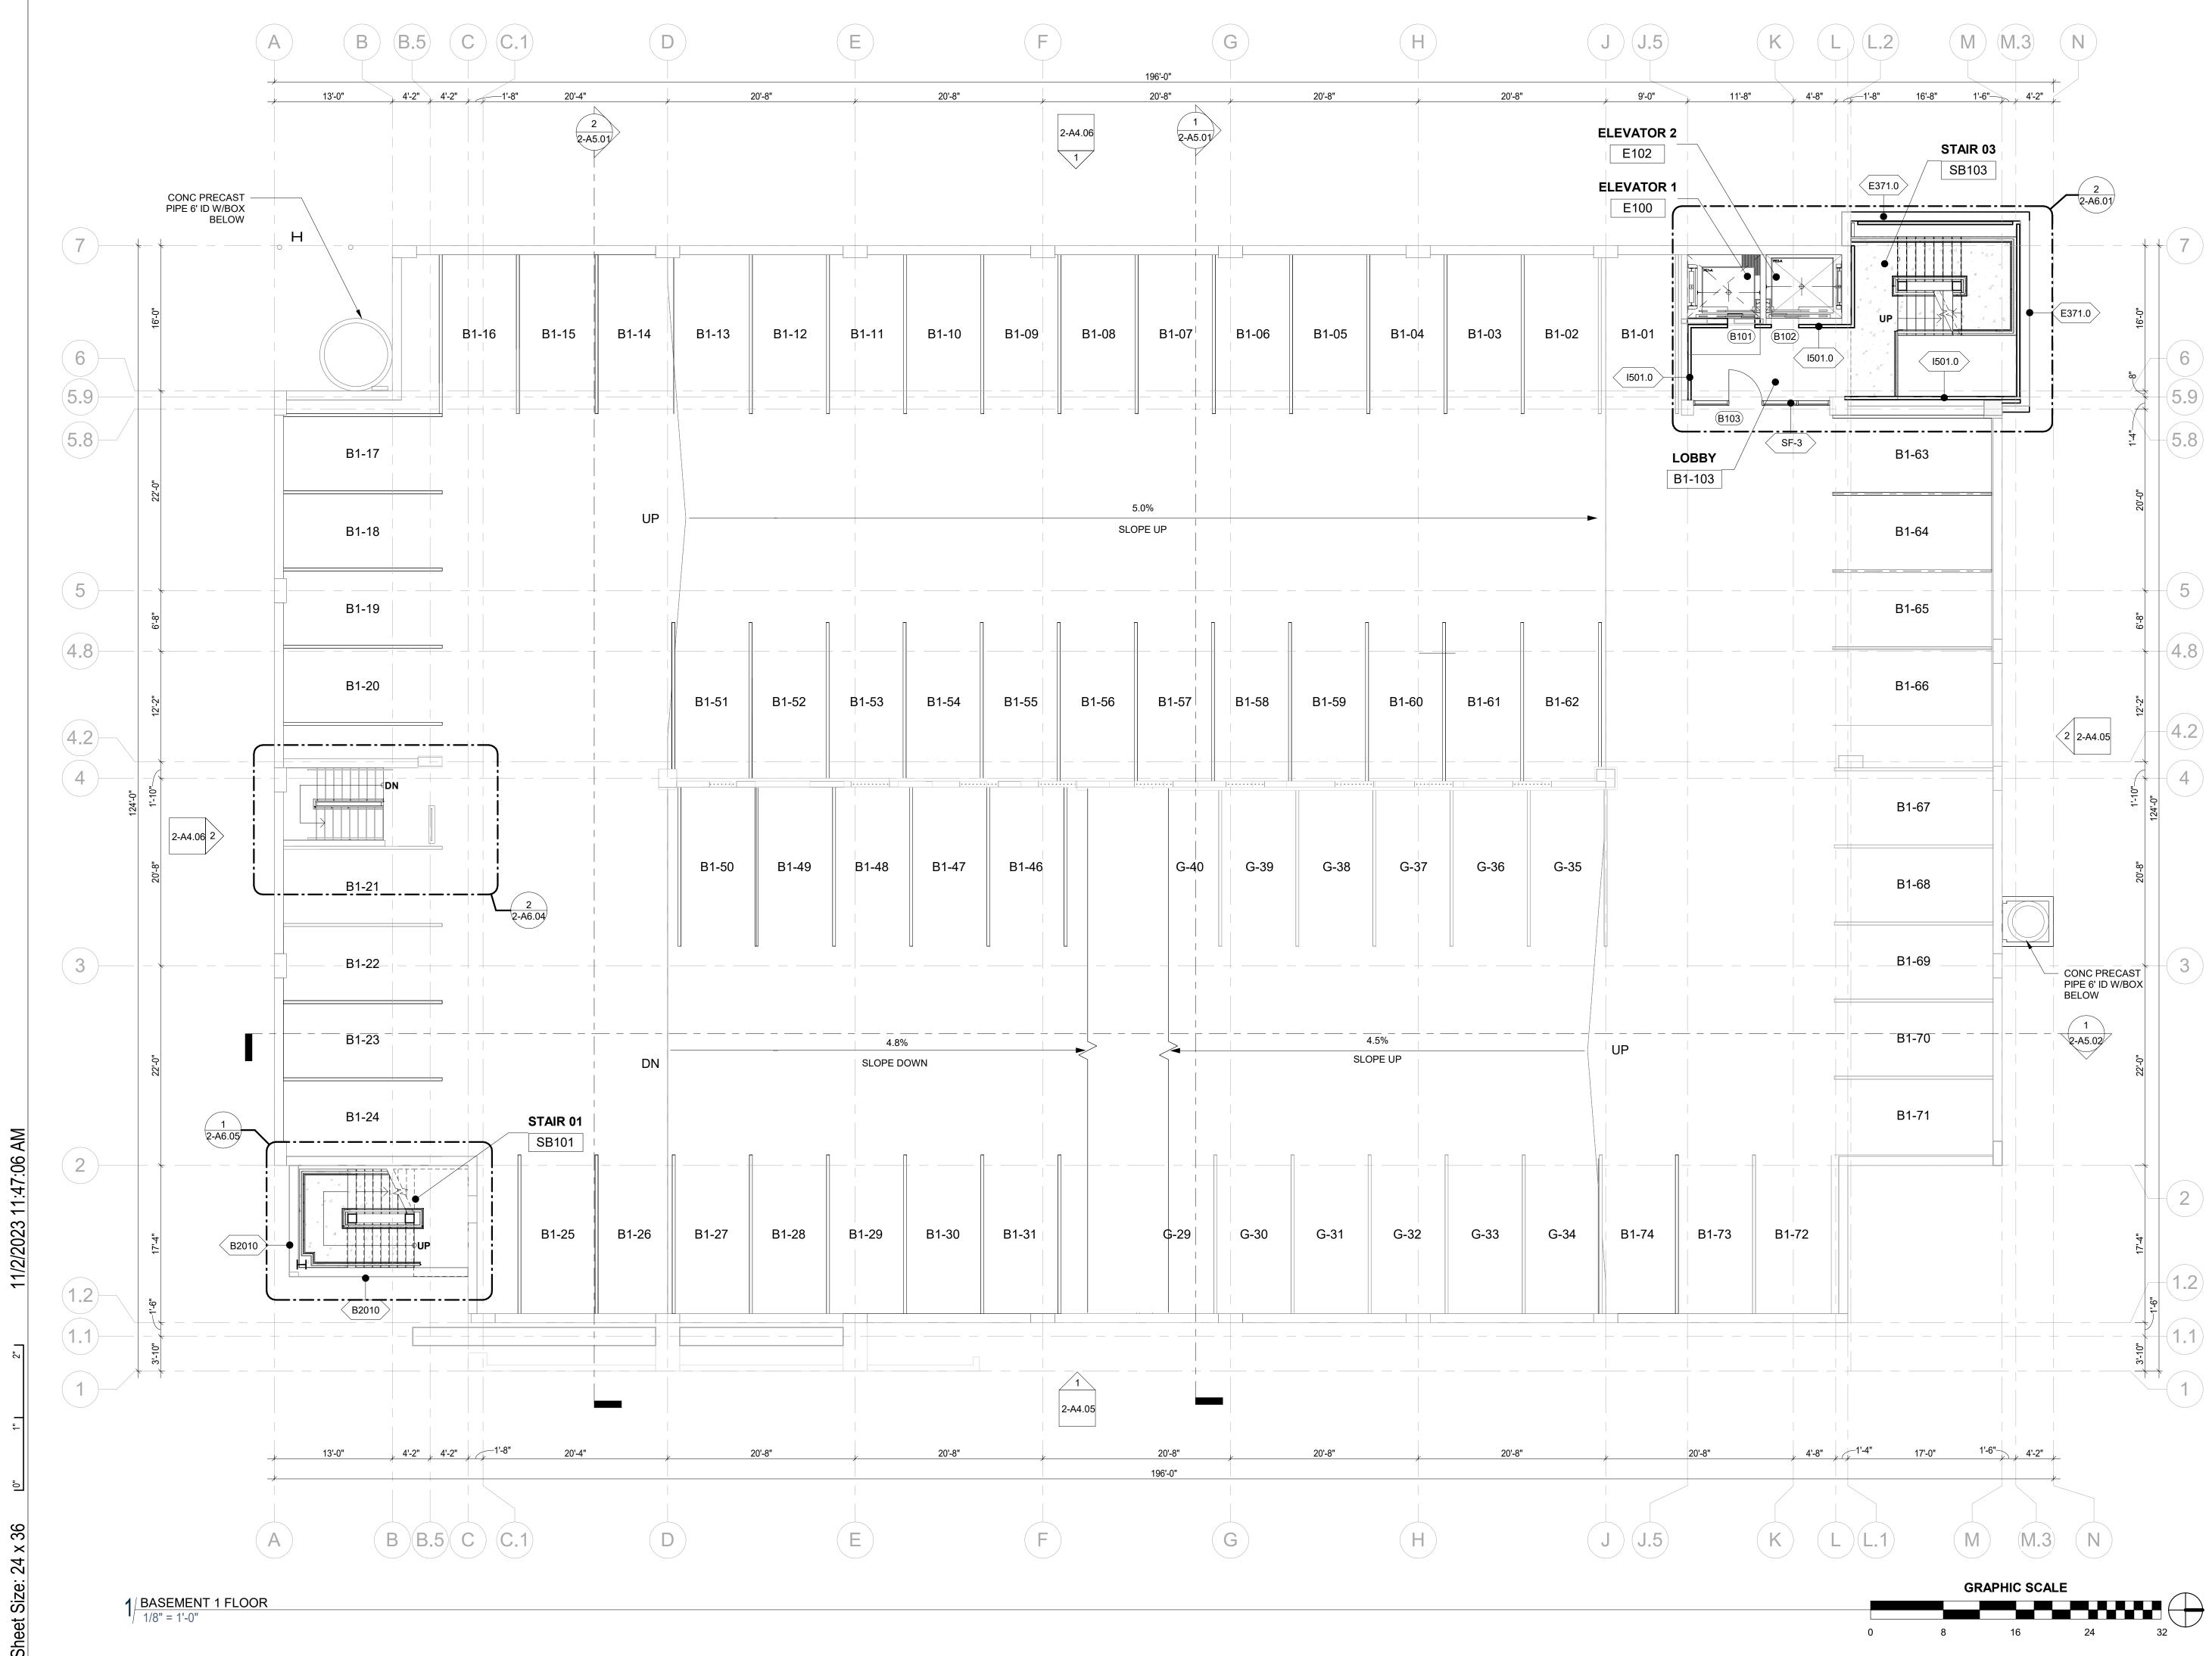
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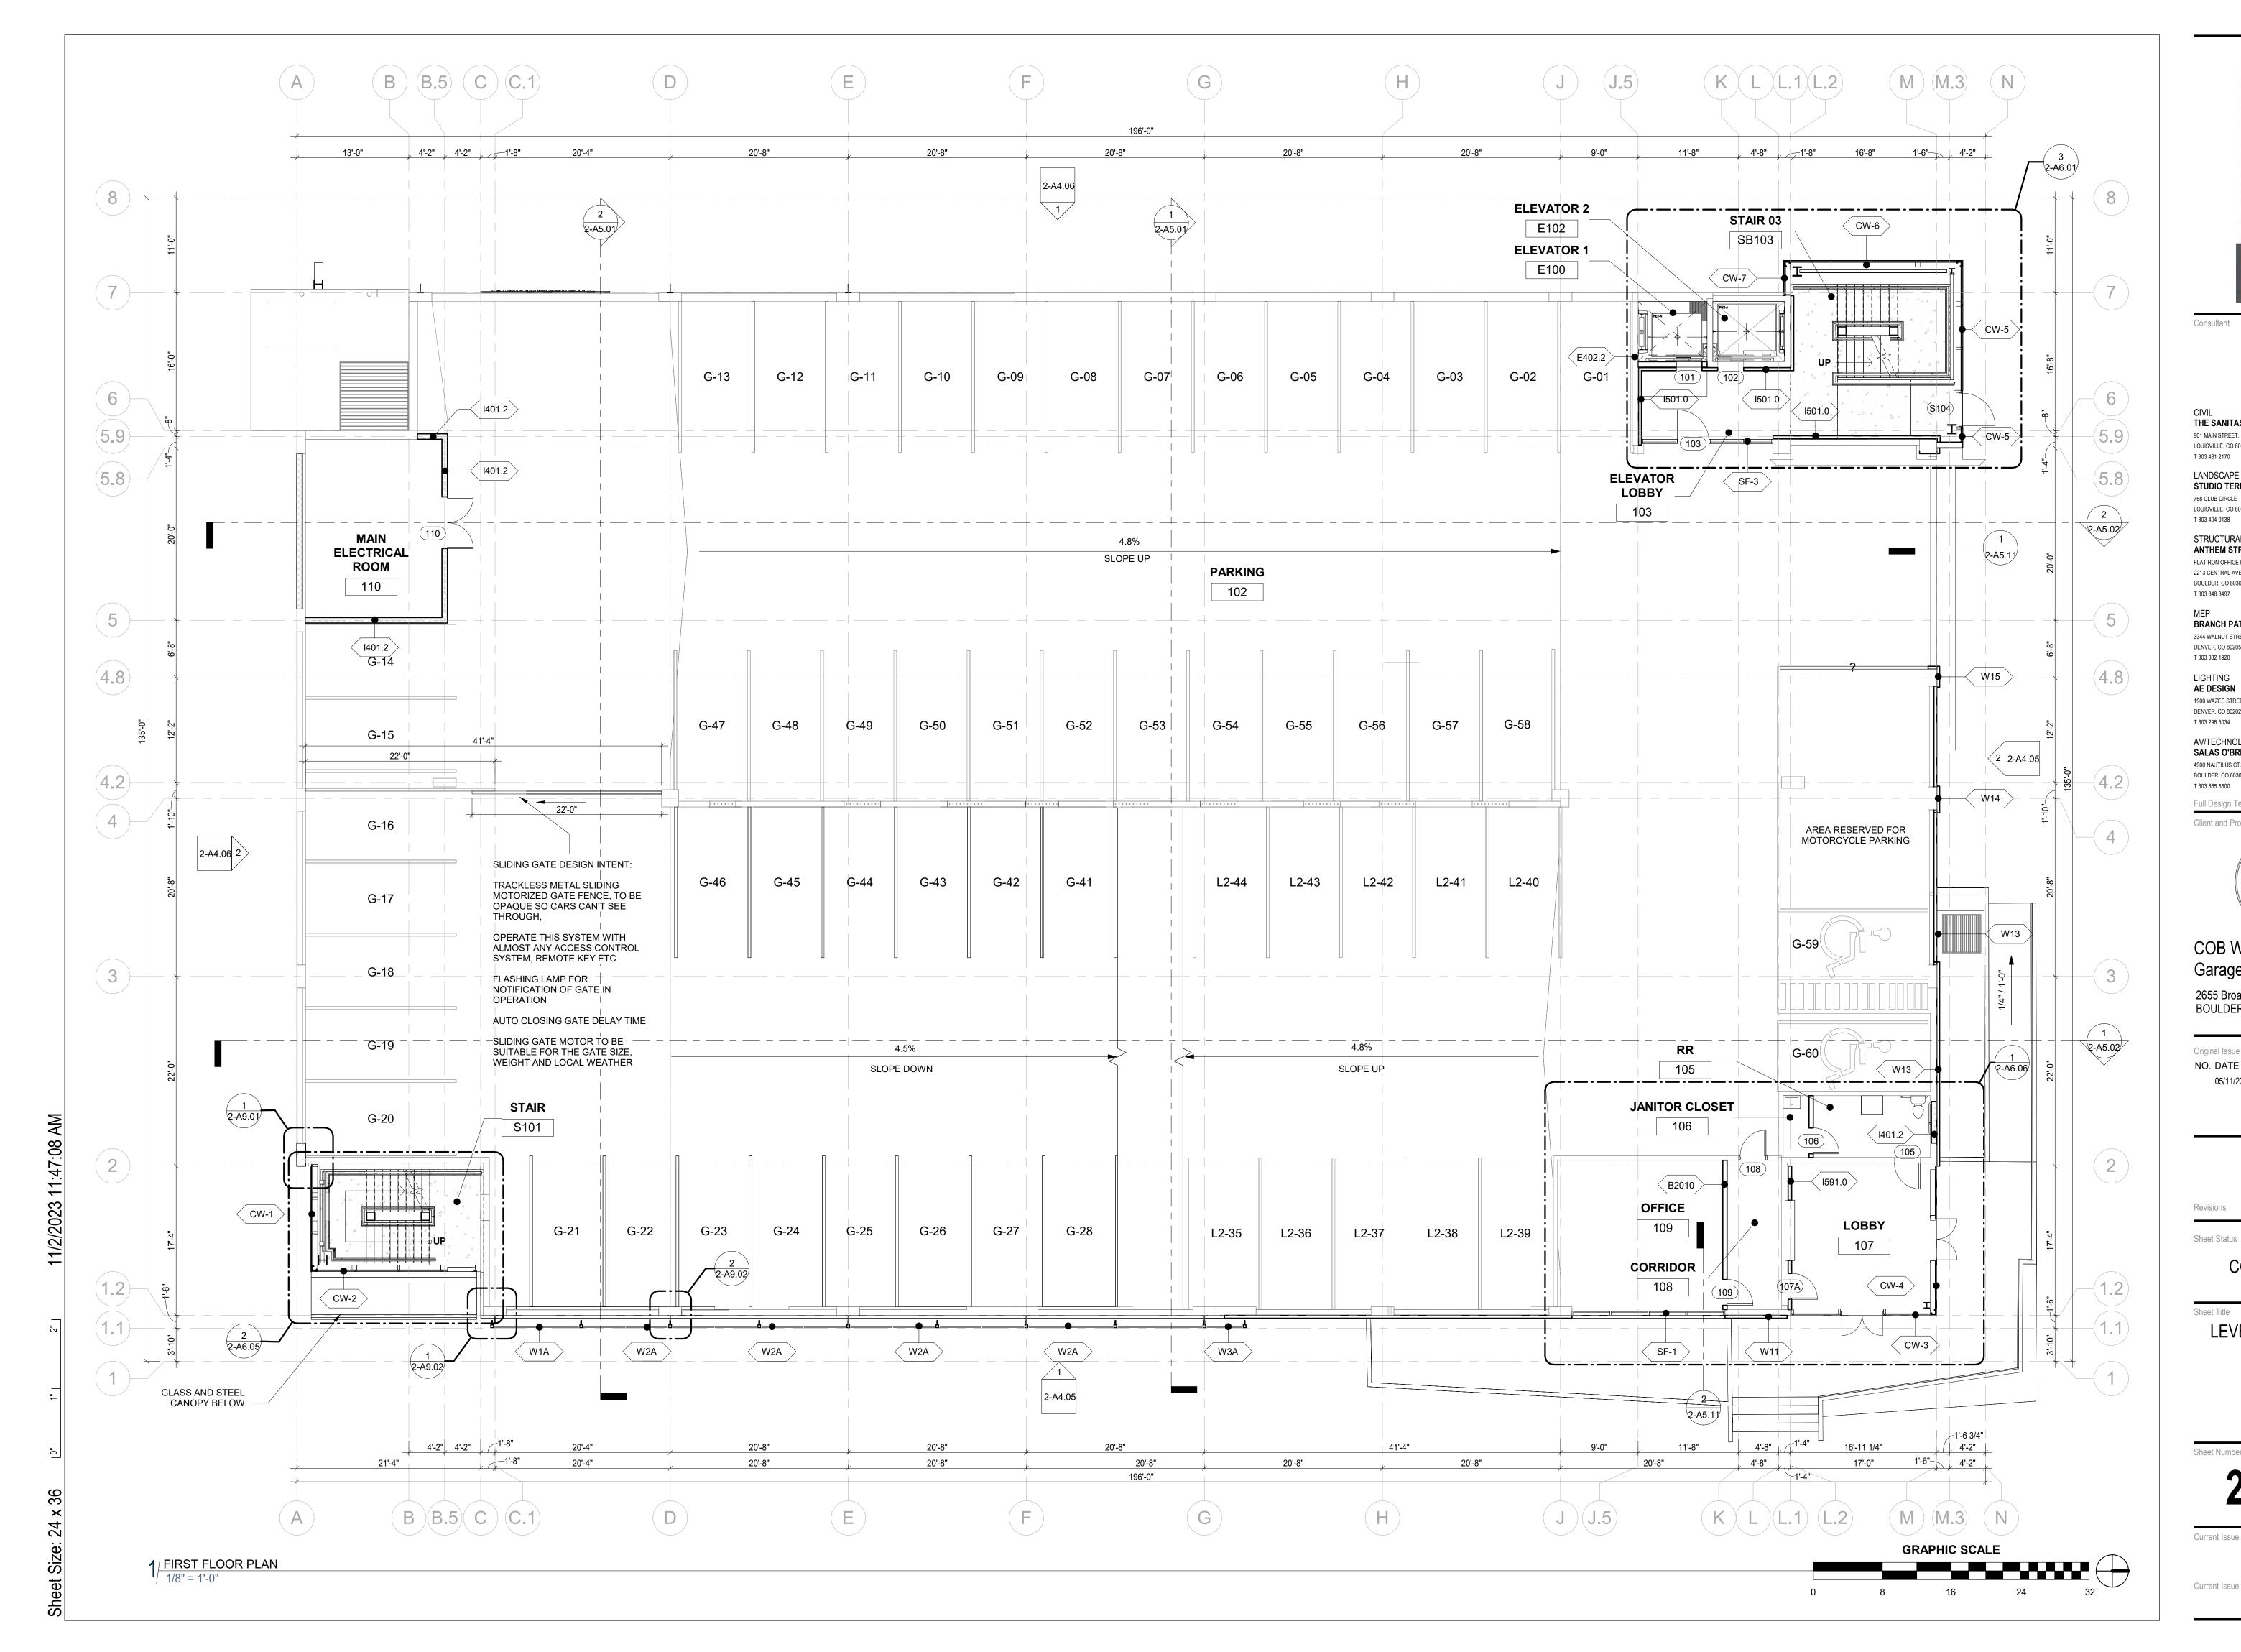
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2-A2.02 Current Issue

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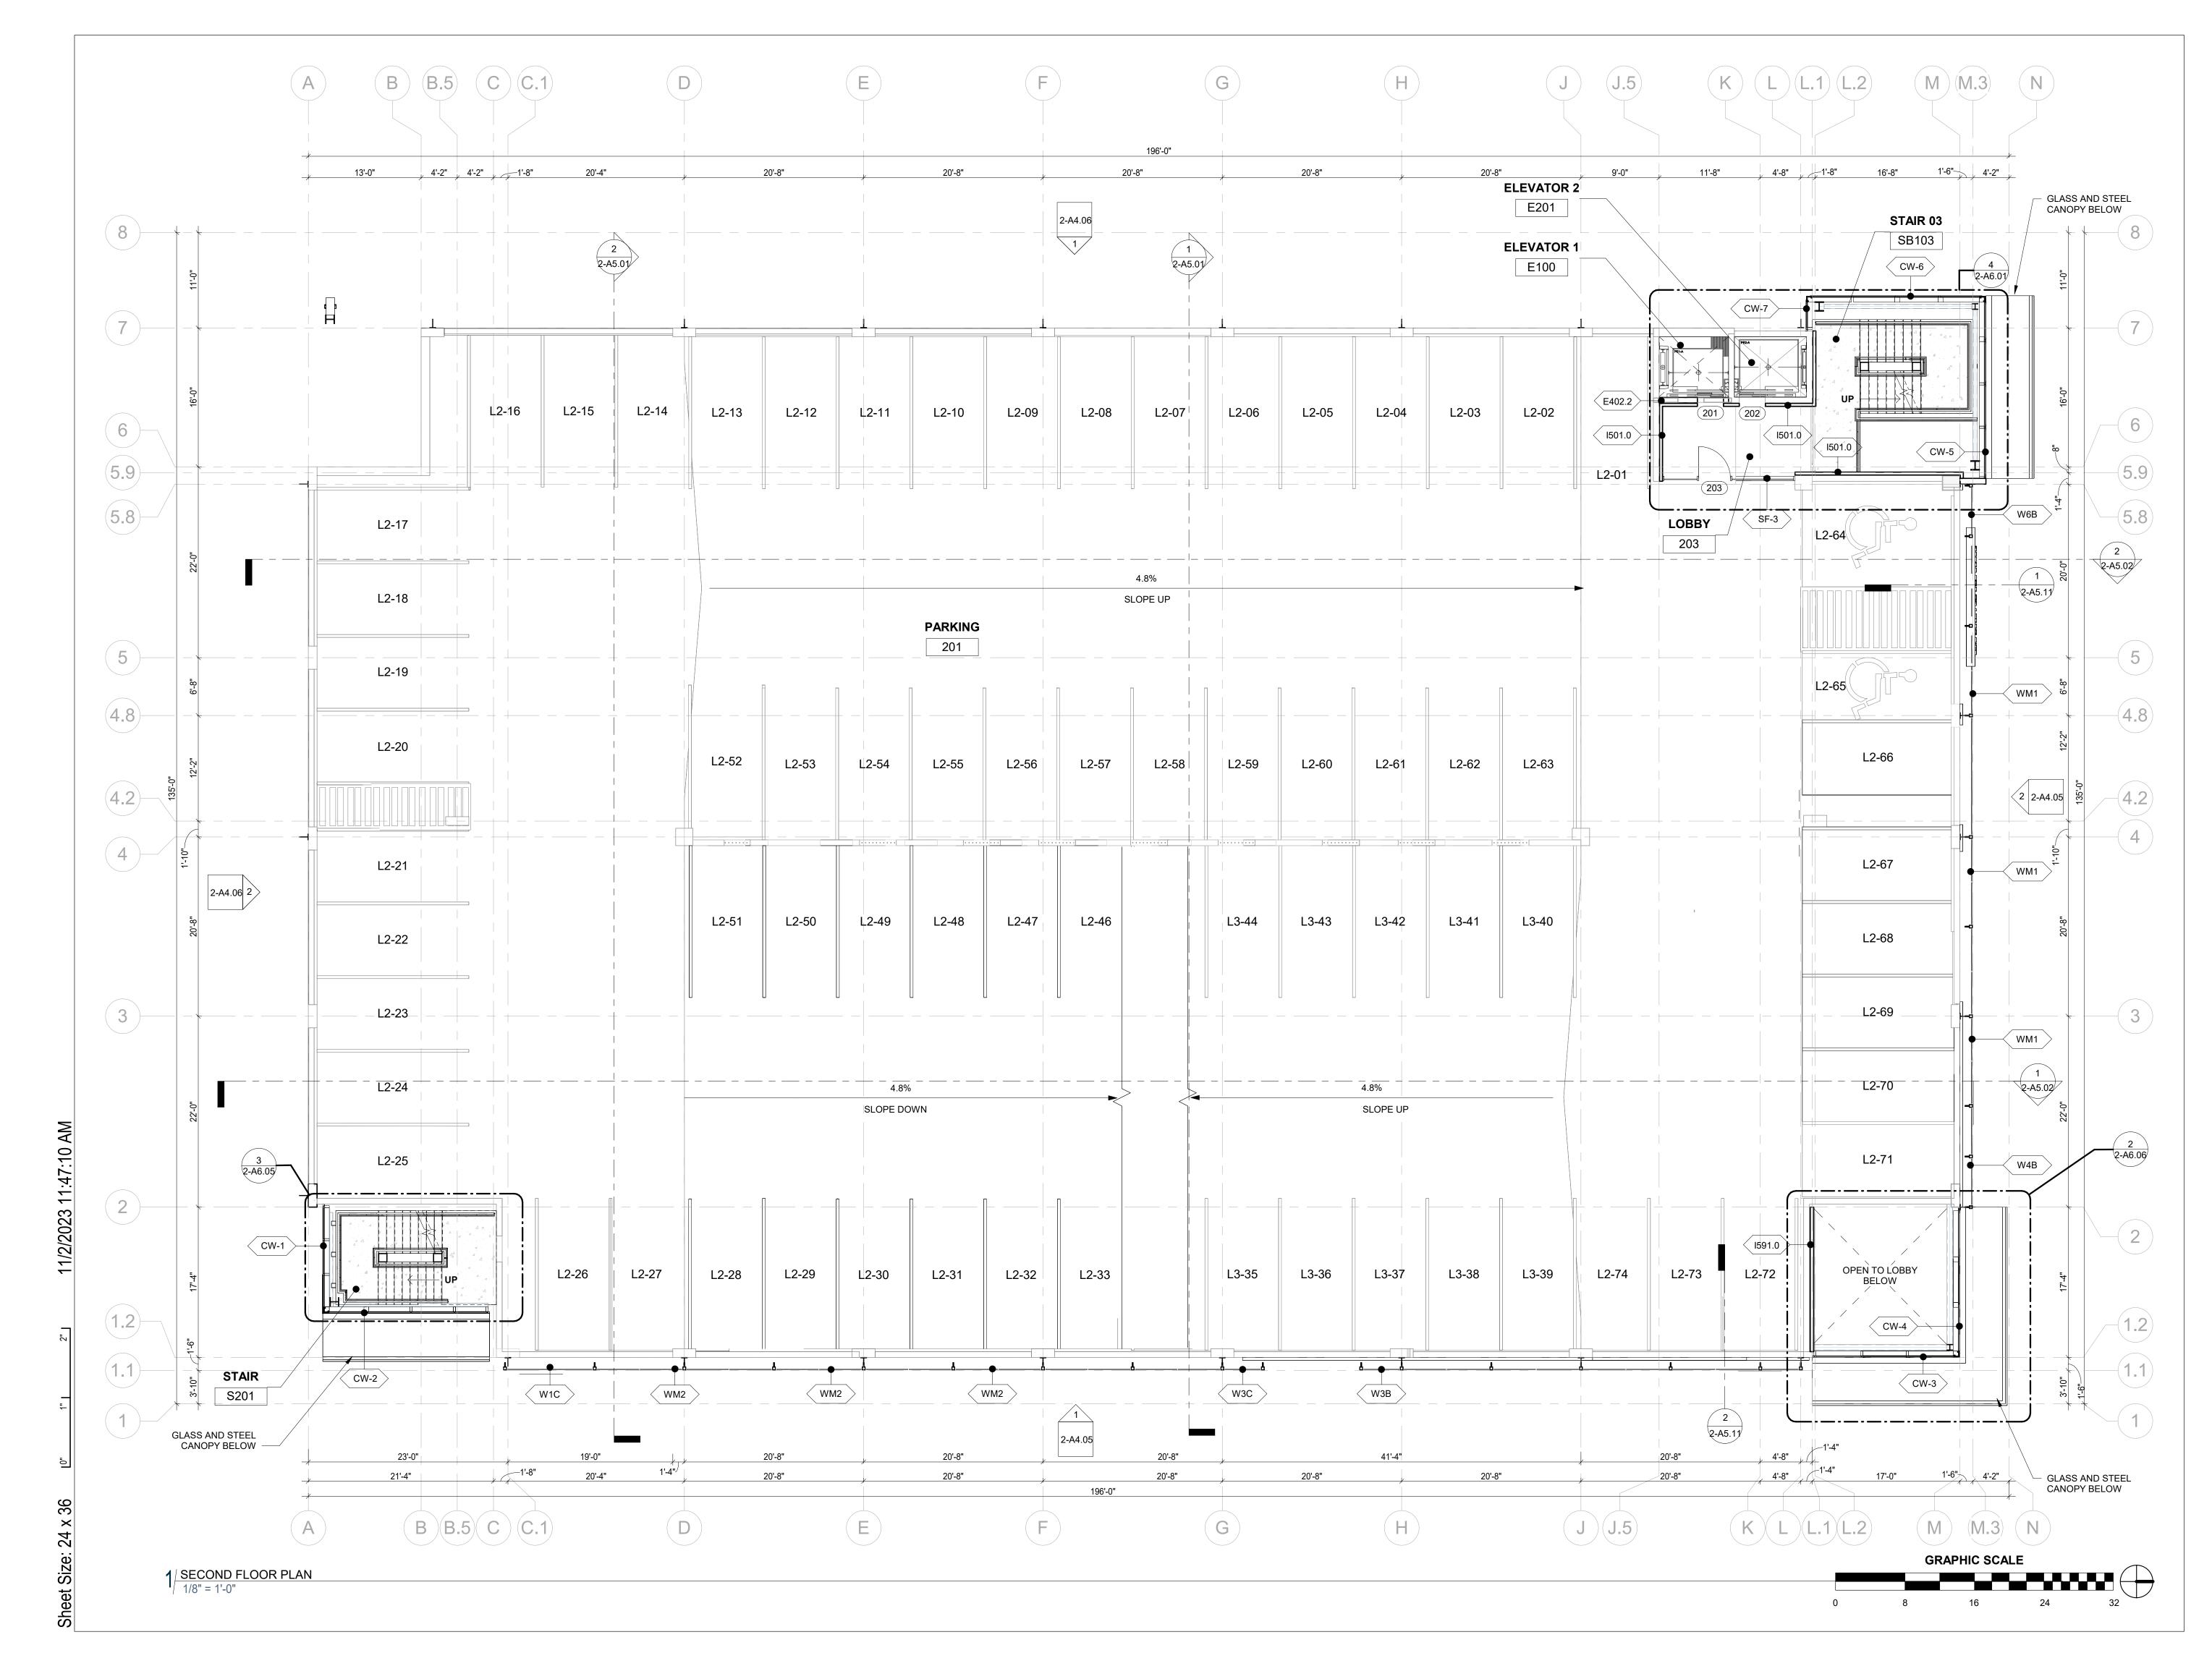
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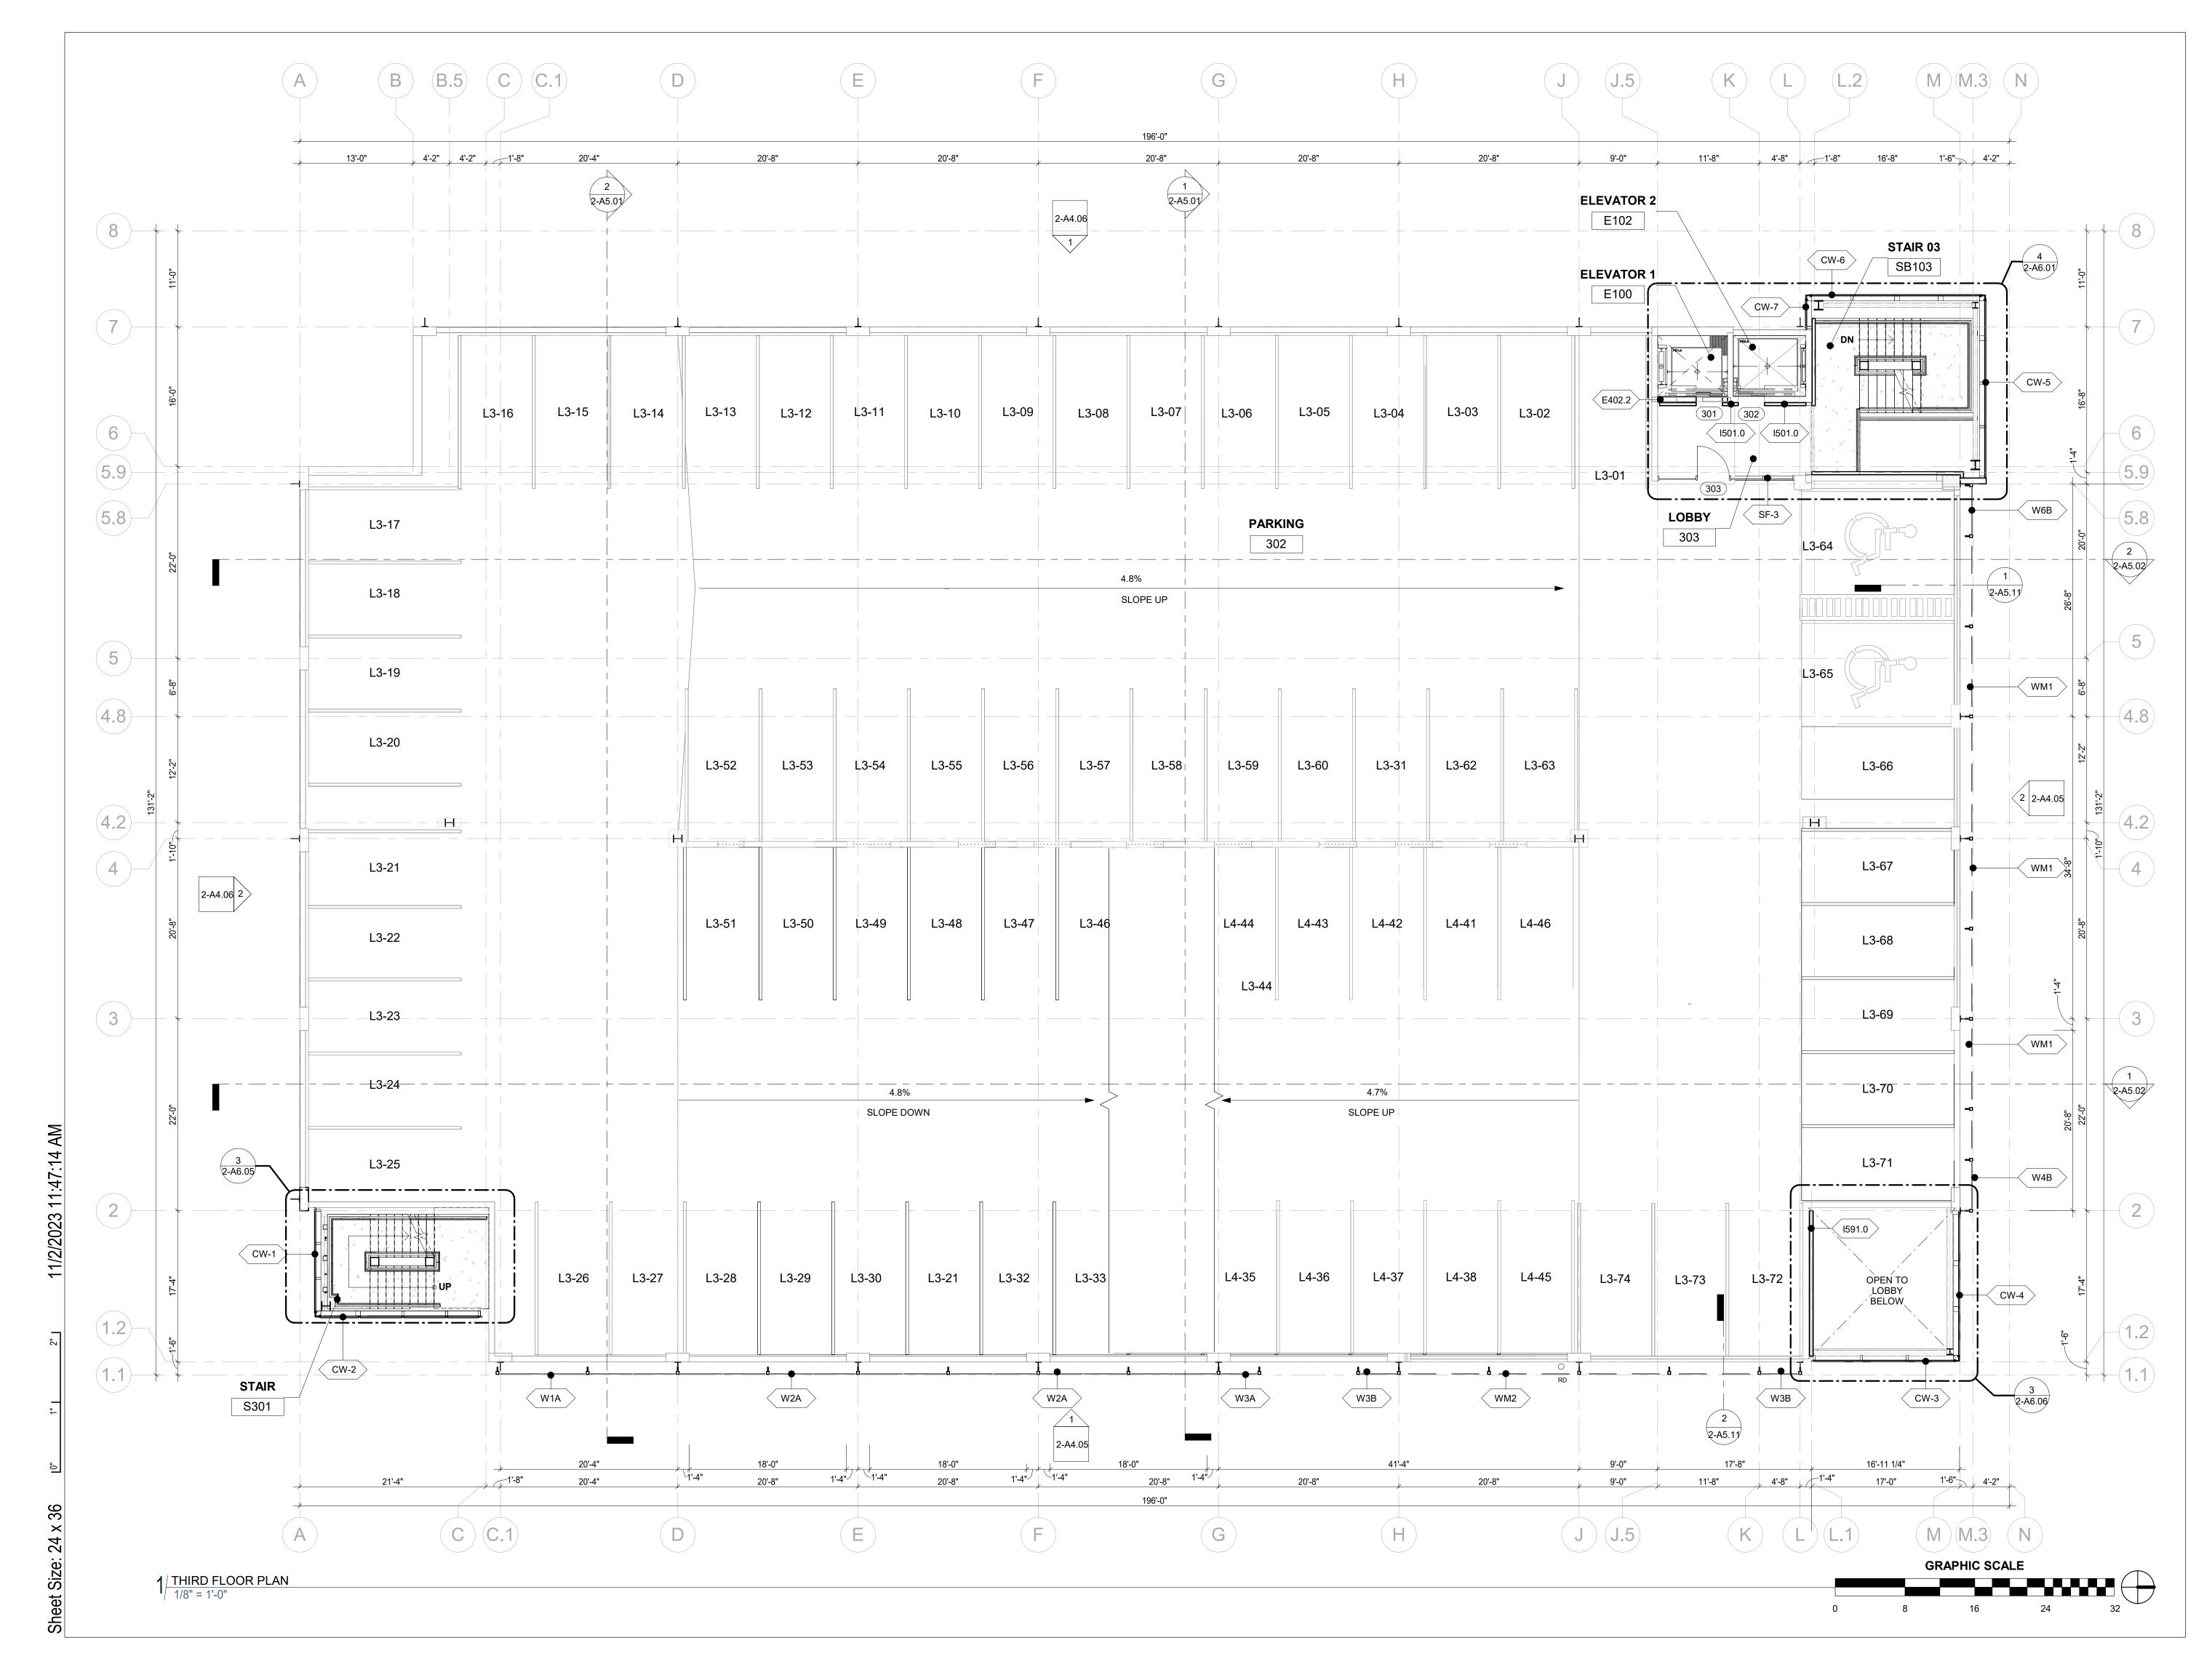
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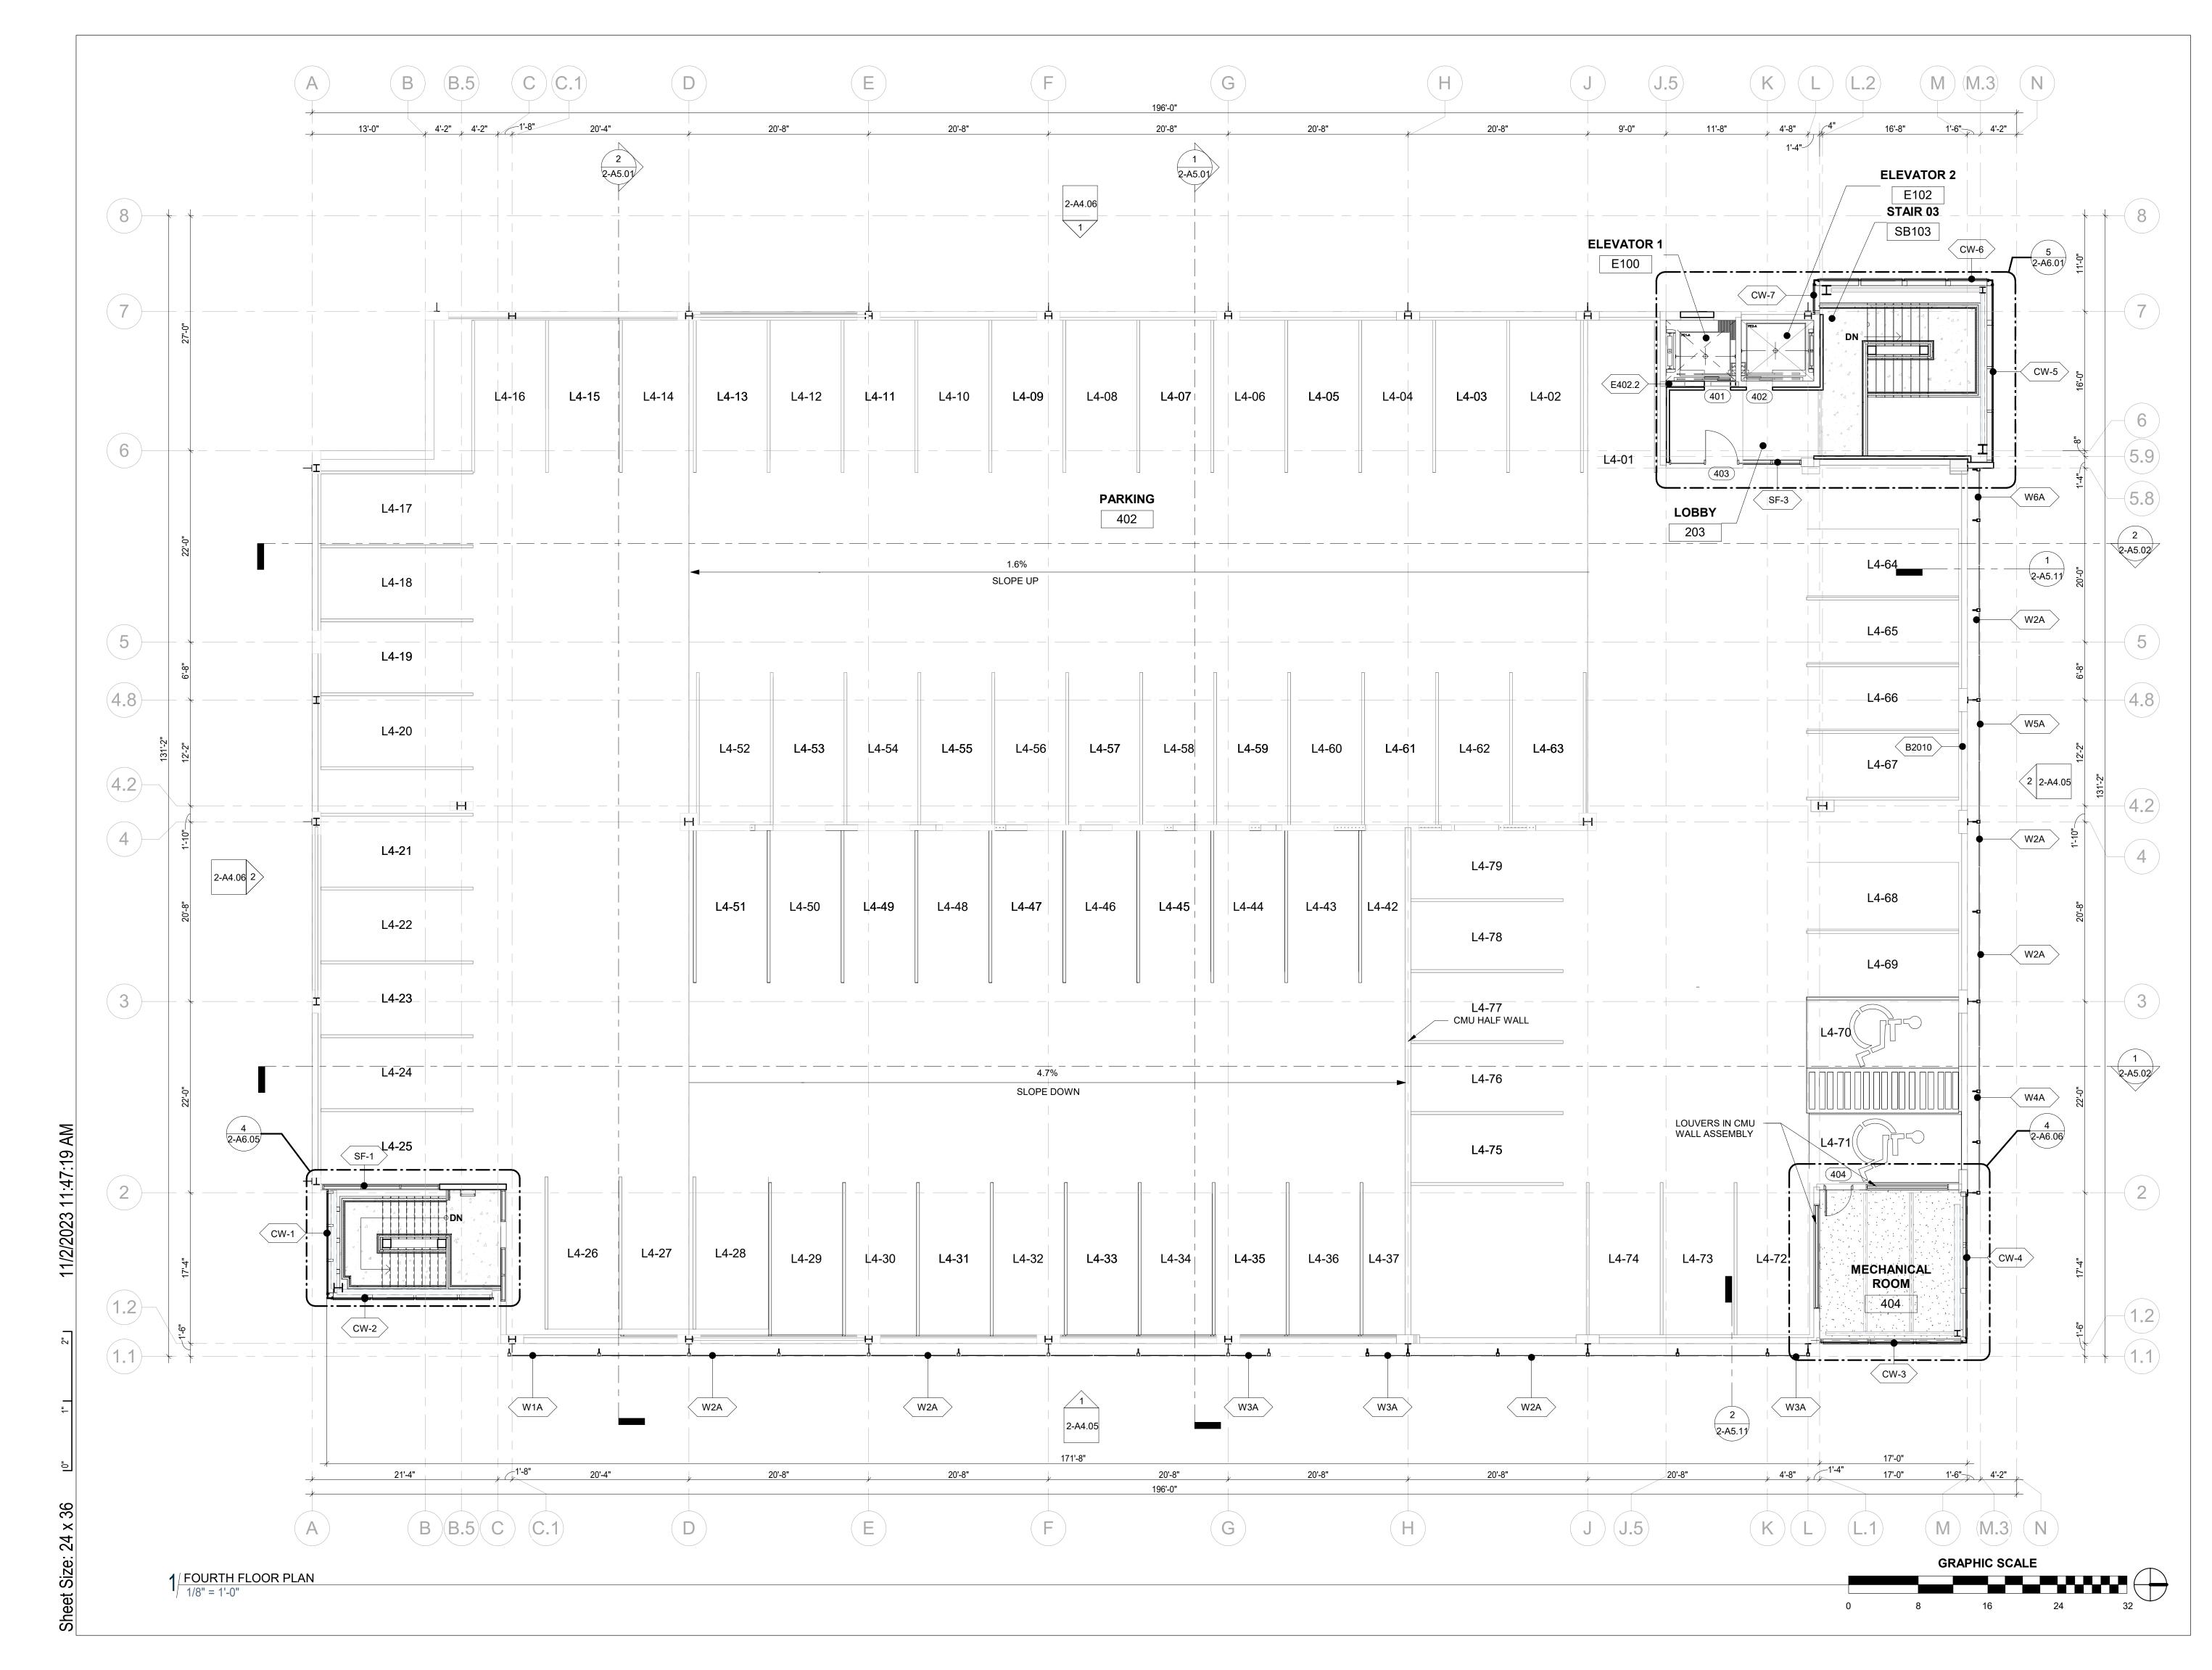
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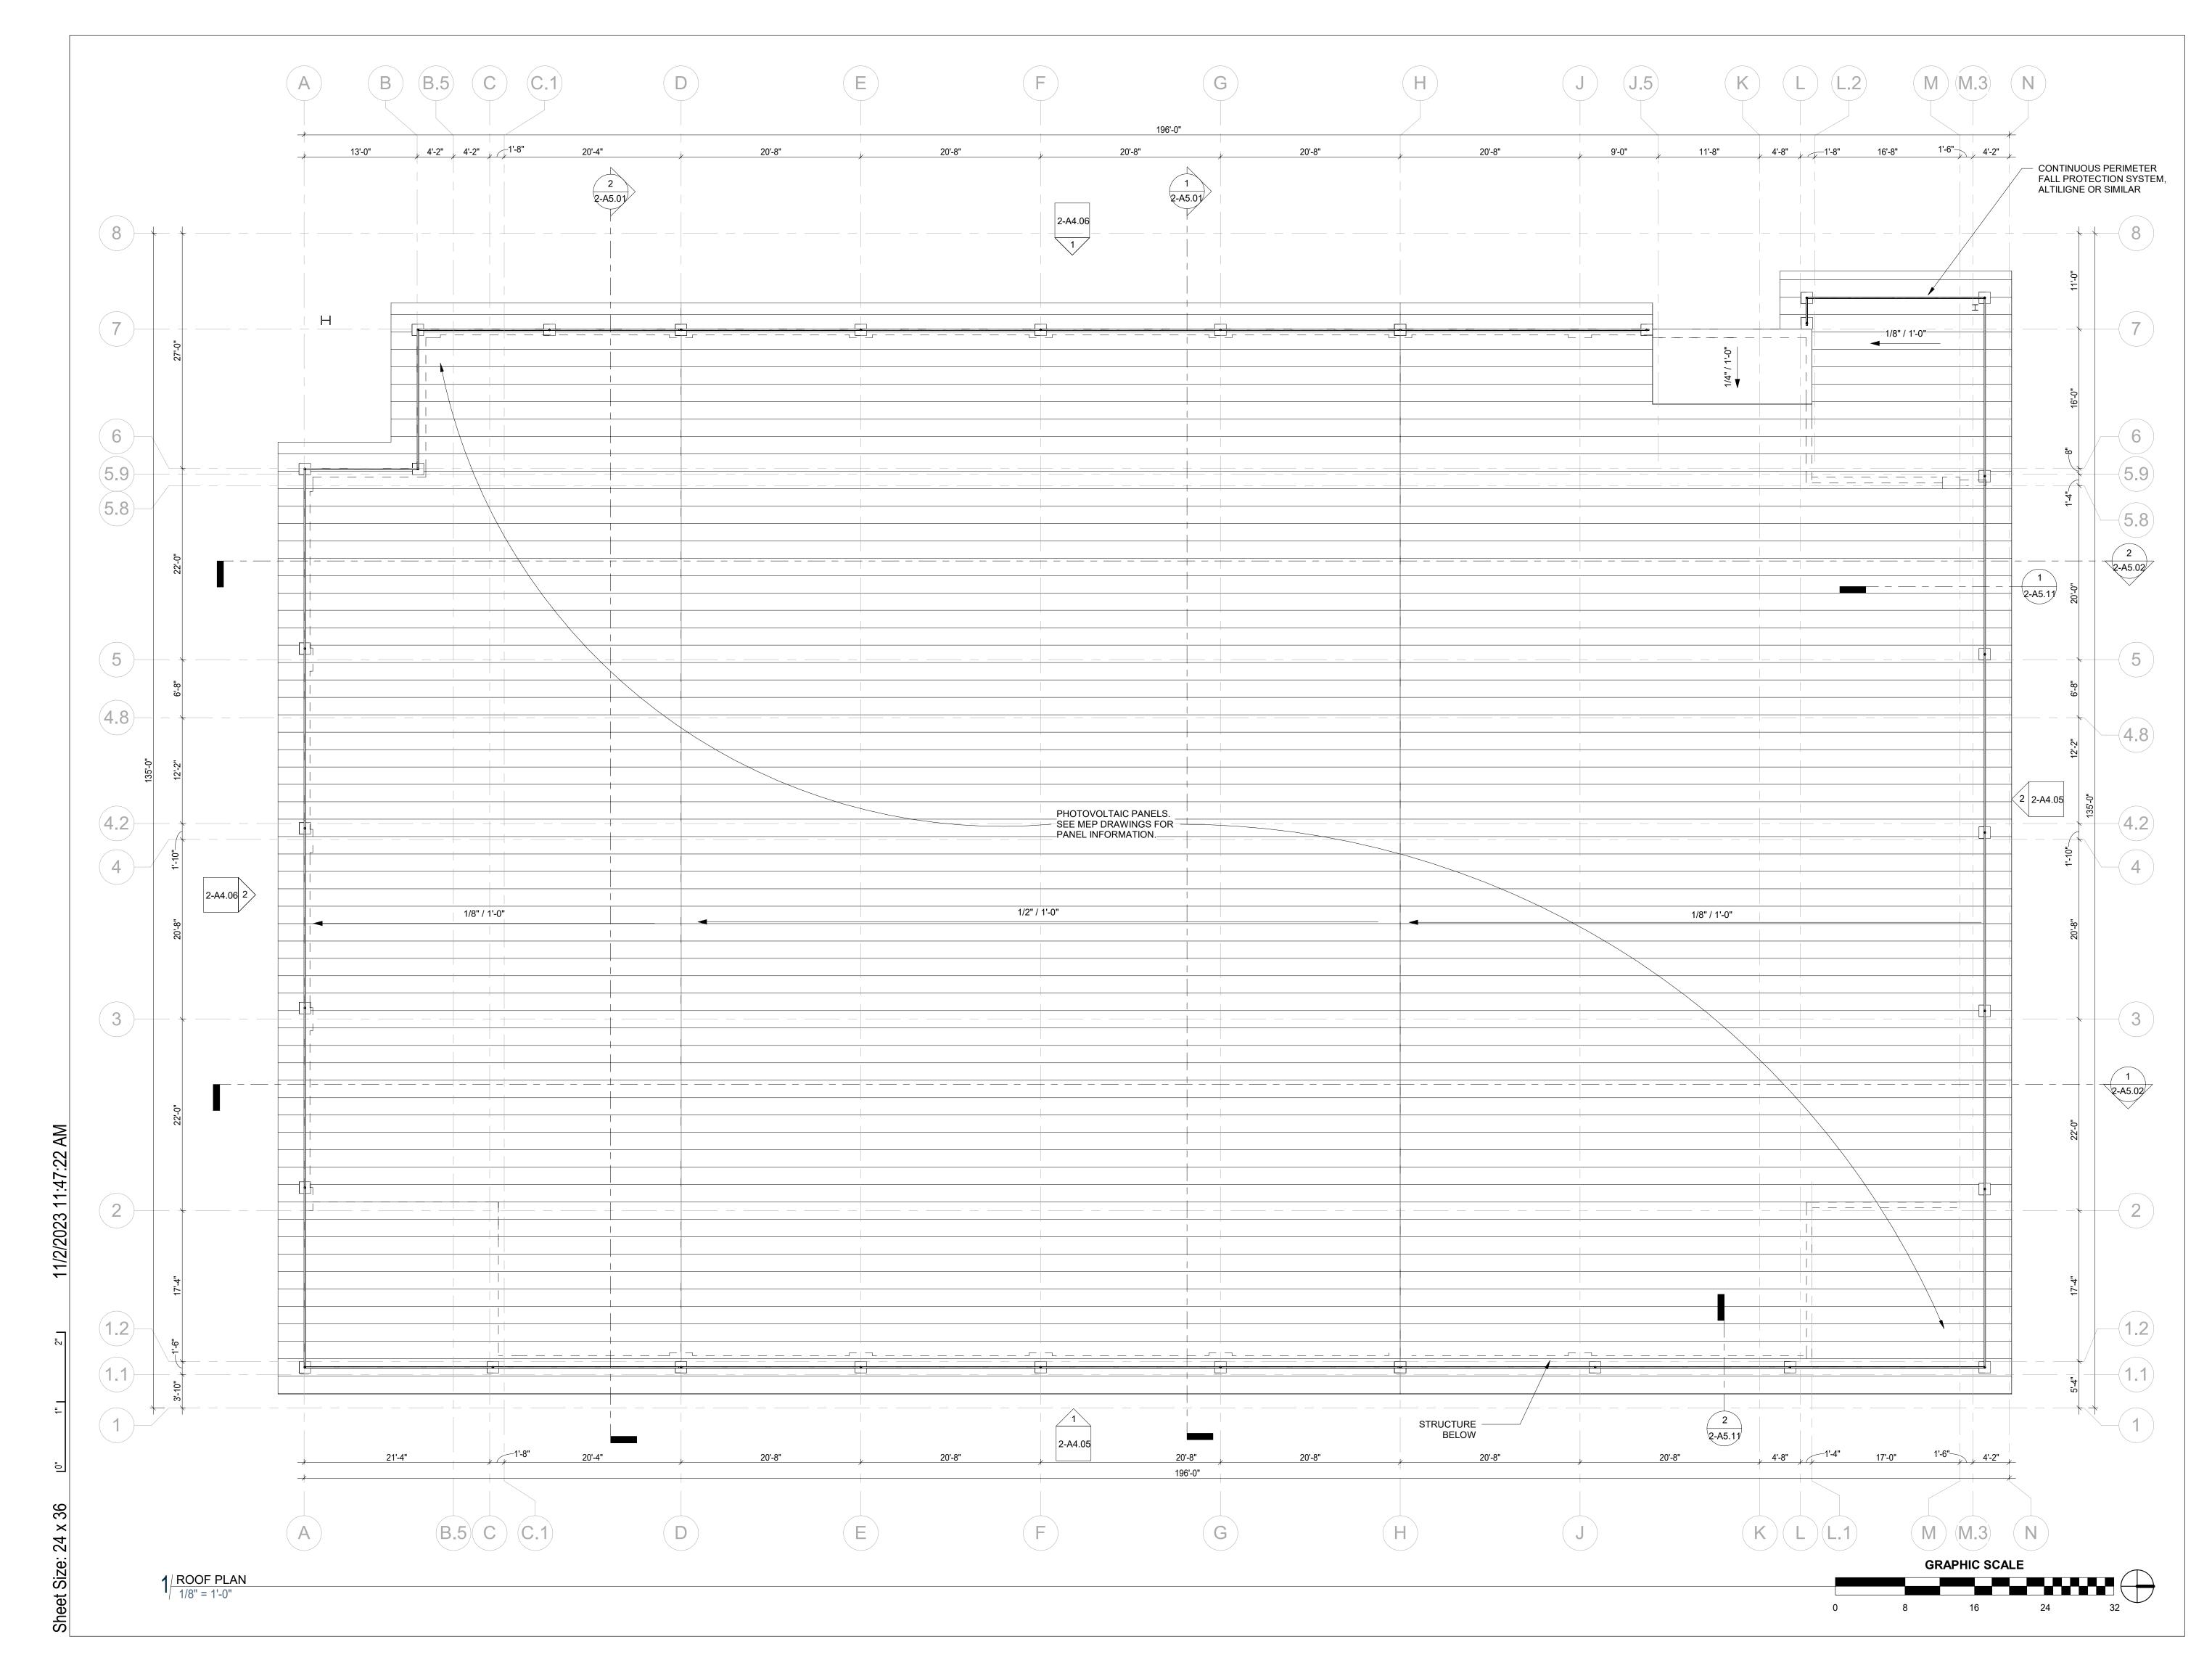
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T 303 848 8497 MEP

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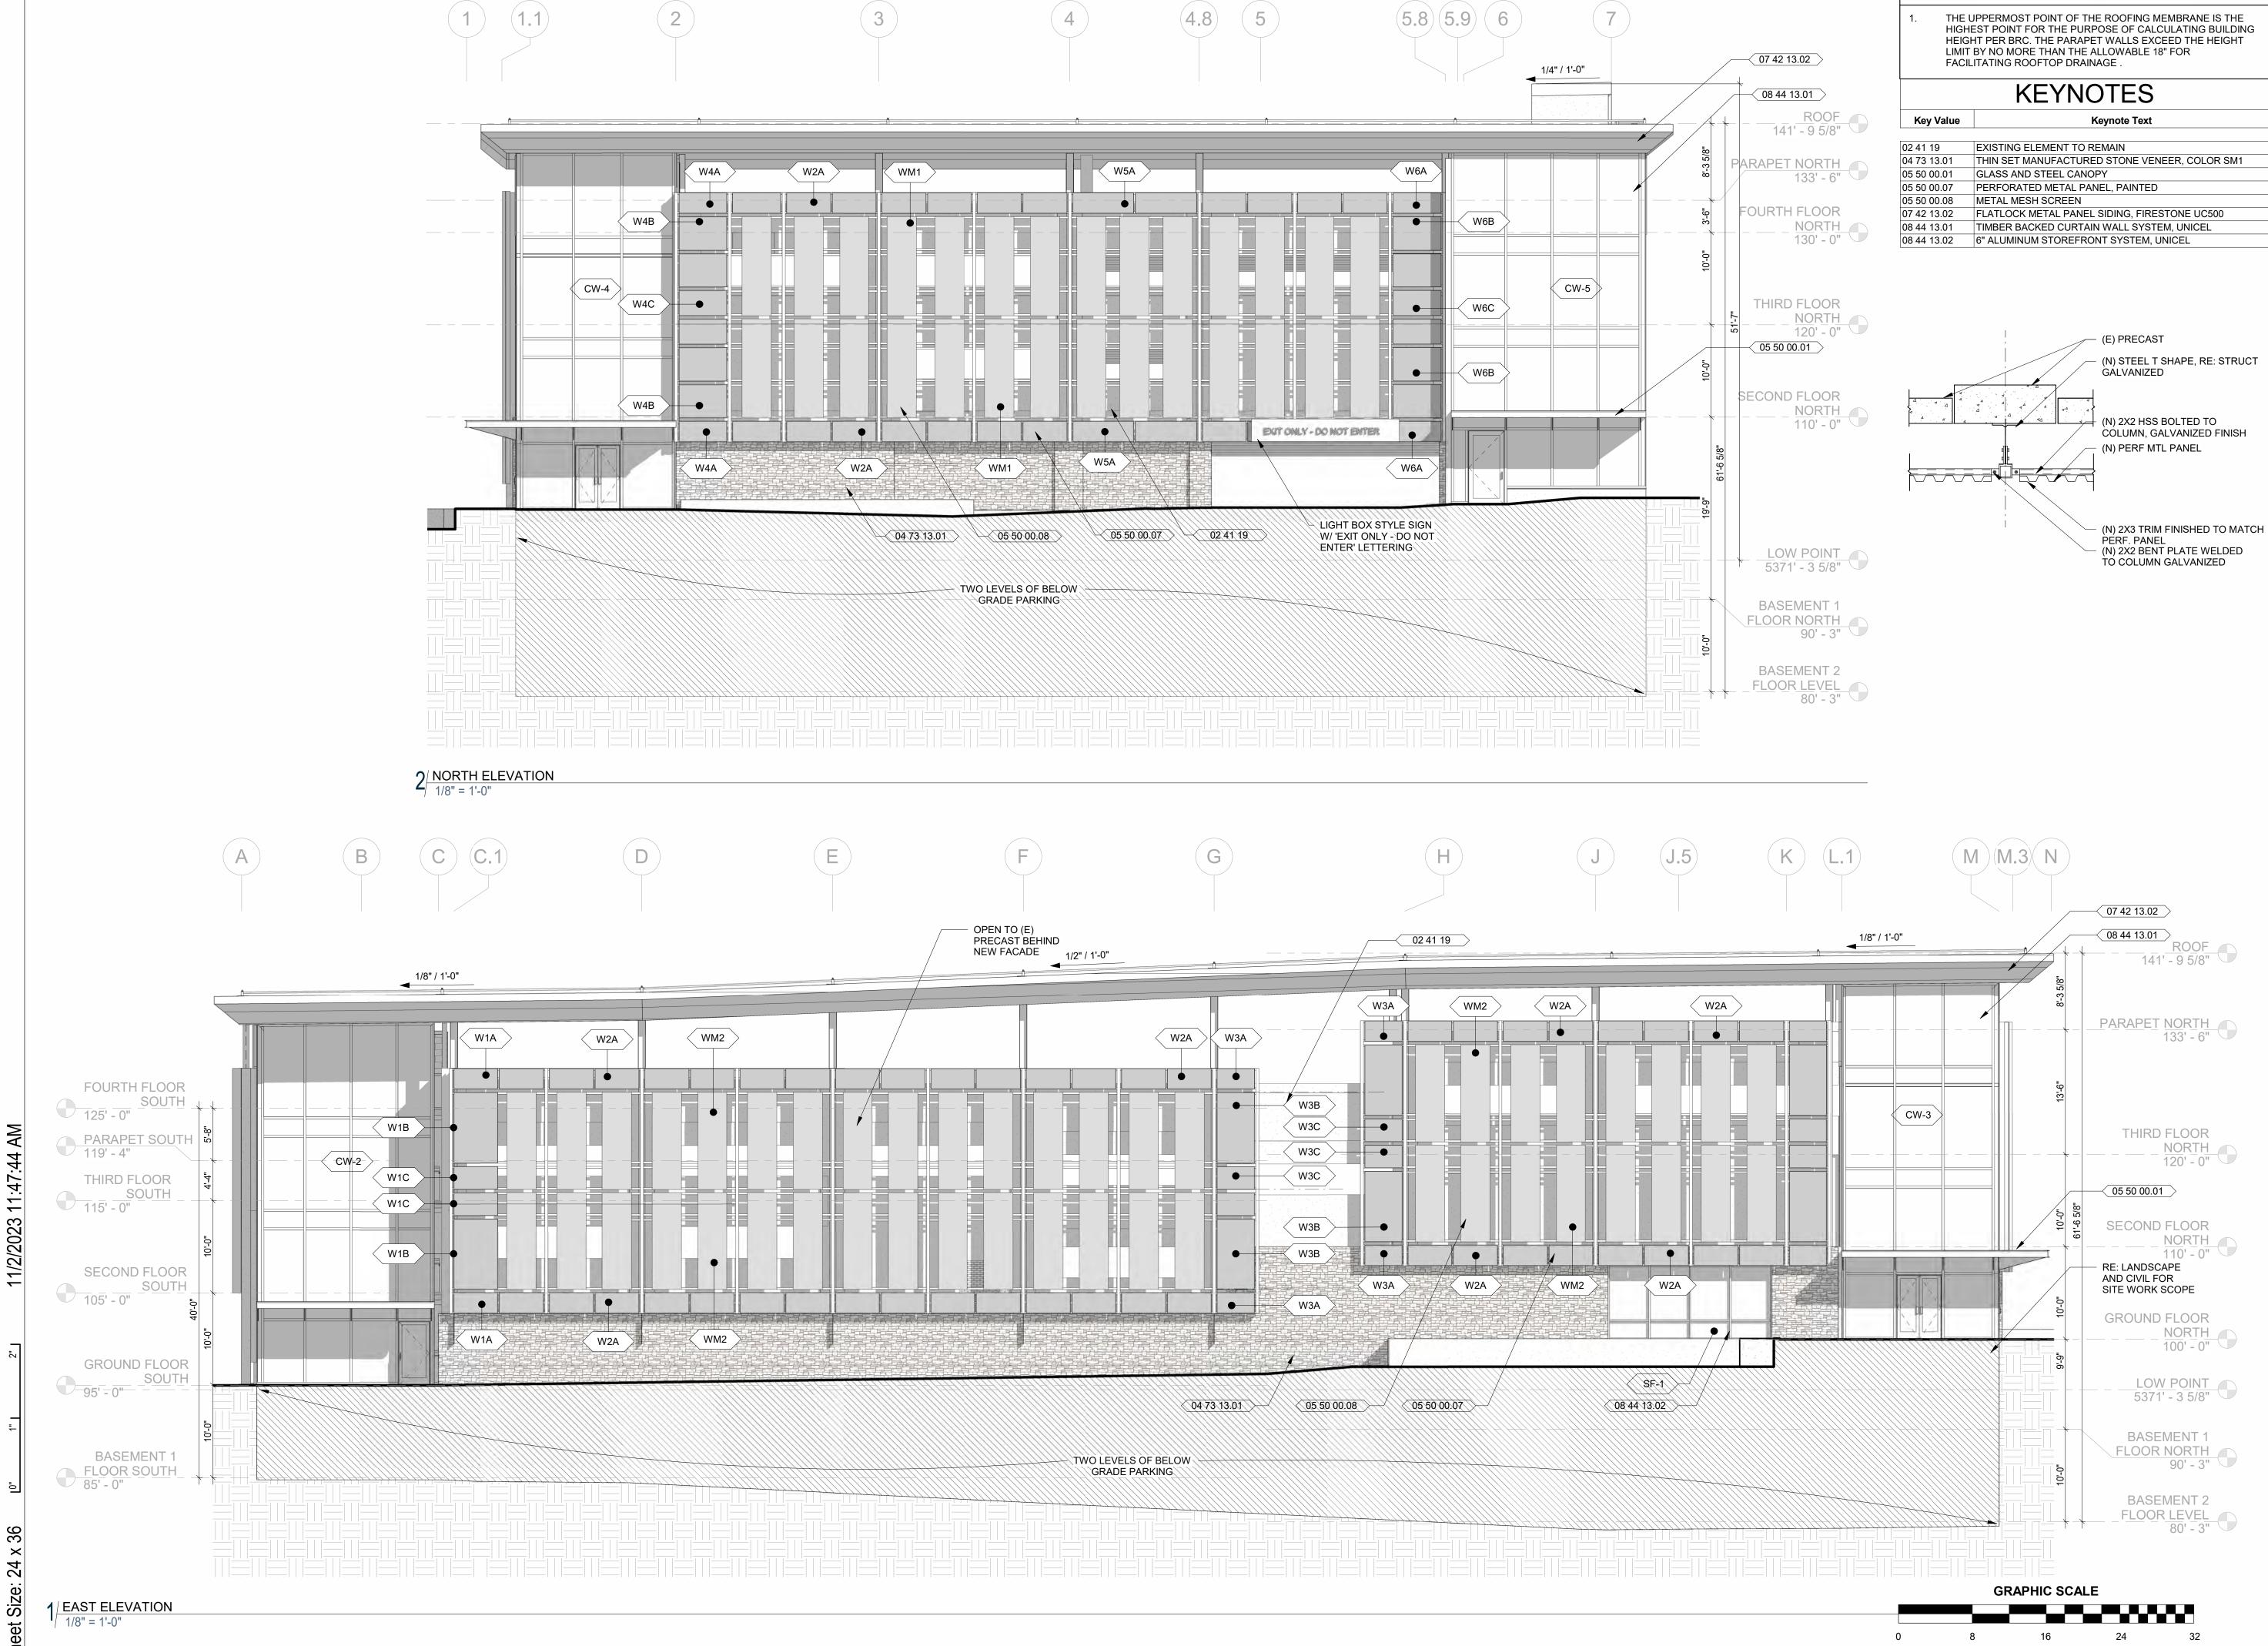
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ROOF PLAN

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**GENERAL NOTES** 

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133' - 6"

NORTH 120' - 0"

- <u>NORTH</u> 110' - 0"

NORTH

LOW POINT 5371' - 3 5/8"

32

100' - 0"

DESCRIPTION 100% SD

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> BUILDING ELEVATIONS

2-A4.01

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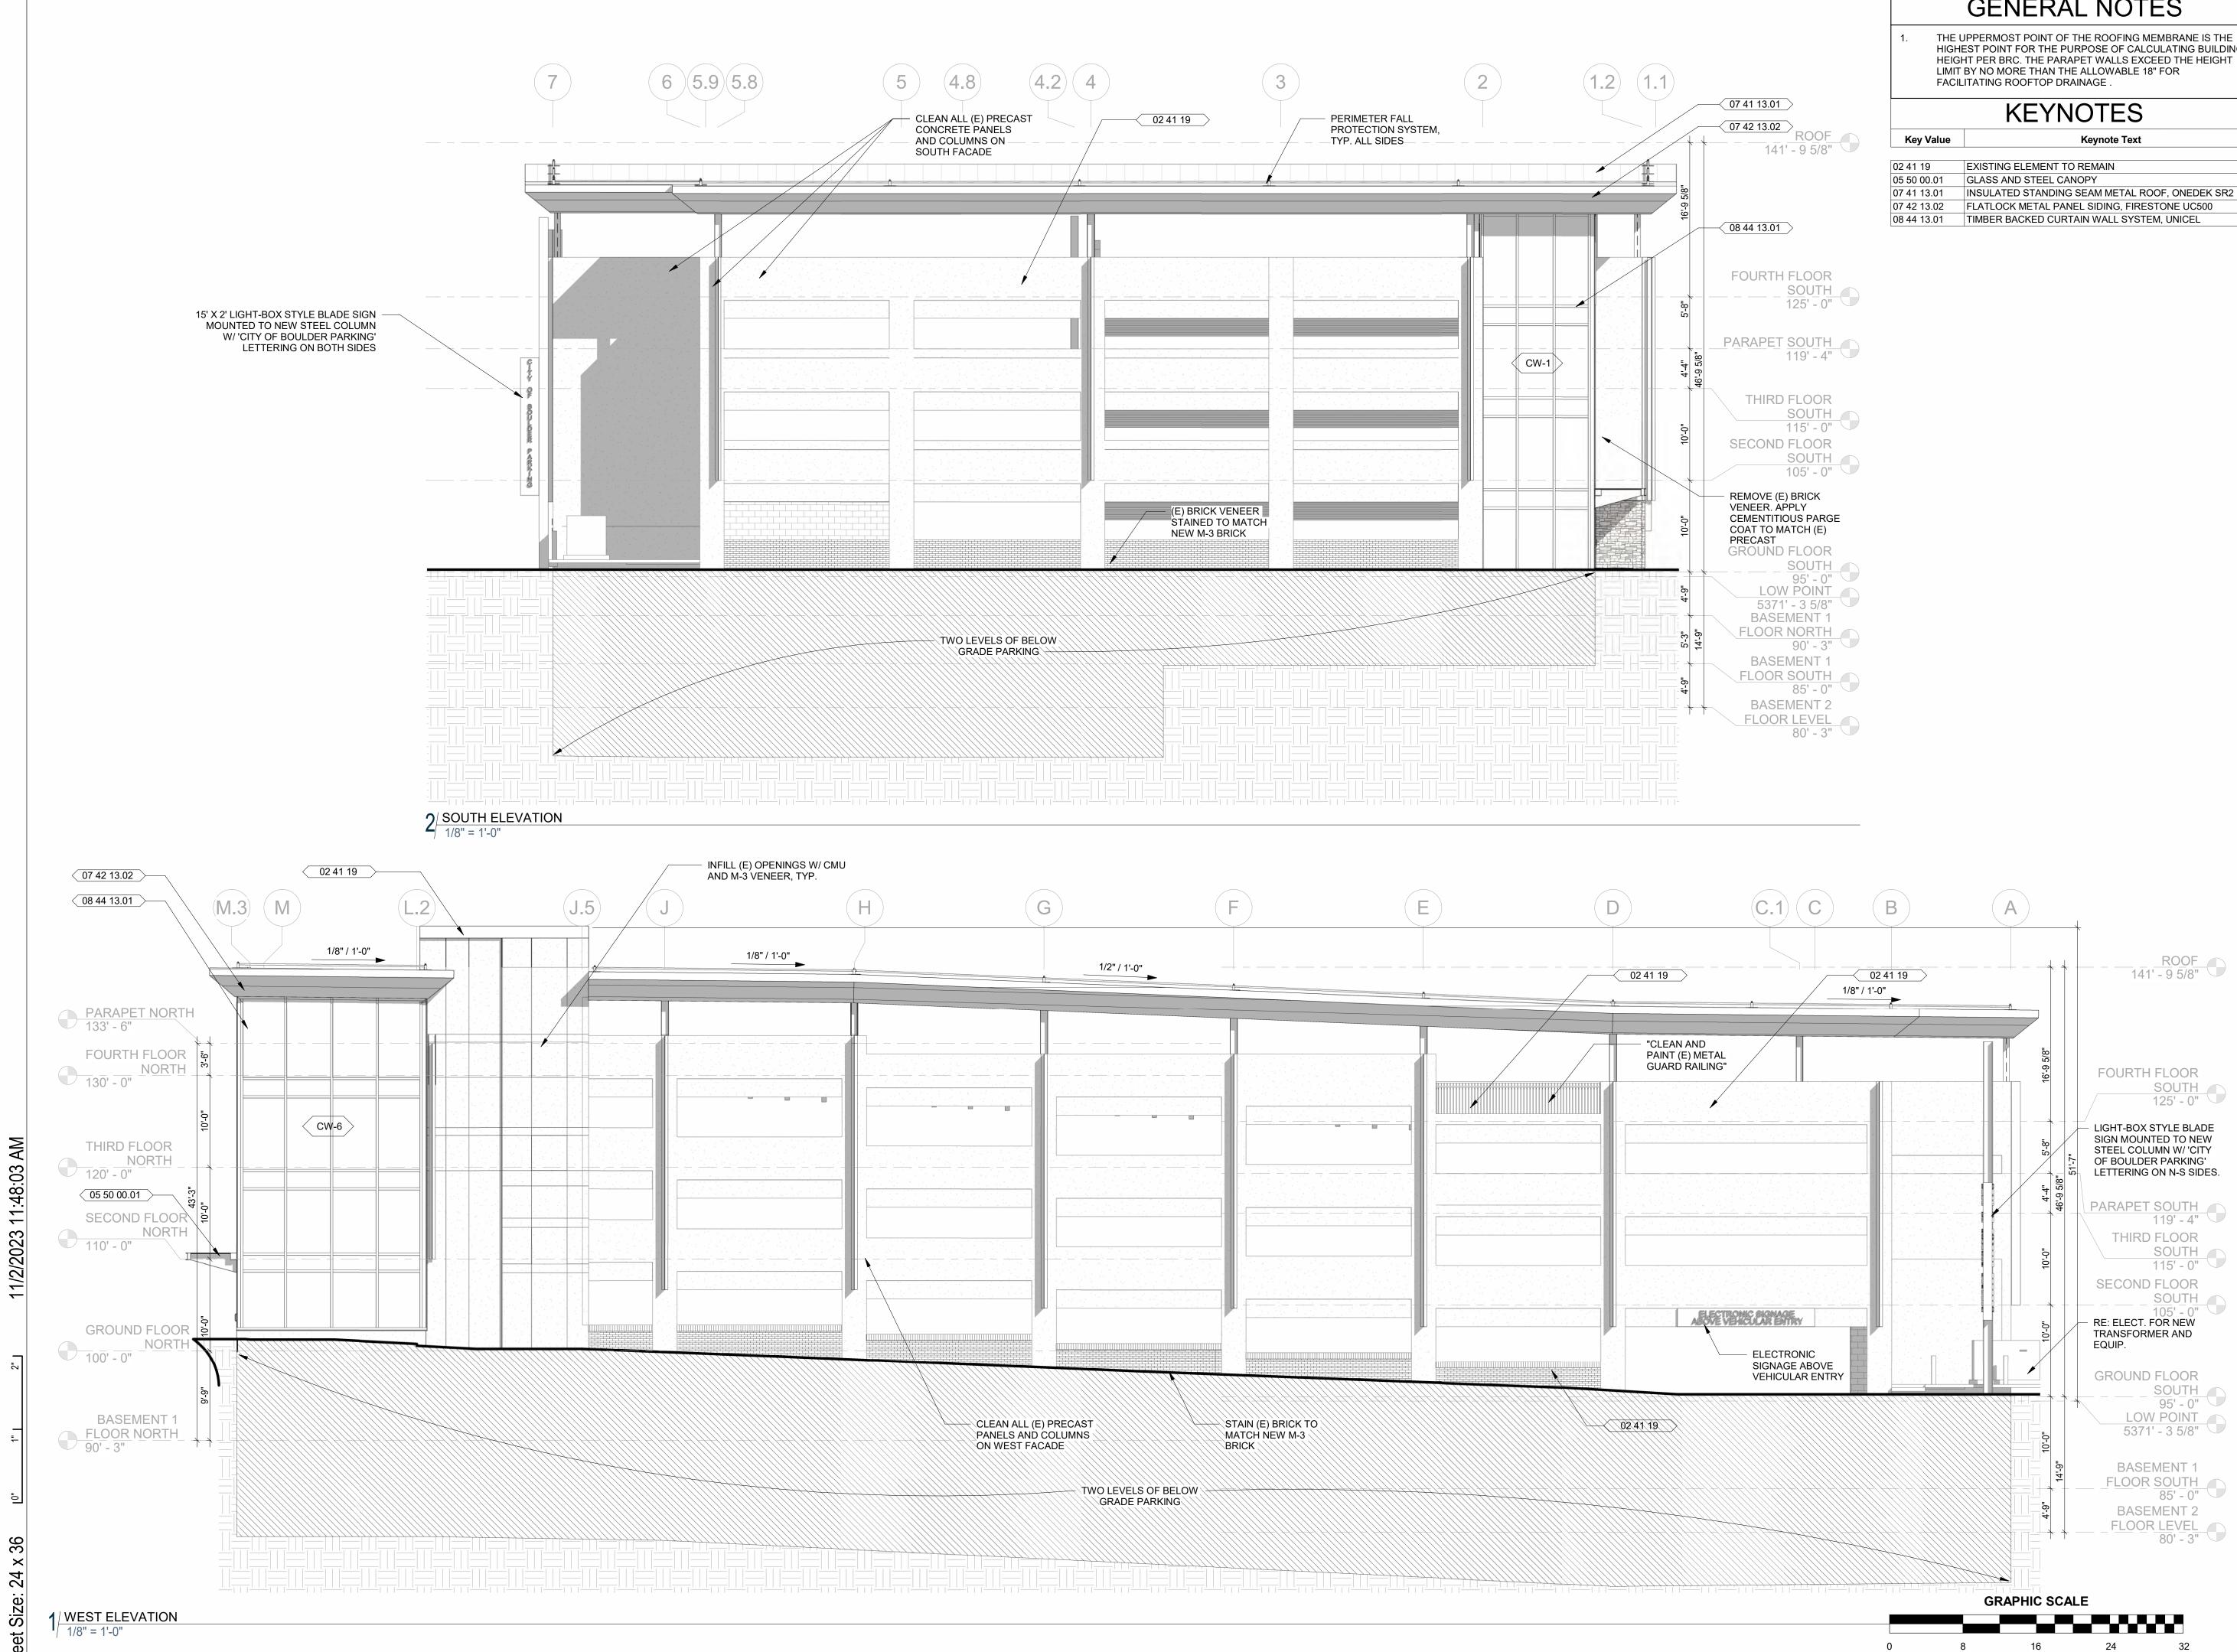
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# GENERAL NOTES

HIGHEST POINT FOR THE PURPOSE OF CALCULATING BUILDING HEIGHT PER BRC. THE PARAPET WALLS EXCEED THE HEIGHT

Keynote Text	

2 41 19	EXISTING ELEMENT TO REMAIN
5 50 00.01	GLASS AND STEEL CANOPY
7 41 13.01	INSULATED STANDING SEAM METAL ROOF, ONEDEK SR2
7 42 13.02	FLATLOCK METAL PANEL SIDING, FIRESTONE UC500
3 44 13.01	TIMBER BACKED CURTAIN WALL SYSTEM, UNICEL



ш

Consultant

CIVIL THE SANITAS GROUP 901 MAIN STREET, SUITE 350 LOUISVILLE, CO 80027 T 303 481 2170

LANDSCAPE STUDIO TERRA INC. 758 CLUB CIRCLE LOUISVILLE, CO 80027 T 303 494 9138

STRUCTURAL ANTHEM STRUCTURAL ENGINEERS FLATIRON OFFICE PARK 2213 CENTRAL AVENUE BOULDER, CO 80301 T 303 848 8497

MEP BRANCH PATTERN 3344 WALNUT STREET DENVER, CO 80205 T 303 382 1920

LIGHTING AE DESIGN 1900 WAZEE STREET, #205 DENVER, CO 80202 T 303 296 3034

AV/TECHNOLOGY/SECURITY SALAS O'BRIEN

4900 NAUTILUS CT. N. SUITE 200 BOULDER, CO 80301 T 303 865 5500

Full Design Team Roster on Sheet 1-G0.01

Client and Project Information



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> BUILDING ELEVATIONS



Current Issue SITE REVIEW

# $\succ$ ONL REFERENCE DAB FOR


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36


 $\times$ 24

Siz

eet

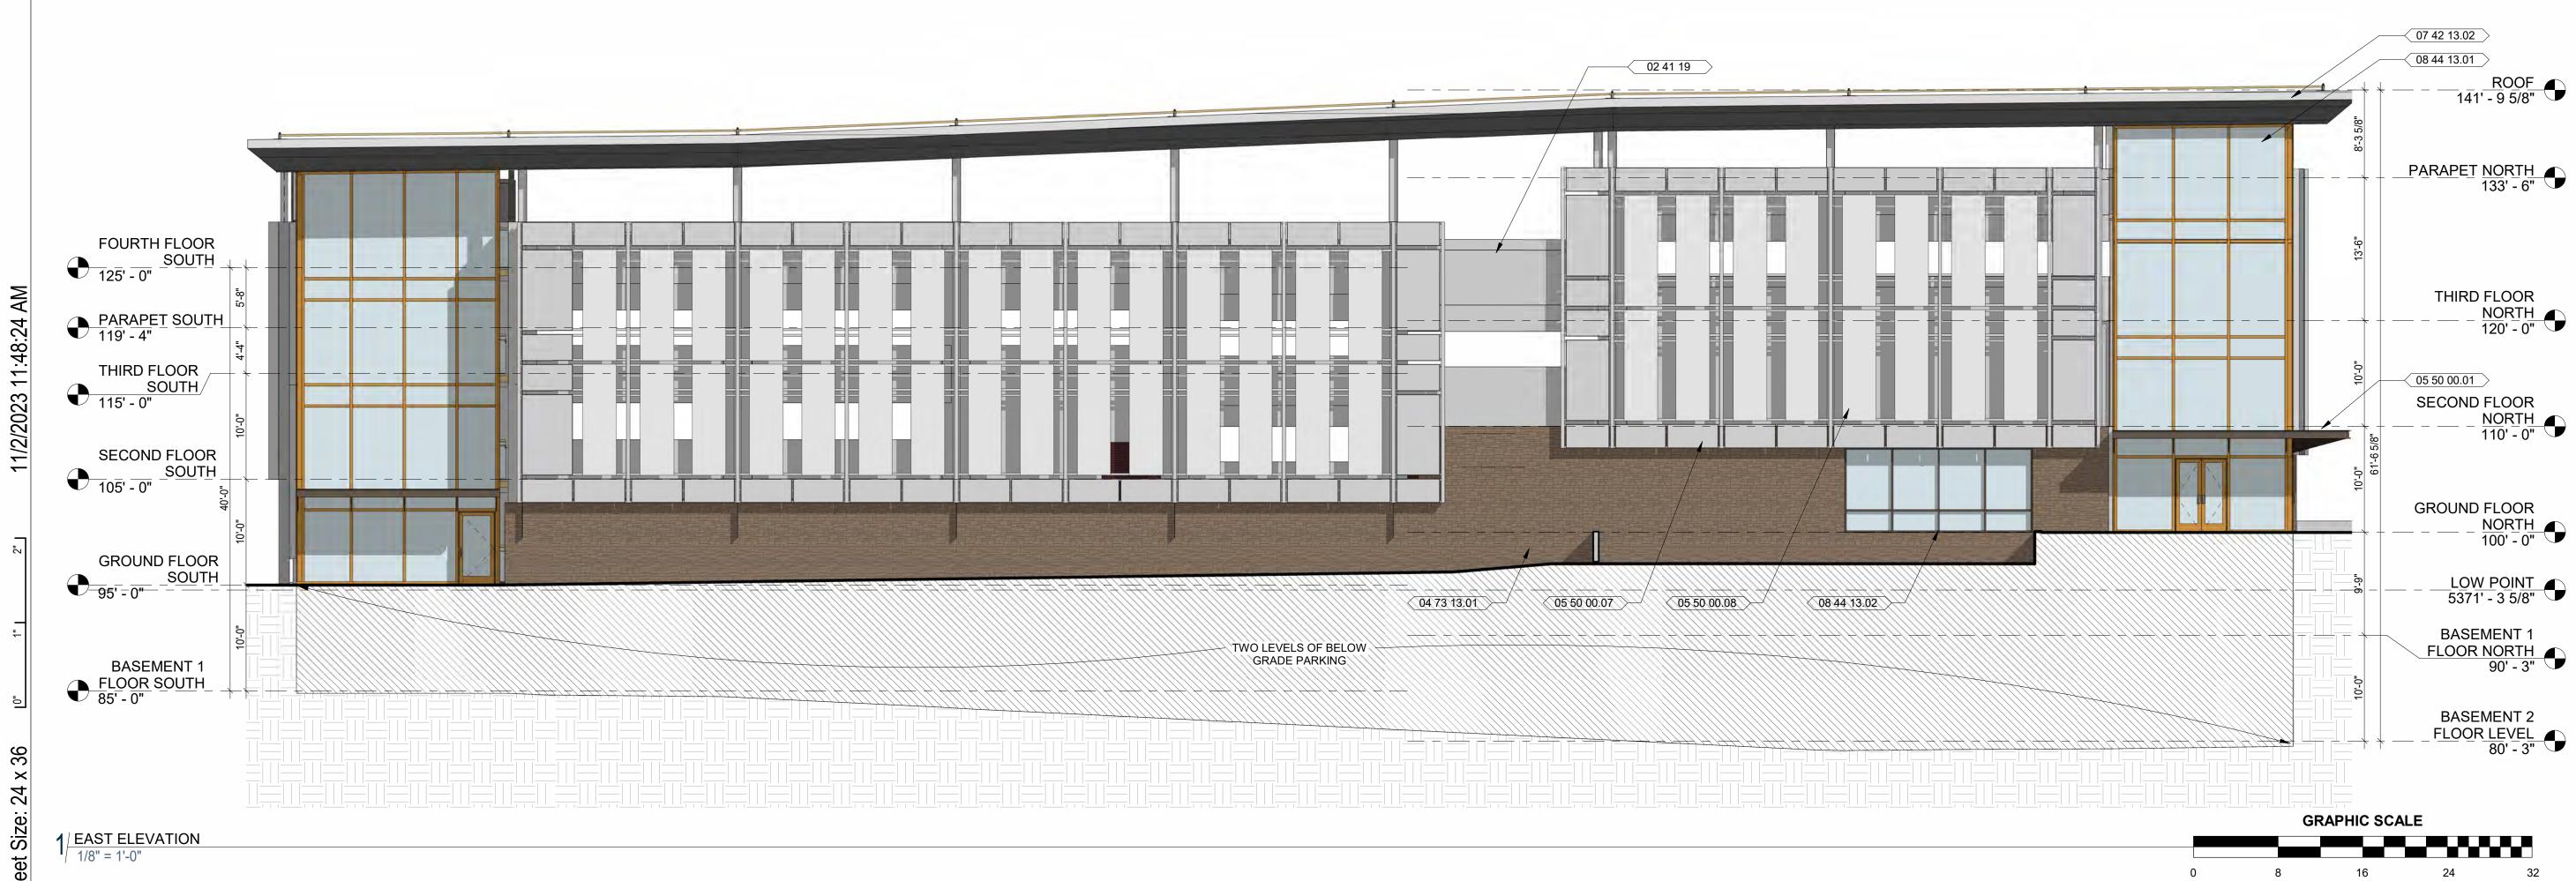

# 2 NORTH ELEVATION

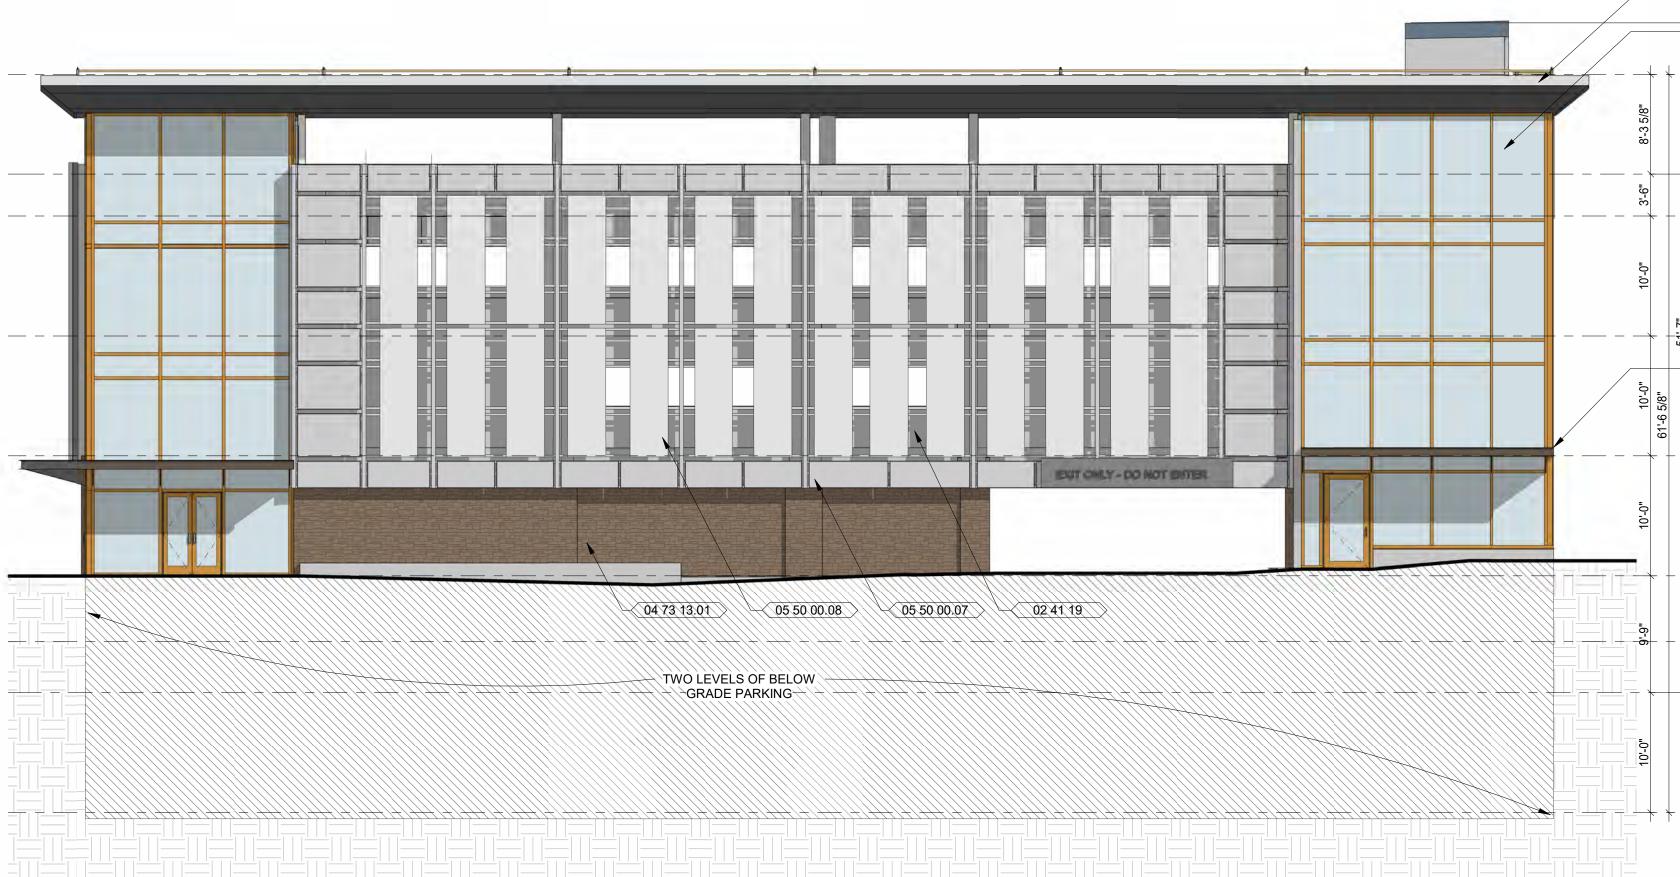

07 40 40 00	
$\prec$ 07 42 13.02	$\geq$

- 08 44 13.01 >

<u>ROOF</u> 141' - 9 5/8" PARAPET NORTH 133' - 6"	<b>9</b>
FOURTH FLOOR 	9

THIRD FLOOR - - - - <u>NORTH</u> 120' - 0" 08 44 13.01

SECOND FLOOR - <u>NORTH</u> 110' - 0"

GROUND FLOOR - <u>NORTH</u> 100' - 0"

LOW POINT 5371' - 3 5/8"

BASEMENT 1 FLOOR NORTH 90' - 3"

BASEMENT 2 \_FLOOR LEVEL 80' - 3"

RE THE UPPERMOST POINT OF THE ROOFING MEMBRANE IS THE by Ct, Suite 300A 80216 HIGHEST POINT FOR THE PURPOSE OF CALCULATING BUILDING HEIGHT PER BRC. THE PARAPET WALLS EXCEED THE HEIGHT 0 ă 5 4 **ST** 357 Den STUDIO Consultant CIVIL THE SANITAS GROUP 901 MAIN STREET, SUITE 350 LOUISVILLE, CO 80027 T 303 481 2170

GENERAL NOTES

**KEYNOTES** 

04 73 13.01 THIN SET MANUFACTURED STONE VENEER, COLOR SM1

07 42 13.02 FLATLOCK METAL PANEL SIDING, FIRESTONE UC500

08 44 13.01 TIMBER BACKED CURTAIN WALL SYSTEM, UNICEL

08 44 13.02 6" ALUMINUM STOREFRONT SYSTEM, UNICEL

Keynote Text

LIMIT BY NO MORE THAN THE ALLOWABLE 18" FOR

FACILITATING ROOFTOP DRAINAGE .

EXISTING ELEMENT TO REMAIN

05 50 00.07 PERFORATED METAL PANEL, PAINTED

05 50 00.01 GLASS AND STEEL CANOPY

05 50 00.08 METAL MESH SCREEN

Key Value

02 41 19

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MEP **BRANCH PATTERN** 3344 WALNUT STREET DENVER, CO 80205 T 303 382 1920

LIGHTING AE DESIGN 1900 WAZEE STREET, #205 DENVER, CO 80202 T 303 296 3034

AV/TECHNOLOGY/SECURITY SALAS O'BRIEN 4900 NAUTILUS CT. N. SUITE 200

BOULDER, CO 80301 T 303 865 5500 Full Design Team Roster on Sheet 1-G0.01

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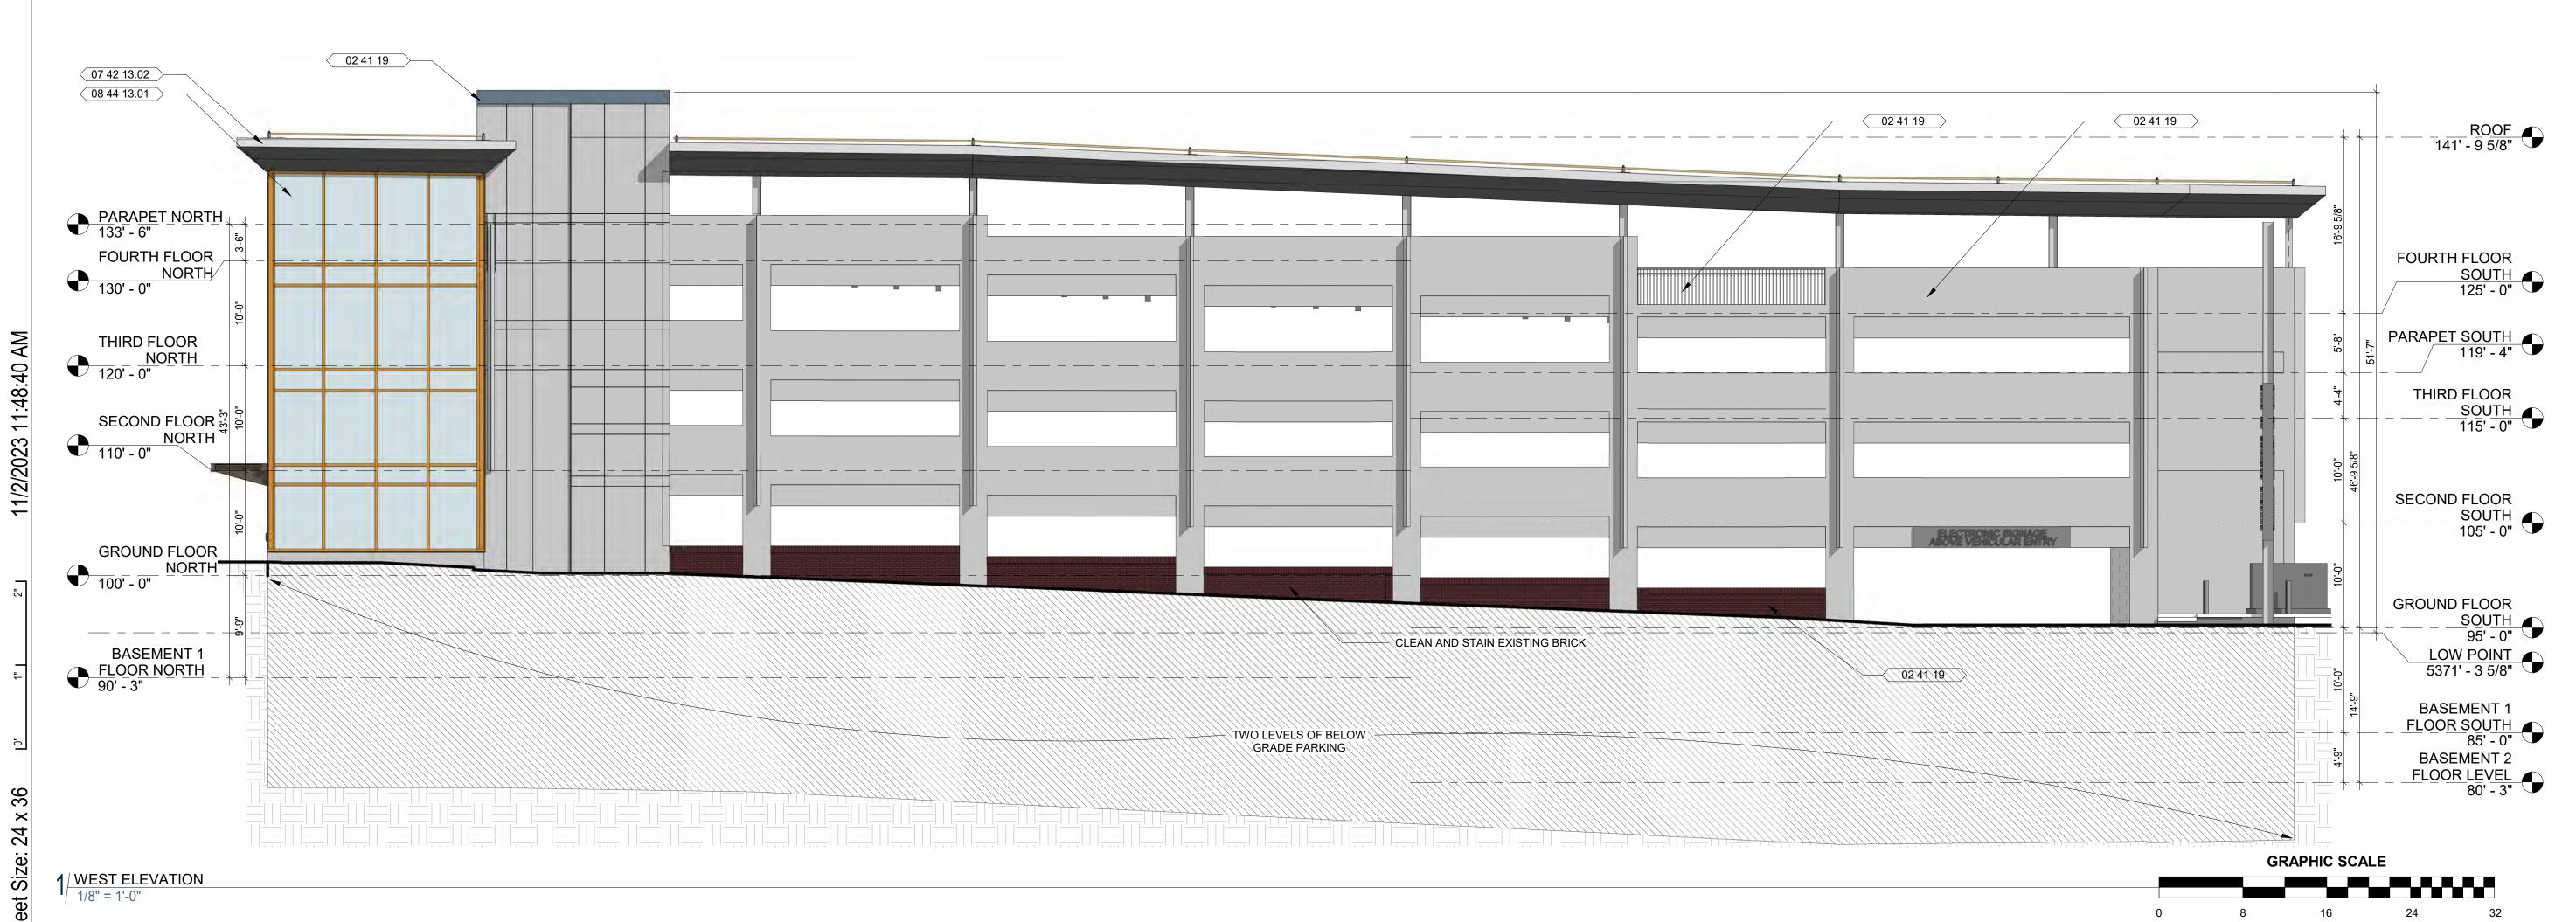
> COLORED ELEVATIONS

**2-A4.03** 


Current Issue SITE REVIEW

# $\succ$ **N**N REFERENCE AB $\square$ FOR

24



2 SOUTH ELEVATION 1/8" = 1'-0"

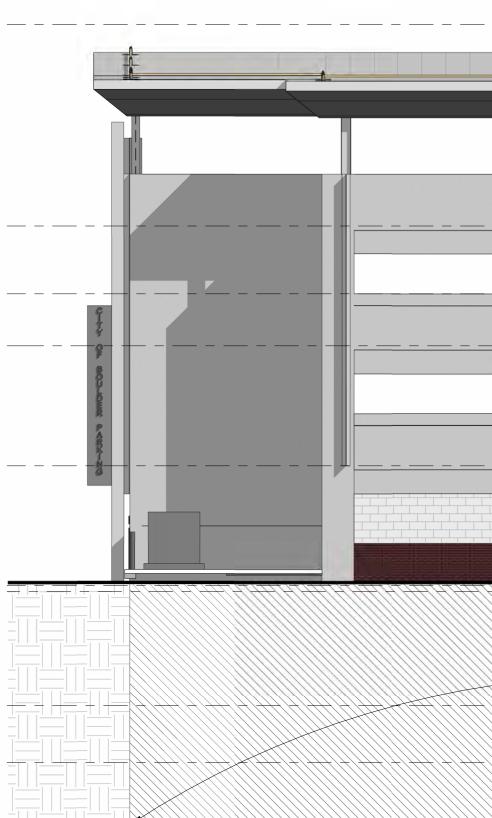


02 41 19	
	16:-9 5/8"
	4-4" 5'-8" 46'-9 5/8"
TWO LEVELS OF BELOW GRADE PARKING	4-9" 14'-9"


### 07 41 13.01

# 07 42 13.02

Key Value

08 44 13.01

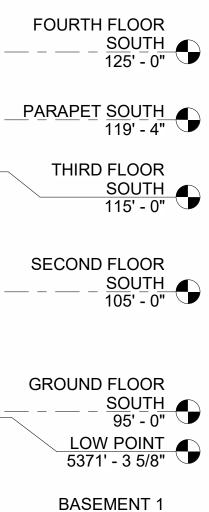

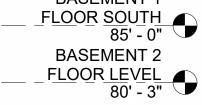

### **GENERAL NOTES** URE THE UPPERMOST POINT OF THE ROOFING MEMBRANE IS THE HIGHEST POINT FOR THE PURPOSE OF CALCULATING BUILDING by Ct, Suite 300A 80216 HEIGHT PER BRC. THE PARAPET WALLS EXCEED THE HEIGHT LIMIT BY NO MORE THAN THE ALLOWABLE 18" FOR FACILITATING ROOFTOP DRAINAGE . **KEYNOTES** Keynote Text UDIO 02 41 19 EXISTING ELEMENT TO REMAIN 07 41 13.01 INSULATED STANDING SEAM METAL ROOF, ONEDEK SR2 **ST** 357 357 Den 07 42 13.02 FLATLOCK METAL PANEL SIDING, FIRESTONE UC500 08 44 13.01 TIMBER BACKED CURTAIN WALL SYSTEM, UNICEL STUDIO Consultant CIVIL The sanitas group 901 MAIN STREET, SUITE 350 LOUISVILLE, CO 80027 T 303 481 2170 LANDSCAPE STUDIO TERRA INC. 758 CLUB CIRCLE LOUISVILLE, CO 80027 T 303 494 9138 STRUCTURAL ANTHEM STRUCTURAL ENGINEERS FLATIRON OFFICE PARK 2213 CENTRAL AVENUE BOULDER, CO 80301 T 303 848 8497 MEP **BRANCH PATTERN** 3344 WALNUT STREET DENVER, CO 80205 T 303 382 1920 LIGHTING AE DESIGN 1900 WAZEE STREET, #205 DENVER, CO 80202 T 303 296 3034 AV/TECHNOLOGY/SECURITY SALAS O'BRIEN 4900 NAUTILUS CT. N. SUITE 200 BOULDER, CO 80301 T 303 865 5500 Full Design Team Roster on Sheet 1-G0.01 Client and Project Information NURIA

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2-A4.04

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